

SBA TOWERS VI LLC 5900 BROKEN SOUND PKWY NW BOCA RATON, FL 33487 PHONE: 1-800-487-7483

SITE NUMBER: IL16128-B

SITE NAME: PEORIA 3

E911 ADDRESS: HALE AVE, PEORIA, IL 61614

PROPOSED 145' MONOPOLE TOWER WITH COMMUNICATION EQUIPMENT

ROAD NAME CHANGES TO IL-29 (16.8 MI). ROAD NAME CHANGES TO IL-17 / IL-29 / N RAILROAD ST (0.3 MI). KEEP STRAIGH

ONTO IL-29 / S RAILROAD ST (9.2 MI). KEEP STRAIGHT ONTO IL-29 S / S 4TH ST (7.0 MI). TURN RIGHT ONTO ROAD (0.1 MI).

TAKE RAMP RIGHT AND FOLLOW SIGNS FOR IL-6 SOUTH (3.7 MI). AT EXIT 6, TAKE RAMP RIGHT FOR IL-40 TOWARD

TURN RIGHT ONTO N HALE AVE (48 FT). ARRIVE AT 8627 N HALE AVE, PEORIA, IL 61615.

BRADFORD (1.0 MI). BEAR RIGHT ONTO IL-40 / N KNOXVILLE AVE (0.4 MI). TURN RIGHT TOWARD N HALE AVE (0.2 MI)

CHICAGO SMSA

d/b/a VERIZON WIRELESS

LOCATION NUMBER: 279503 SITE NAME: NORTH POINT PLAZA

MICHELLE MCIRVIN

309-693-4752



NOTE: UTILITY COORDINATION IS NOT FINALIZED.

DO NOT PROCEED WITH CONSTRUCTION UNTIL

POWER / TELCO / FIBER HAVE BEEN CONFIRMED

SHEET INDEX

DESCRIPTION


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			SHEET	DESCRIPTION	KE VISION	
VICINITY MAP	REGIONAL MAP	PROJECT INFORMATION	T-1 LP	TITLE SHEET LOCATION PLAN	1,2 1,2,3	
SITE LOCATION W MACTAVISH 80 W MACTAVISH 80 W MASSINGERY 80 W MASSINGERY 80	SITE LOCATION TO MOSSIVILE T	SITE NUMBER: IL16128-B SITE NAME: PEORIA 3 SITE ADDRESS: HALE AVE PEORIA, IL 61614 COUNTY: PEORIA LAND OWNER BRAD JOSEPH 5001 N UNIVERSITY PEORIA, IL 61614 309-692-1135 APPLICANT: SBA TOWERS VI, LLC 5900 BROKEN SOUND PKWY NW BOCA RATON, FL 33487 CONTACT PERSON: LAURA HALPENNY (630) 802-2357 LATITUDE: 40° 47' 32.21" (FROM 1A) LONGITUDE: 89° 36' 24.15" (FROM 1A) LAT/LONG TYPE: DEGREES MINUTES AND SECONDS GROUND ELEVATION: 794' CURRENT ZONING: COMMERCIAL PARCEL No.: 14-05-278-011	C-1 C-2,A C-3,A C-4 C-5 C-6 ANT-1 ANT-2 ANT-3 ANT-4 B-1 E-2 E-1 E-2 E-3 E-4 E-5 E-6 E-7 N-1 L-1	SITE PLAN SITE GRADING PLANS SITE GRADING PLANS SITE DETAILS & SPECIFICATIONS FENCE DETAILS FENCE DETAILS EQUIPMENT ENCLOSURE FOUNDATION PLAN SITE ELEVATION ANTENNA INFORMATION ANTENNA MOUNTING DETAILS ANTENNA MOUNTING DETAILS EQUIPMENT ENCLOSURE DETAILS EQUIPMENT ENCLOSURE ELEVATIONS UTILITY ROUTING PLAN SITE GROUNDING PLAN UTILITY DETAILS SINGLE LINE DIAGRAM & PANEL SCHEDULE ELECTRICAL AND GROUNDING DETAILS ELECTRICAL AND GROUNDING DETAILS LESSEE GROUNDING DETAILS GENERAL NOTES LANDSCAPE PLAN	1,2,3 1,2,4 2,4 1 1,4 4 1,2 1,2 1,2,4	
OPERATES 24 HOURS A DAY 365 DAYS A YEAR	DRIVING DIRECTIONS	SPECIAL NOTES	SS-1	SITE SURVEY		
Call Before FROM LESSEE OFFICE IN SCHAUMBURG, IL:		HANDICAPPED REQUIREMENTS :	UTILITY CONTACT INFORMATION			
You Dig FOR 1-290 EAST SOUTH TOWAL TAKE RAMP RI	DODFIELD RD TOWARD N PLAZA DR (0.6 MI). TURN RIGHT ONTO W FRONTAGE RD (0.5 MI). TAKE RAMP LEFT ST / IL-53 SOUTH TOWARD CHICAGO (4.5 MI). KEEP LEFT ONTO I-355 S (20.1 MI). TAKE RAMP RIGHT FOR I-55 ARD ST LOUIS (19.0 MI). AT EXIT 250B, TAKE RAMP RIGHT FOR I-80 WEST TOWARD IOWA (64.9 MI). AT EXIT 61, RIGHT FOR I-180 SOUTH TOWARD HENNEPIN (9.6 MI). TAKE RAMP RIGHT FOR II-29 S TOWARD PEORIA (1.7 MI). CHANGES TO II-20 (1.6 MI). POAD NAME CHANGES TO II-17 (1.29 LA) PAUL POAD ST (7.4 MI). PEER STRAIGHT	FACILITY IS UNMANNED AND NOT FOR HUMAN HABITATION HANDICAPPED ACCESS REQUIREMENTS NOT REQUIRED	POWER AMERE	R: FIBER: N ILLINOIS T.B.D.		

PLUMBING REQUIREMENTS:

FACILITY HAS NO PLUMBING





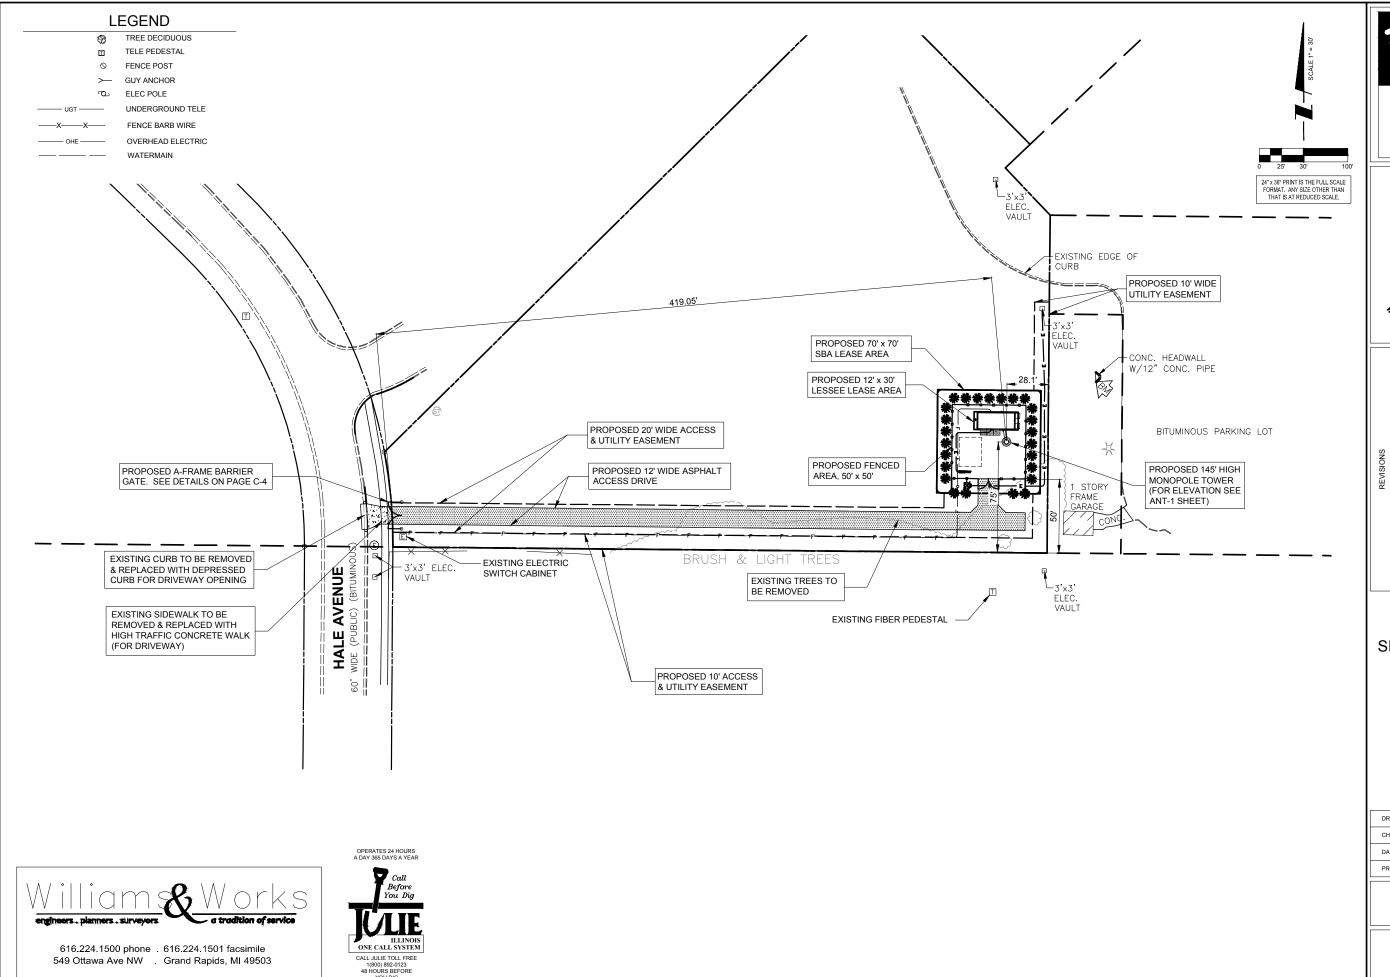

	REVISIONS	
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٠	ISSUED FOR REVIEW	02/25/15
- -	REVISED LEASE AREA	02/27/15
2.	UPDATE ACCESS DRIVE MATERIAL	03/11/15
ю.	UPDATE SBA LEASE AREA	03/25/15
4.	UPDATE PER CITY OF PEORIA COMMENTS	04/17/15

PEORIA 3


HALE AVE PEORIA, IL 61614


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SHEET TITLE

LOCATION PLAN





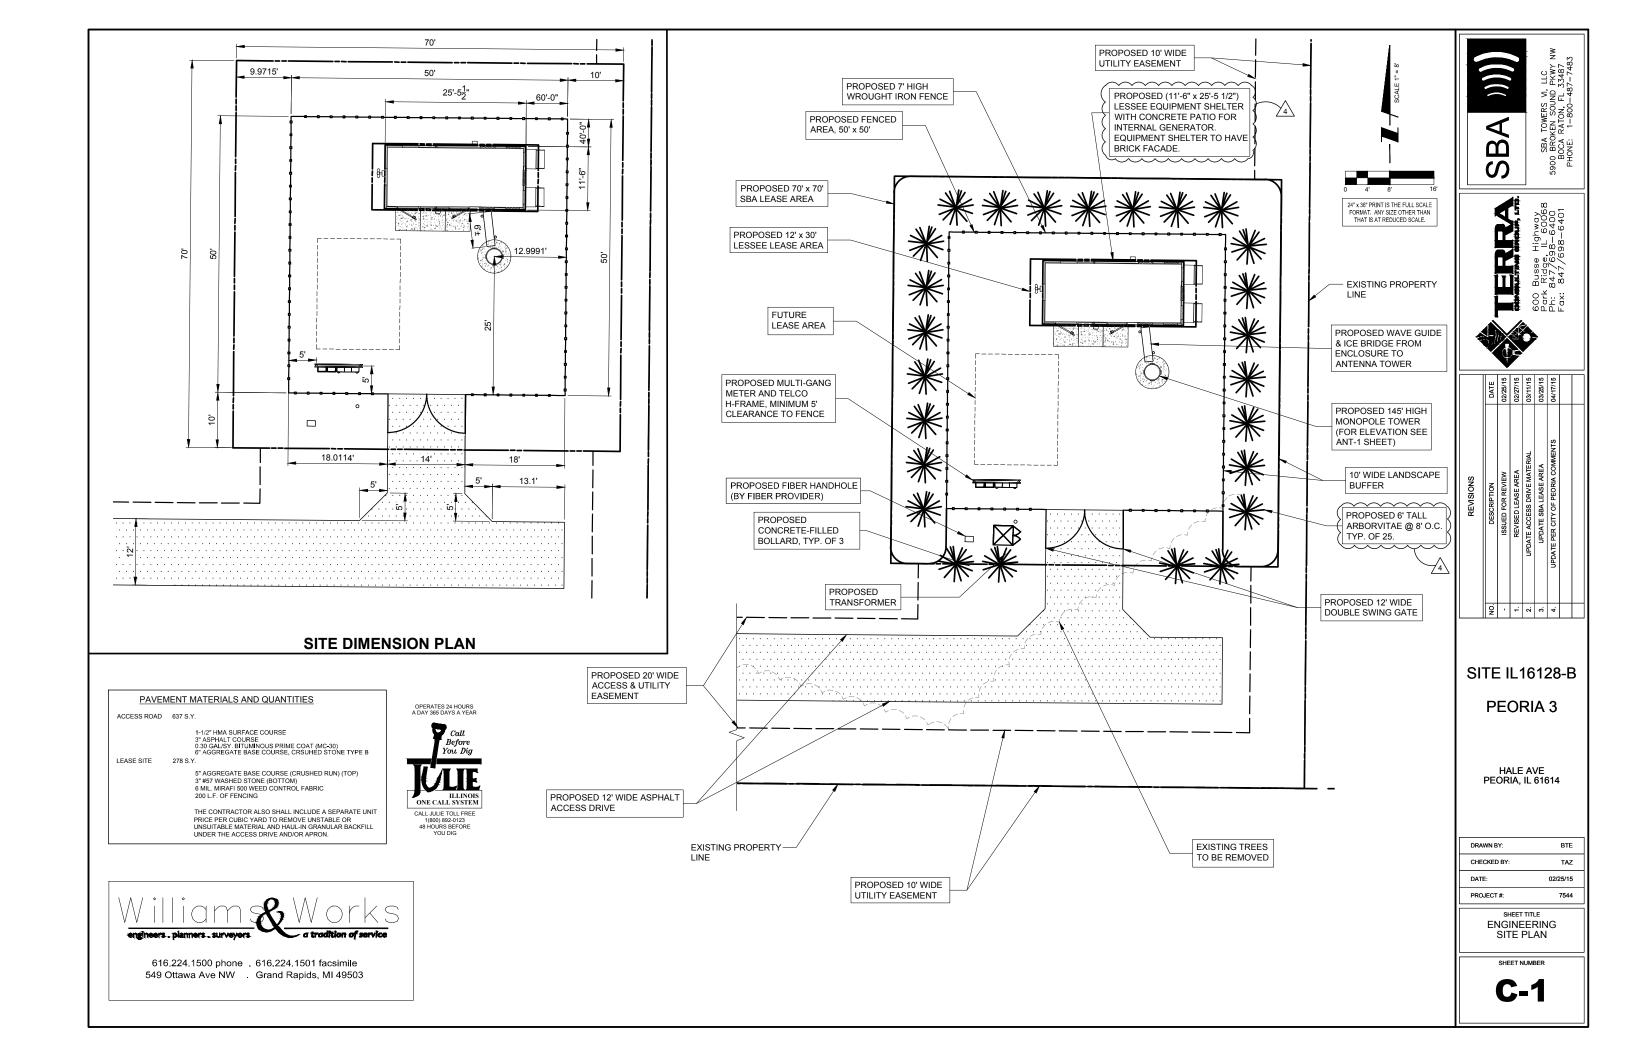

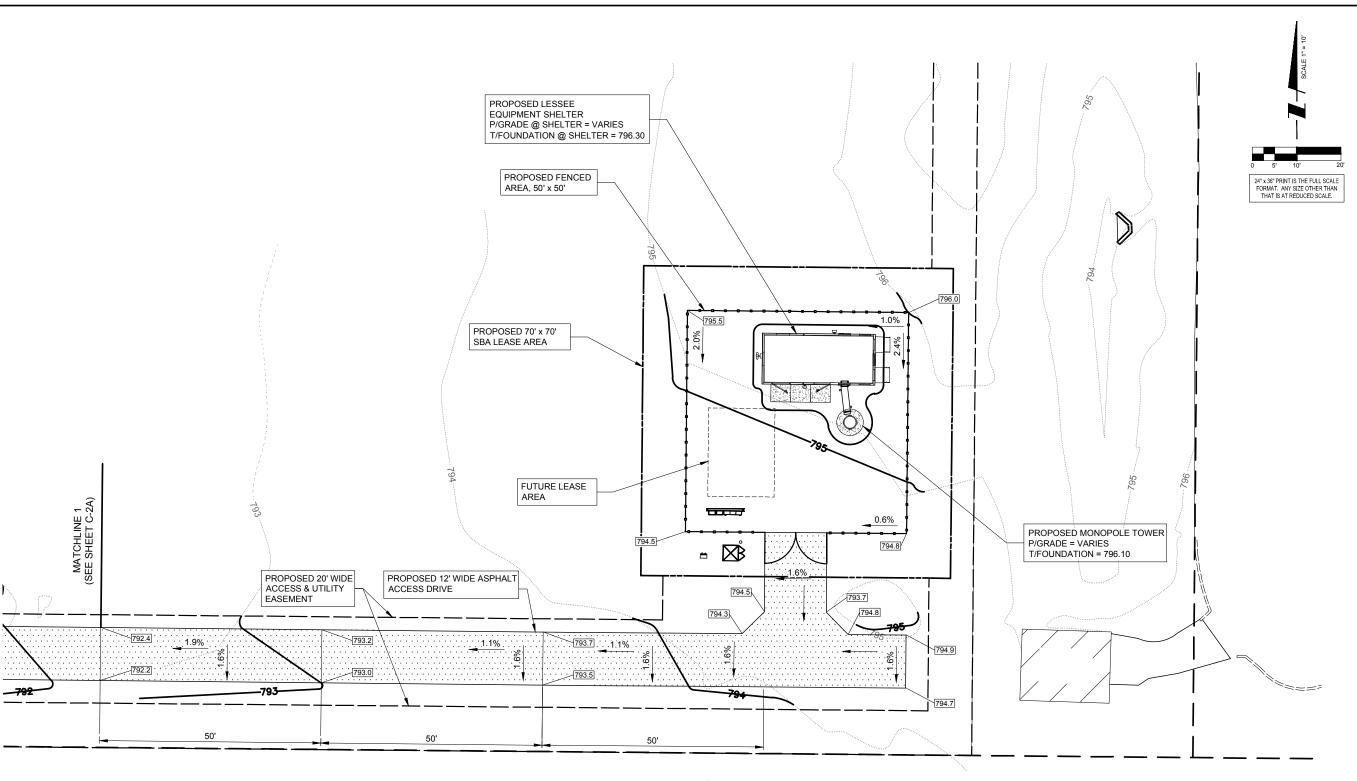



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SHEET TITLE

SITE GRADING PLAN


SHEET NUMBER

C-2



616.224.1500 phone 616.224.1501 facsimile 549 Ottawa Ave NW Grand Rapids, MI 49503

ILLINOIS ONE CALL SYSTEM CALL JULIE TOLL FREE 1(800) 892-0123 48 HOURS BEFORE YOU DIG

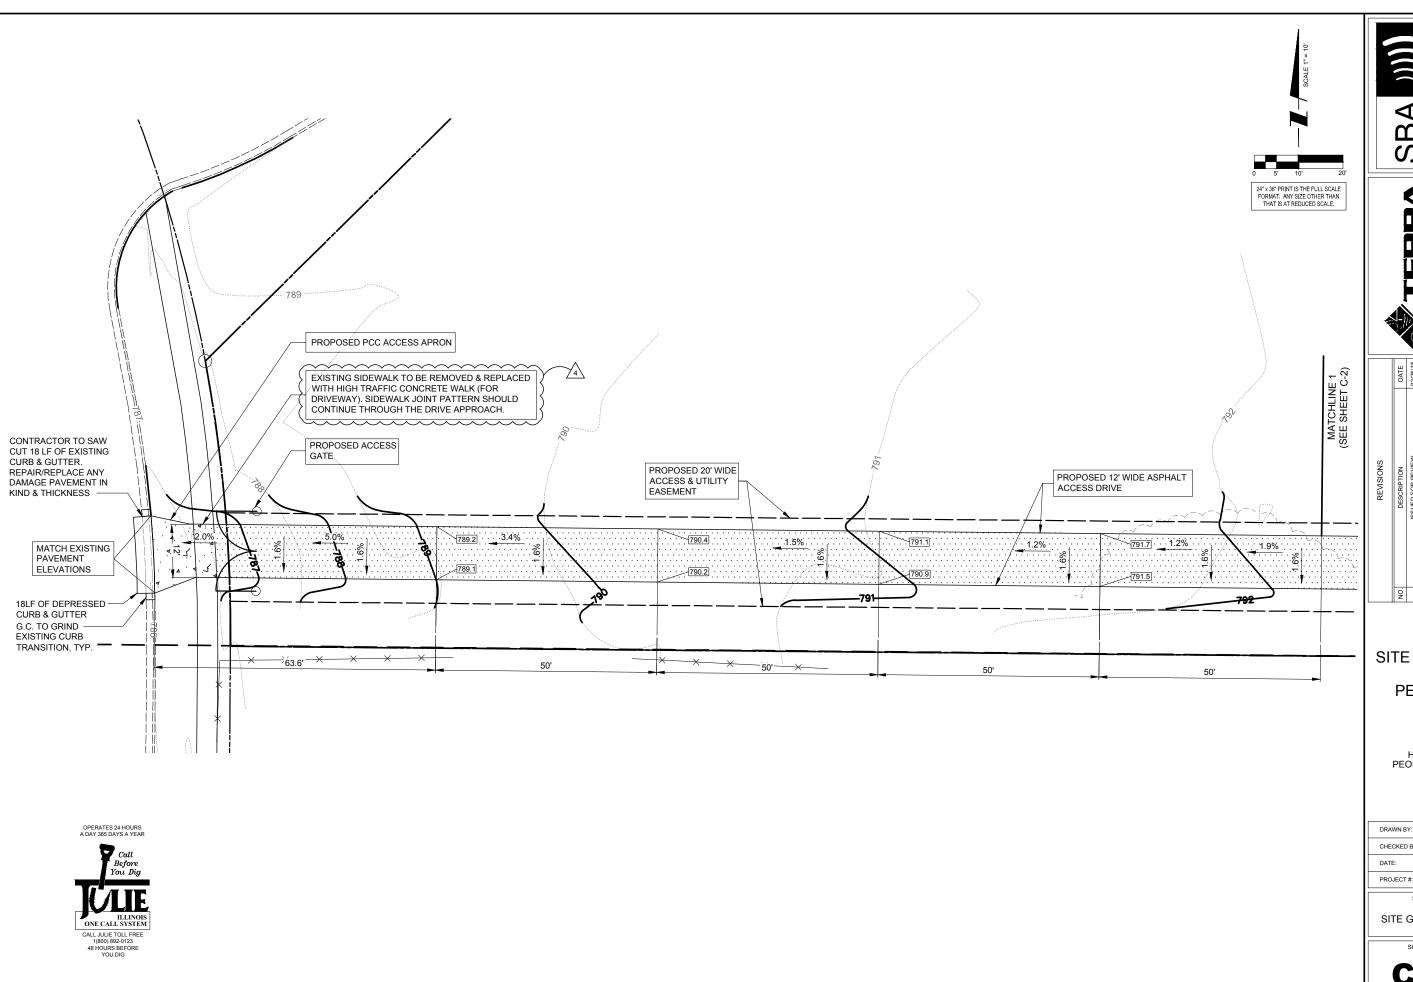





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SITE GRADING PLAN

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GENERAL NOTES AND CONDITIONS

- ALL EARTHWORK, GRADING AND PAVING SHALL BE PERFORMED IN ACCORDANCE WITH THE CURRENT STATE DEPARTMENT OF TRANSPORTATION STANDARDS FOR ROAD AND BRIDGE CONSTRUCTION.
- 2. THE CONTRACTOR SHALL KEEP CAREFUL MEASUREMENTS AND RECORDS OF ALL CONSTRUCTION AND SHALL FURNISH THE ENGINEER AND THE MUNICIPALITY WITH RECORD DRAWINGS UPON COMPLETION OF HIS WORK. ONE SET OF MYLAR-REPRODUCIBLE RECORD DRAWINGS AND COPIES MUST BE FURNISHED TO THE OWNER BY THE CONTRACTOR.
- 3 ALL WORK PERFORMED BY THE CONTRACTOR SHALL BE GUARANTEED BY ALL WORK PERFORMED BY THE CONTRACTOR SHALL BE GUARANTEE.

 THE CONTRACTOR FOR A PERIOD OF TWELVE (12) MONTHS FROM THE

 DATE OF FINAL ACCEPTANCE. THIS GUARANTEE SHALL INCLUDE ALL


 DEFECTS IN MATERIALS AND WORKMANSHIP.
- 4. ALL DIRT WILL BE DISPOSED OF OFFSITE BY THE CONTRACTOR.
- ALL STRUCTURES, INLETS, PIPES, SWALES AND ROADS MUST BE KEPT CLEAN AND FREE OF DIRT AND DEBRIS AT ALL TIMES.
- THE CONTRACTOR IS RESPONSIBLE FOR MAINTAINING ADEQUATE SIGNS, BARRICADES, FENCING, TRAFFIC CONTROL DEVICES AND MEASURES, AND ALL OTHER MEASURES THAT ARE NECESSARY TO PROTECT THE SAFETY OF THE SITE AT ALL TIMES.
- 7. THE CONTRACTOR, BY AGREEING TO PERFORM THE WORK, AGREES TO INDEMNIFY AND HOLD HARMLESS THE OWNER. THE ENGINEER, THE VILLAGE, AND ALLA GENTA SAND ASSIGNS OF THOSE PATIES, FROM ALL SUITS AND CLAIMS ARISING OUT OF THE PERFORMANCE OF SAID WORK, AND FURTHER AGREES TO DEFEND OR OTHERWISE PAY ALL LEGAL FEES ARISING OUT OF THE DEFENSE OF SAID PARTIES.
- EXISTING UTILITIES, IF ANY, ARE SHOWN AS A GUIDE ONLY. THE CONTRACTOR SHALL VERIFY THE LOCATION OF EXISTING UTILITIES PRIOR TO EXCAVATING ANYWHERE ON THE SITE.
- 10. ALL ADDENDA, IF ANY, MUST BE ACKNOWLEDGED WITH THE BID

EARTHWORK, GRADING, AND PAVING


- ALL PROPOSED PAVEMENT AREAS SHALL BE STRIPPED OF ALL TOPSOIL
 AND UNSUITABLE MATERIAL AND EXCAVATED OR FILLED TO WITHIN 0.10
 FEET OF DESIGN SUBGRADE.
- THE SUBGRADE SHALL BE FREE OF ALL UNSUITABLE MATERIAL AND SHALL BE COMPACTED TO A MINIMUM 95 PER CENT OF MODIFIED SHALL BE COMPACTE PROCTOR DENSITY.
- 3. THE QUANTITIES CONTAINED IN THESE DOCUMENTS ARE APPROXIMATE AND ESTIMATED, AND ARE PRESENTED AS A GUIDE TO THE CONTRACTOR IN DETERMINING ALL QUANTITIES AND TO BECOME FAMILIAR WITH THE SITE AND SOIL CONDITIONS.
- THE EARTHWORK CONTRACTOR IS RESPONSIBLE FOR MAINTAINING POSITIVE DRAINAGE AT THE CONCLUSION OF EACH WORKING DAY.
- THE PAVING CONTRACTOR IS RESPONSIBLE FOR THE FINAL SUBGRADE PREPARATION, THE PAVEMENT BASE, BINDER, AND SURFACE, AND ALL FINAL CLEAN-UP AND RELATED WORK ASSOCIATED WITH THE PAVING OPERATION.
- 6. UPON COMPLETION OF THE PAVING , THE CONTRACTOR WILL ENSURE THAT POSITIVE DRAINAGE EXISTS ADJACENT TO ALL CONSTRUCTED IMPROVMENTS.

SOIL EROSION AND SEDIMENT CONTROL

- REASONABLE CARE MUST BE TAKEN TO MINIMIZE SOIL EROSION.
 REFER TO PROCEDURES AND STANDARDS FOR URBAN SOIL EROSION AND
 SEDIMENTATION CONTROL PREPARED BY THE U.S. SOIL AND
 CONSERVATION SERVICE.
- ALL INLETS, STRUCTURES, PIPES, SWALES, AND ROADS SHALL BE KEPT CLEAN AND FREE OF DIRT AND SILT.
- 3. STOCKPILES SHALL HAVE A BERM OR TRENCH AROUND THE CIRCUMFERENCE TO CONTROL SILT IF NEEDED. IF THE STOCKPILE IS TO REMAIN FOR MORE THAN NINE MONTHS, IT MUST HAVE SUFFICIENT VEGETATION TO CONTROL BOTH WATER AND WIND EROSION.
- STRAW BALES FIRMLY ANCHORED SHALL BE PLACED AROUND ALL INLETS, CATCHBASINS, AND SWALES THAT RECEIVE SILTY RUNOFF DURING THE COURSE OF CONSTRUCTION
- SILT FENCE TO BE CONSTRUCTED ALONG THE DOWN SLOPE OF THE CONSTRUCTION AREA.
- MAINTAIN SOIL EROSION CONTROL DEVICES THROUGH THE DURATION OF THIS PROJECT.
- REPLACE SOIL EROSION CONTROL DEVICES WITH SOD AND TOPSOIL AT THE COMPLETION OF THE PROJECT.
- 8. ALL ADJACENT ROADWAYS SHALL BE KEPT CLEAN AT ALL TIMES.
- ADDITIONAL SOIL EROSION CONTROL MEASURES SHALL BE UNDERTAKEN
 IF DEEMED NECESSARY BY THE ENGINEERING INSPECTOR DURING THE COURSE OF CONSTRUCTION.

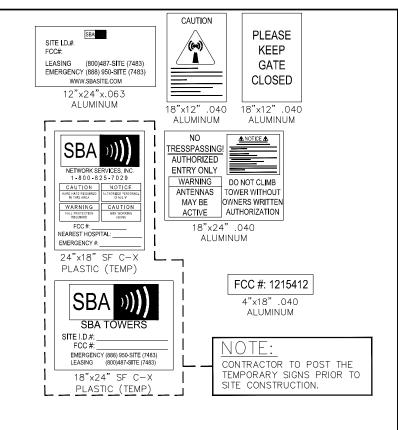

SIGN DETAIL

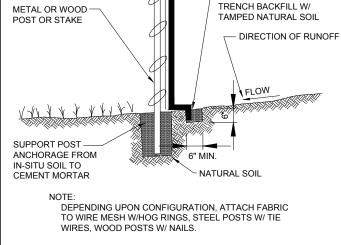



TYPICAL SILT FENCE DETAIL


GEOTEXTILE


FABRIC ANCHORAGE


WIRE MESH REINFORCEMENT-

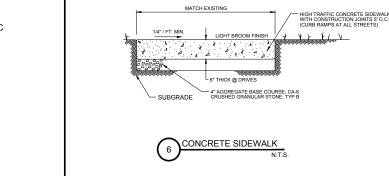

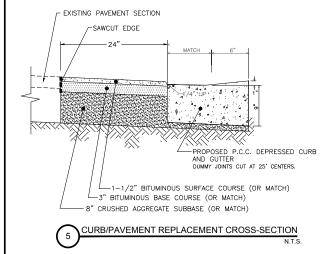

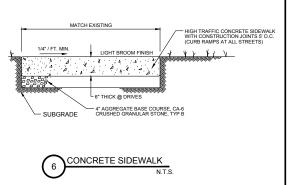

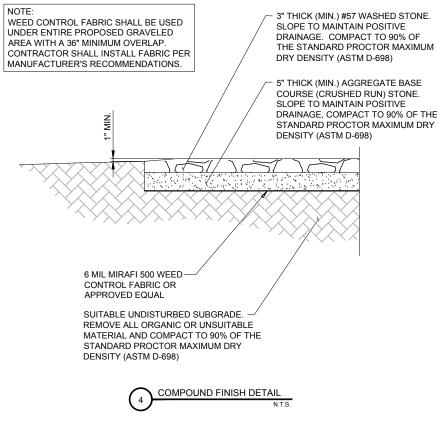

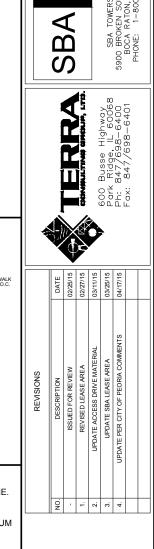

SITE IL16128-B


PEORIA 3

HALE AVE PEORIA, IL 61614


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SHEET TITLE SITE DETAILS & SPECIFICATIONS

SHEET NUMBER

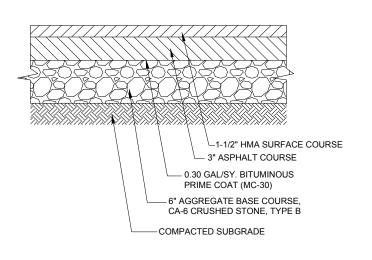

BITUMINOUS ROAD SECTION



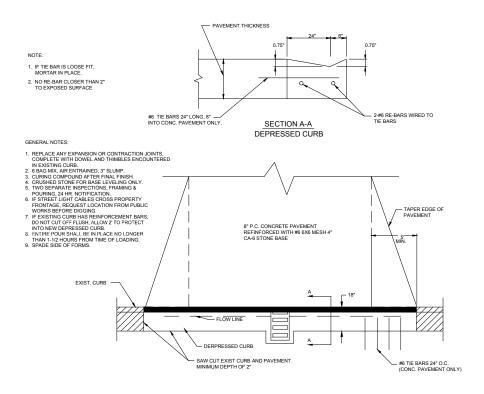





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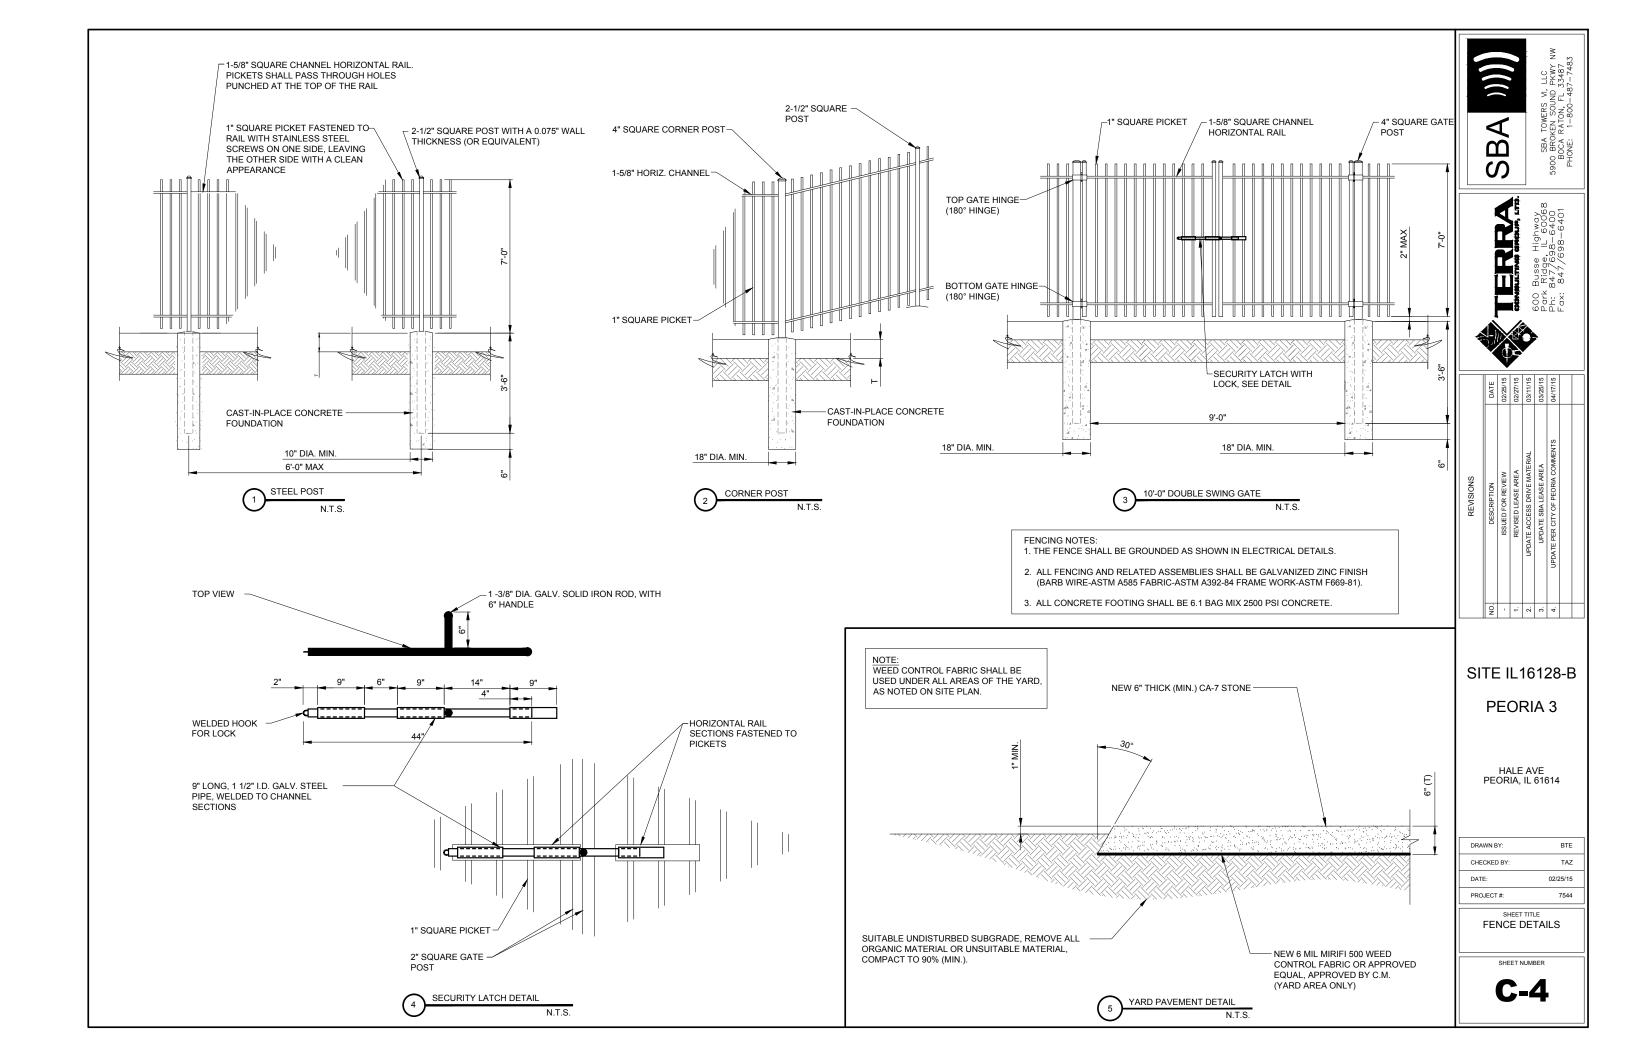
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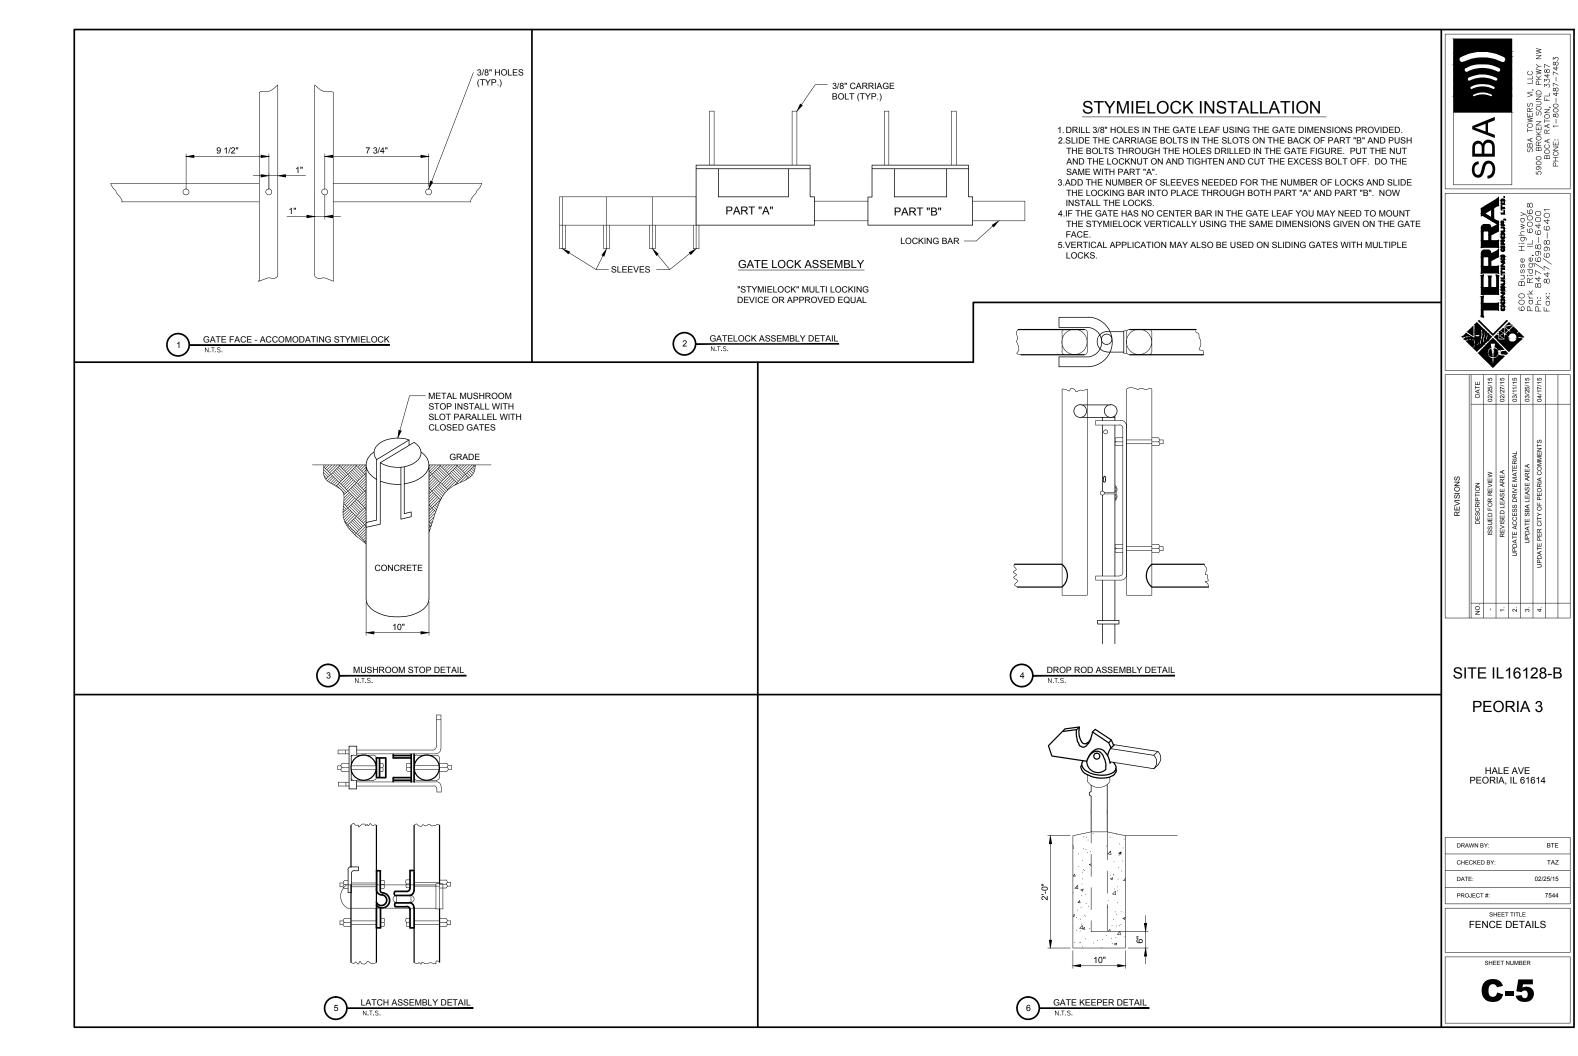
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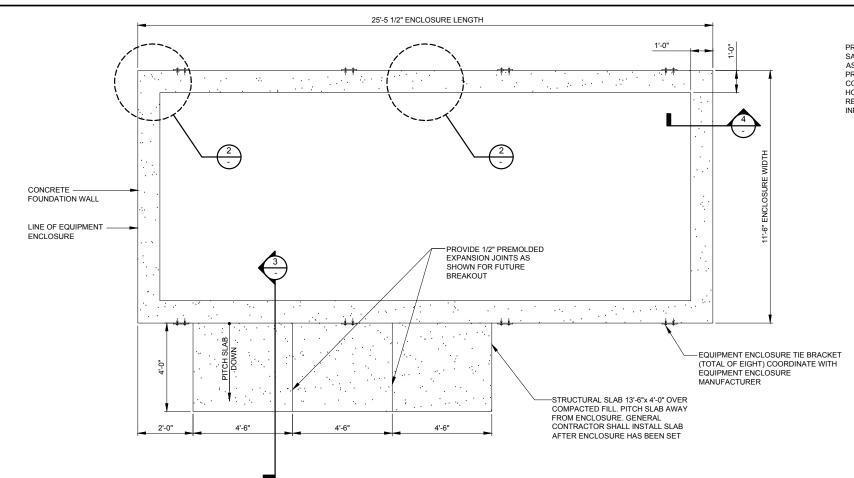
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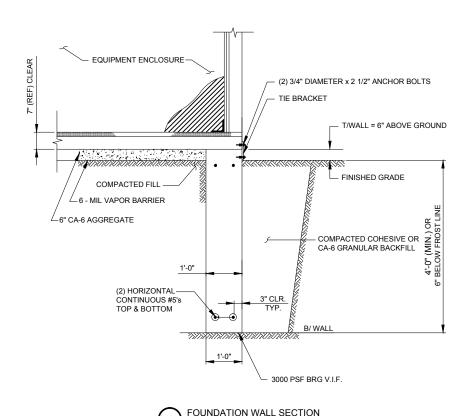
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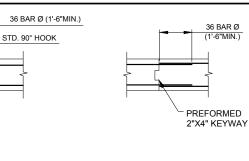


EQUIPMENT ENCLOSURE FOUNDATION PLAN



LOCALIZED AREAS OF SOFT OR LOOSE MATERIALS MAY BE ENCOUNTERED AT THE PROPOSED BEARING ELEVATION. THE SOILS MAY REQUIRE COMPACTION USING A PLATE COMPACTOR IN THE FOOTING TRENCH IF FIELD CONDITIONS INDICATE LOOSE GRANULAR SOILS. THE SOILS MAY REQUIRE REMOVAL AND REPLACEMENT WITH AN APPROVED ENGINEERED FILL. FOUNDATION DEPTH AND OVER DIG REQUIREMENTS SHALL BE VERIFIED WITH THE RECOMMENDATIONS OF THE GEOTECHNICAL REPORT AND INCLUDED IN THE BID BEFORE CONSTRUCTION. THE EVALUATION OF THE SUB GRADE AND SELECTION OF FILL MATERIALS SHALL BE MONITORED AND TESTED BY A QUALIFIED REPRESENTATIVE OF THE SOILS ENGINEER.


PROVIDE CORNER BARS
SAME SIZE AND SPACING
AS HORIZONTAL BARS.
PROVIDE #5 @12" AT
CORNERS WHEN NO
HORIZONTAL
REINFORCEMENT IS
INDICATED.





CONSTRUCTION JOINT

2 CONCRETE WALL REINFORCEMENT DETAILS N.T.S.

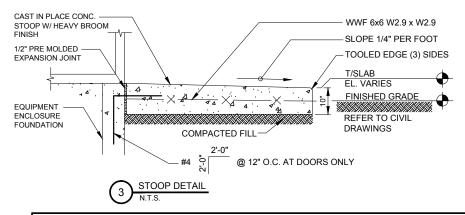

A. EQUIPMENT ENCLOSURE FOUNDATION

- 1. REFER TO CIVIL DRAWINGS FOR ORIENTATION OF THE FOUNDATIONS.
- EQUIPMENT ENCLOSURE FOUNDATION IS DESIGNED FOR THE FOLLOWING LOADS: ENCLOSURE DEAD LOAD: 70,000 LBS. ROOF LIVE LOAD: 30 PSF FLOOR LIVE LOAD: 125 PSF
- THE CONTRACTOR SHALL NOTIFY THE CLIENT'S GEOTECHNICAL ENGINEER TO COORDINATE HAVING A FIELD REPRESENTATIVE ON SITE FOR TESTING AND INSPECTION.
- 4. FOOTINGS SHALL BEAR ON VIRGIN SOIL OR COMPACTED FILL MATERIAL CAPABLE OF SUPPORTING A MINIMUM SOIL BEARING PRESSURE OF 3000 PSF.
- 5. SUBGRADE PREPARATION
- A. REMOVE ALL SOILS CONTAINING TOPSOIL: ORGANIC MATERIALS, AND/OR FILL MATERIALS FROM WITHIN AREA OF ENCLOSURE FOUNDATION.
- B. PROOF ROLL RESULTING SUBGRADE WITH A HEAVILY LOADED SINGLE AXLE ROLLER OR SIMILAR VEHICLE. (20 TON LOAD). CONTRACTOR SHALL UNDERCUT AND REPLACE WITH ENGINEERED FILL. ALL LOOSE SOFT OR UNSTABLE AREAS REVEALED DURING PROFROLLING AS DIRECTED BY THE TESTING AGENCY. CONTRACTOR SHALL INCLUDE ANTICIPATED UNDERCUT AND REPLACEMENT AS INDICATED IN THE GEOTECHNICAL REPORT AS PART OF THE BID.
- C. BACKFILL AND COMPACT THE AREA WITHIN THE BUILDING FOUNDATION. BETWEEN RESULTANT SUBGRADE AND FOUNDATION WALL WITH APPROVED GRANULAR MATERIAL.
- 6. FOUNDATION WALLS SHALL BE BACKFILLED EVENLY ON EACH SIDE OF THE WALL OR WALLS SHALL BE ADEQUATELY BRACED BY THE CONTRACTOR UNTIL FLOOR SLAB HAS BEEN PLACED AND CURED FOR 72 HOURS MINIMUM.
- 7. ENCLOSURE SHALL NOT BE SET UNTIL FLOOR SLAB HAS BEEN CURED FOR 72 HOURS MINIMUM.
- 8. CONTRACTOR TO ENSURE FOUNDATION / SLAB ARE POURED TO MEET FLATNESS LEVEL TOLERANCES AS INDICATED IN ACI 4.5.6 AND 4.5.7.

B. EQUIPMENT ENCLOSURE

THE EQUIPMENT ENCLOSURE IS A PRE-FABRICATED BUILDING MANUFACTURED BY FIBREBOND, MINDEN. LOUISIANA.

THE EQUIPMENT ENCLOSURE BUILDING SHALL BE FURNISHED AND INSTALLED BY THE OWNER UNDER SEPARATE CONTRACT PER THE OWNER AND MANUFACTURER SPECIFICATIONS.

C. CONCRETE NOTES

- 1. ALL CONCRETE WORK SHALL CONFORM TO THE REQUIREMENTS OF ACI 318 AND ACI 301, LATEST EDITION. THESE DOCUMENTS SHALL BE AVAILABLE IN THE FIELD OFFICE.
- 2. EXCEPT WHERE OTHERWISE INDICATED, CONCRETE SHALL BE NORMAL WEIGHT AND WITH MINIMUM 28-DAY COMPRESSIVE STRENGTHS OF F'c=4000 PSI. ALL EXTERIOR EXPOSED CONCRETE SHALL BE ABLE ENTRAINED.
- 3. REINFORCING BARS SHALL CONFORM TO ASTM A615, GRADE 60. ALL WELDED WIRE FABRIC SHALL CONFORM TO ASTM A185.





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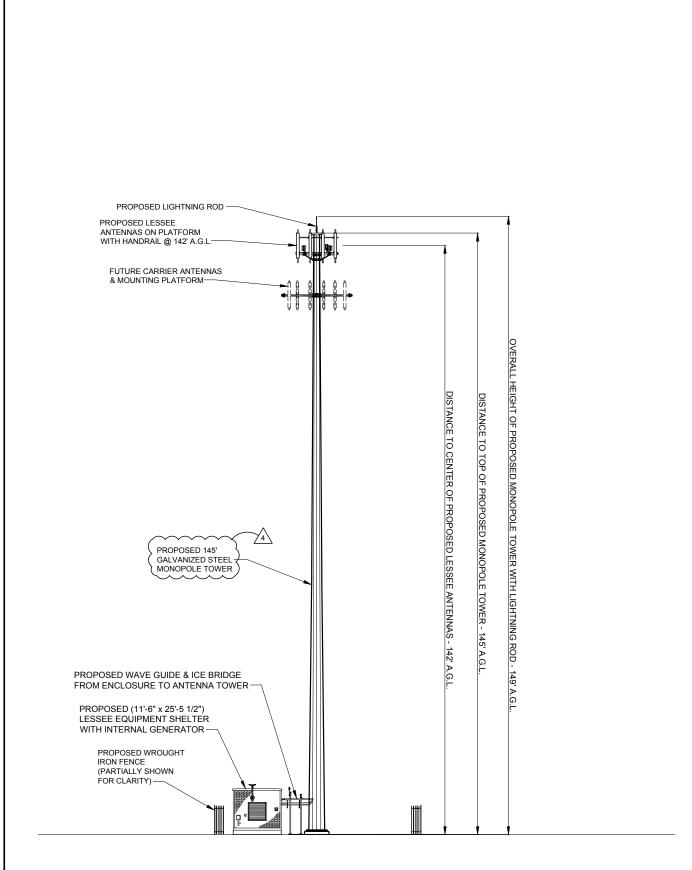
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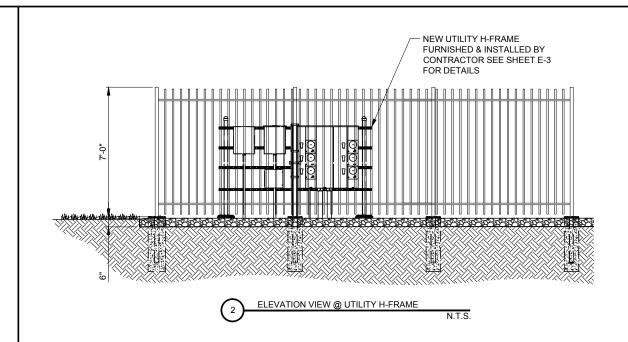
EQUIPMENT ENCLOSURE FOUNDATION PLAN

SHEET NUMBER

C-6



1 WEST ELEVATION
SCALE: 3/32" = 1'-0"







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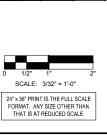
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SHEET TITLE
ANTENNA
ELEVATION

SHEET NUMBER

ANT-1



EQUIPMENT CHANGE REQUEST FORM- ECR

		•	<u> </u>		
Cell Name	North Point Plaza			Cell ID	51
Location Number	279503	RF Engineer	Matthew From	Address	8627 N Hale
Date of Request	4/17/2015	Market	Springfield	City/State/Zip	Peoria, IL, 61615
	<u> </u>	DDUDUSED CONI	IGUPATION	Configuration	Ontion-A2

				PROPOSED CONFIGURA	TION			Config	guration	Op	tion-A2
		Antei	nna			Antenna Serial				Mechanical	
Sector	Pos	Port	RF Path	Antenna Manufacturer	Antenna Model	Number	Centerline	Azimuth	Variable Tilt	Tilt	Action
		L1 (-45)	LTE 850 - RxTx0						4		
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	^'	H1 (-45)	Unused at this time	AWFILITOL	CW WAOBSAZSAGO		142	"	0	Ů	Add-IIIstaii
		H2 (+45)	Unused at this time								
		L1 (-45)	Unused at this time								
	A2	L2 (+45)	Unused at this time								
	A2	H1 (-45)	Unused at this time								
		H2 (+45)	Unused at this time								
~		L1 (-45)	LTE C - RxTx0								
Alpha	АЗ	L2 (+45)	LTE C - RxTx1						4		
늘	AS	H1 (-45)	AWS - Rx2	1	CHANNO CON OCCUPANTO						
4		H2 (+45)	AWS - Rx3	AMPHENOL	CWWX063X25X00		142	0	1	0	Add-Install
		H1 (-45)	Unused at this time						_		
		H2 (+45)	Unused at this time						0		
		L1 (-45)	LTE C - Rx2								
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		H1 (-45)	AWS - RxTx0	1							
	A4	H2 (+45)	AWS - RxTx1	AMPHENOL	CWWX063X25X00		142	0	1	0	Add-Install
		H1 (-45)	Unused at this time								
		H2 (+45)	Unused at this time	1					0		
		L1 (-45)									
			LTE 850 - RxTx0	-					3		
	B1	L2 (+45)	LTE 850 - RxTx1	AMPHENOL	CWWX085X25X00		142	120		0	Add-Install
		H1 (-45)	Unused at this time	4					0		
		H2 (+45)	Unused at this time								
		L1 (-45)	Unused at this time								
	B2	L2 (+45)	Unused at this time								
		H1 (-45)	Unused at this time	4							
		H2 (+45)	Unused at this time								
~		L1 (-45)	LTE C - RxTx0						3		
Beta		L2 (+45)	LTE C - RxTx1								
Ď	В3	H1 (-45)	AWS - Rx2	AMPHENOL	CWWX063X25X00		142	120	1	0	Add-Install
		H2 (+45)	AWS - Rx3								
		H1 (-45)	Unused at this time						0		
		H2 (+45)	Unused at this time								
		L1 (-45)	LTE C - Rx2						3		
		L2 (+45)	LTE C - Rx3	1							
	В4	H1 (-45)	AWS - RxTx0	AMPHENOL	CWWX063X25X00		142	120	1	0	Add-Install
	-	H2 (+45)	AWS - RxTx1							-	
		H1 (-45)	Unused at this time						0		
		H2 (+45)	Unused at this time								
		L1 (-45)	LTE 850 - RxTx0								
		L2 (+45)	LTE 850 - RXTX1	1					6		
	G1	H1 (-45)	Unused at this time	AMPHENOL	CWWX085X25X00		142	240		0	Add-Install
		H2 (+45)	Unused at this time						0		
		L1 (-45)	Unused at this time	1							
		L2 (+45)	Unused at this time	1							
	G2	H1 (-45)									
		H2 (+45)	Unused at this time	1							
∢	<u> </u>	L1 (-45)	Unused at this time	1					-		
È		L1 (-45) L2 (+45)	LTE C - RxTx0	-					6		
GAMMA			LTE C - RxTx1	-							
Ϋ́	G3	H1 (-45)	AWS - Rx2	AMPHENOL	CWWX063X25X00		142	240	1	0	Add-Install
9		H2 (+45)	AWS - Rx3	4							
		H1 (-45)	Unused at this time	-					0		
		H2 (+45)	Unused at this time								

Comments

CWWX063X25X00

142

240

1

0

Add-Install

AMPHENOL

L1 (-45) LTE C - Rx2 L2 (+45) LTE C - Rx3

H1 (-45) AWS - RxTx0

H2 (+45) AWS - RxTx1
H1 (-45) Unused at this time

H2 (+45) Unused at this time


PPC CONNECTORS ONLY


	PROPOSED ANTENNA CONFIGURATION	
٠,	NTS	

	ESTIMATED MAIN LINE	HYBRID LENGTH	
ANTENNA CENTERLINE (±)	ICE BRIDGE LENGTH (±)	SHELTER (±)	TOTAL (±)
142'	6'	15'	163'

	Location	Manufacturer	Comt	onent Model	Count	Action
	Top (Platform)	Andrew		F-8-DCB (Diplexer)	6	Install
	Top (Platform)	Westell		TTMA-700C-VG	6	Install
3	Top (Platform)	Ericsson	RRL	JS 12 - AWS	3	Install
U	Top (Platform)	Ericsson		A2	3	Install
5	Top (Platform)					
i	Top (Platform)					
,	Top (Platform)					
2	Top (Platform)					
,	Top (Platform)					
rassive components	Top (Platform)	Raycap	RCME	C-3315-PF-48	1	Install
	Bottom (Shelter)	Andrew	CBC78-DI	F-8-DCB (Diplexer)	6	Install
	Bottom (Shelter)					
	Bottom (Shelter)	Raycap	RCME	C-3315-PF-48	1	Install
	Sector	Coax Manufacturer	Туре	Size	Count	Action
	Alpha	ANDREW	LDF7-50A	15/8	4	Install
	Beta	ANDREW	LDF7-50A	15/8	4	Install
			IDEZ COA	15/9	4	Install
ç	Alpha ANDREW LDF7-50A 1 5/8 4 Install Beta ANDREW LDF7-50A 1 5/8 4 Install Gamma ANDREW LDF7-50A 1 5/8 4 Install					
Coax	Gamma	ANDREW	HFT1206- 24S26- XXX	1	1	Install

2 COMBINER CABLE DATA INFORMATION N.T.S.

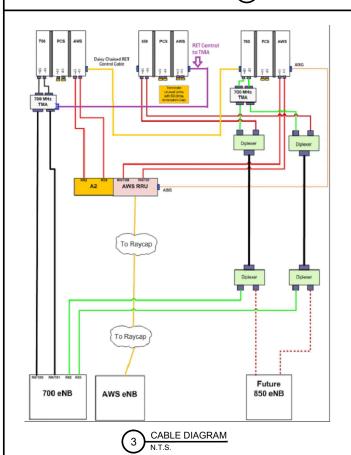

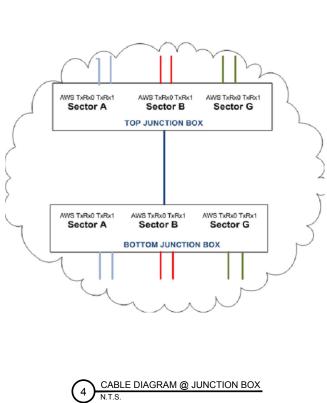





	Ľ	8	8	03	03	2	
REVISIONS	DESCRIPTION	ISSUED FOR REVIEW	REVISED LEASE AREA	UPDATE ACCESS DRIVE MATERIAL	UPDATE SBA LEASE AREA	UPDATE PER CITY OF PEORIA COMMENTS	
	Š.	Ľ.	-	2.	3.	4	


SITE IL16128-B


PEORIA 3


HALE AVE PEORIA, IL 61614


- 1		
	DRAWN BY:	BTE
	CHECKED BY:	TAZ
	DATE:	02/25/15
	PROJECT #:	7544

SHEET TITLE
ANTENNA INFORMATION

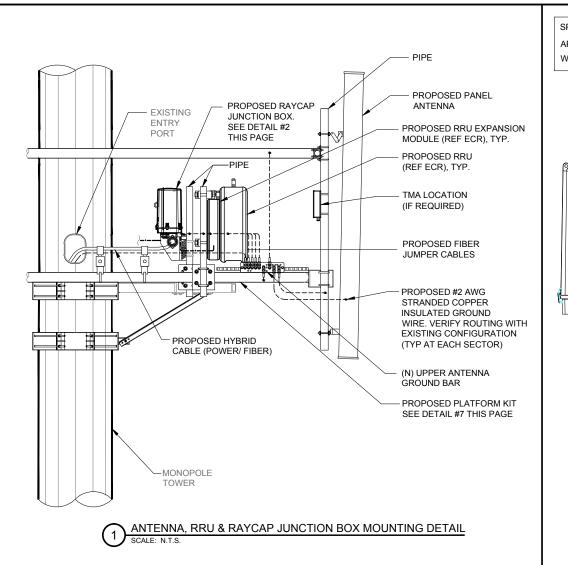


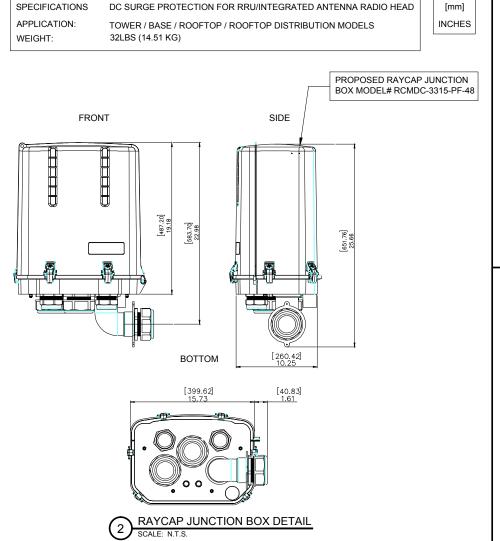


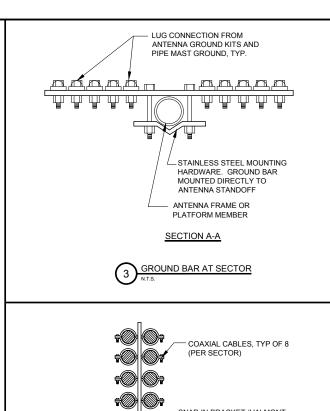

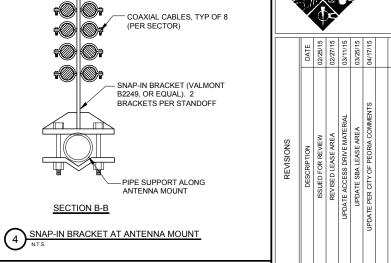

SBA

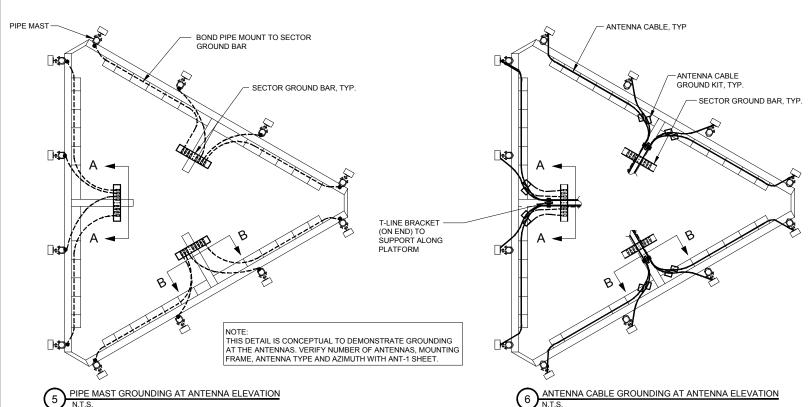

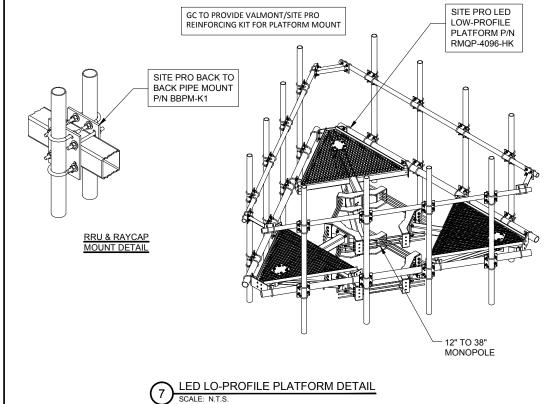

HALE AVE PEORIA, IL 61614

SITE IL16128-B


PEORIA 3


ı	DRAWN BY:	BTE
ı	CHECKED BY:	TAZ
ı	DATE:	02/25/15
ı	PROJECT #:	7544
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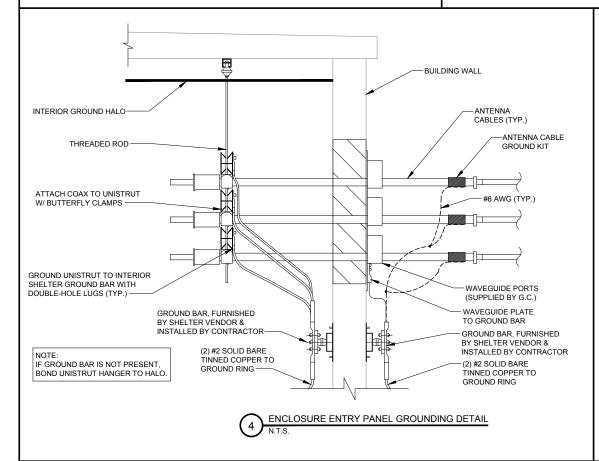
SHEET TITLE
ANTENNA
MOUNTING
DETAILS

SHEET NUMBER


ANT-3



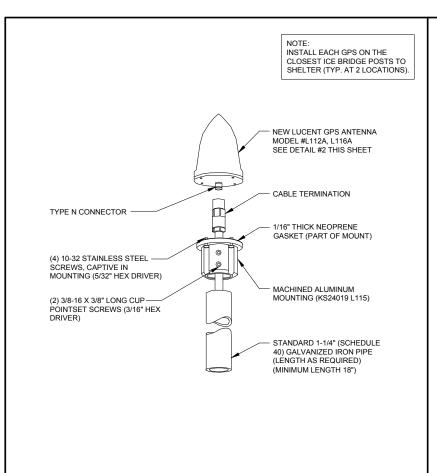

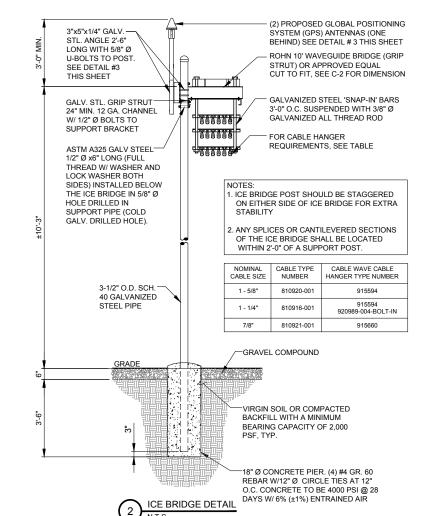

TYPICAL GPS DETAIL

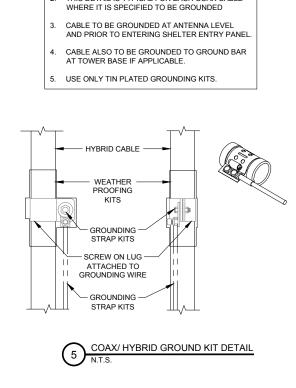


NOTES:


1. DO NOT INSTALL CABLE GROUND KIT AT A BEND

2. THIS DETAIL IS TYPICAL FOR EACH COAX CABLE

GROUND BAR.

AND ALWAYS DIRECT GROUND WIRE DOWN TO

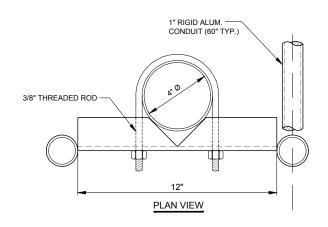

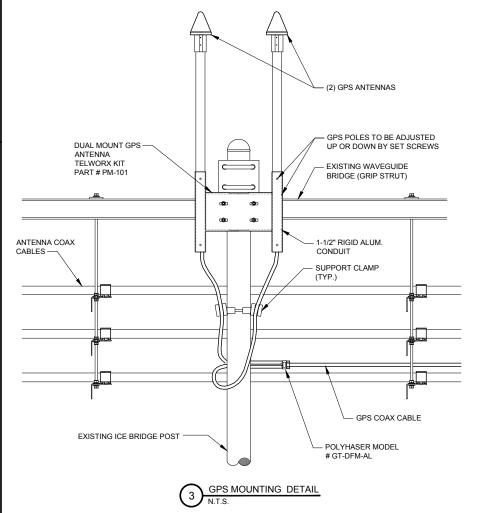





	REVISIONS	
Š.	DESCRIPTION	DATE
•	ISSUED FOR REVIEW	02/25/15
-	REVISED LEASE AREA	02/27/15
2.	UPDATE ACCESS DRIVE MATERIAL	03/11/15
Э.	UPDATE SBA LEASE AREA	03/25/15
4.	UPDATE PER CITY OF PEORIA COMMENTS	04/17/15

SITE IL16128-B

PEORIA 3


HALE AVE PEORIA, IL 61614


ı	DRAWN BY:	BTE
l	CHECKED BY:	TAZ
ı	DATE:	02/25/15
١	PROJECT #:	7544


ANTENNA MOUNTING DETAILS

SHEET NUMBER

ANT-4

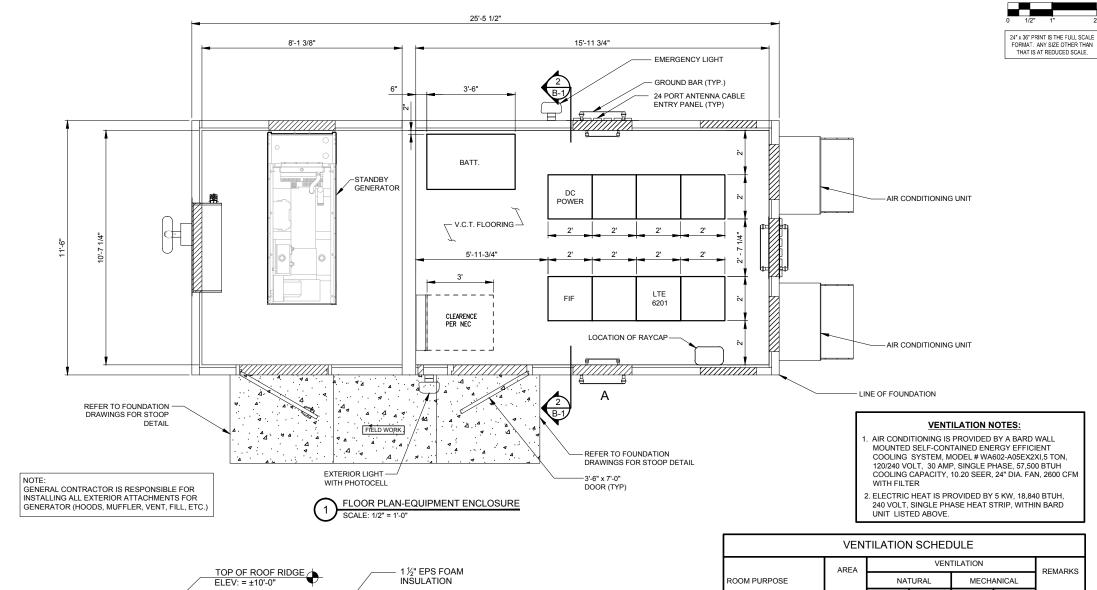

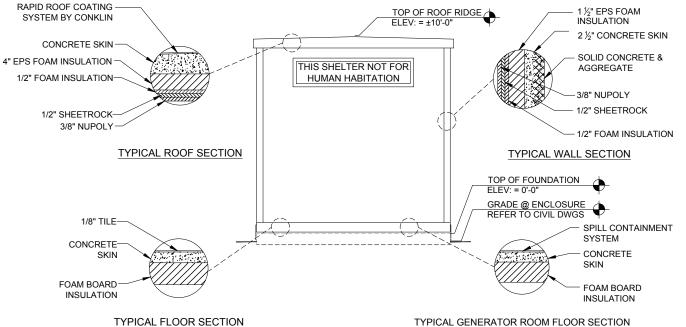

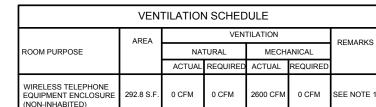

- 1. EQUIPMENT ENCLOSURE IS PRE MANUFACTURED. THIS SHEET IS PROVIDED AS GUIDE ONLY. REFER TO ACTUAL DRAWINGS BY SHELTER MANUFACTURE FOR
- 2. EPS BOARD INSULATION IS LISTED TO HAVE A FLAME SPREAD OF 25 OR LESS AND SMOKE DEVELOPED OF 450 OR LESS WITH A MAXIMUM THICKNESS OF 2 INCHES AT 1 PCF DENSITY. POLYISOCYANURATE FOAM INSULATION HAS BEEN TESTED TO A MAXIMUM THICKNESS OF 3 INCHES AT 1.9 PCF AND HAS A FLAME SPREAD OF 25 AND A SMOKE PRODUCT OF 395.
- 3. INTERIOR PANELING IS LISTED TO HAVE A FLAMESPREAD OF 200 OR LESS.
- 4. THIS ENCLOSURE IS CLASSIFIED AS USE GROUP B, TYPE 5B CONSTRUCTION; PER 1999 BOCA AND IS IN COMPLIANCE WITH 1999 BOCA BUILDING CODE, 1996 INTERNATIONAL MECHANICAL CODE, 2002 NEC AND ILLINOIS ASHRAE 90.1
- 5. DESIGN CRITERIA WIND LOAD = 125 MPH FLOOR DEAD LOAD = 35 PSF WALL DEAD LOAD = 35 PSF ROOF LIVE LOAD = 100 PSF FLOOR LIVE LOAD = 135 PSF SNOW LOAD = 80 PSF ROOF DEAD LOAD = 45 PSF SEISMIC EXPOSURE GROUP = III
- 6. F_c' = 5000 PSI @ 28 DAYS (EQUIPMENT ENCLOSURE)
- 7. ENCLOSURE AND ASSOCIATED EQUIPMENT IS PROVIDED BY OWNER UNDER SEPARATE CONTRACT. EQUIPMENT ENCLOSURE INFORMATION INDICATED HEREIN IS PROVIDED FOR REFERENCE ONLY AND IS TAKEN FROM MANUFACTURER'S AVAILABLE DATA. REFER TO CIVIL, STRUCTURAL AND ELECTRICAL DRAWINGS FOR WORK TO BE PERFORMED UNDER THIS CONTRACT.
- 8. PRIOR TO PROJECT CLOSE OUT AND SHELTER INSTALLATION, THE GENERAL CONTRACTOR IS TO CLEAN THE SHELTER FLOOR AND APPLY A STATIC- FREE



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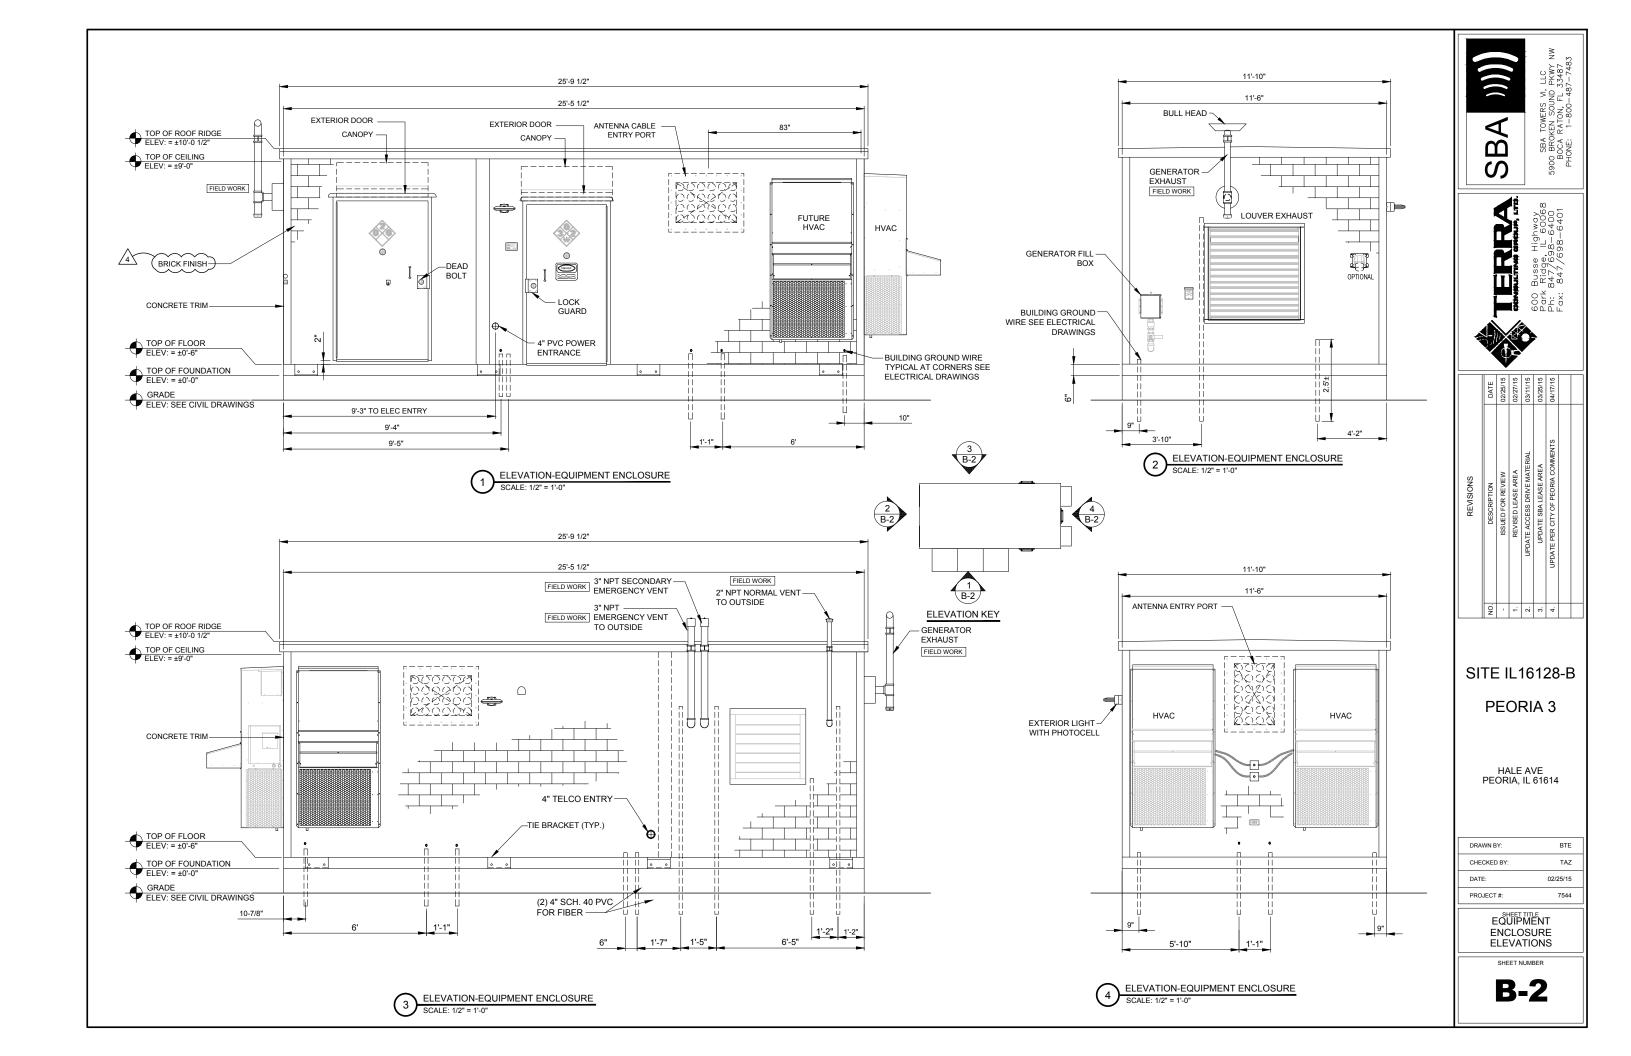
SITE IL16128-B

PEORIA 3


PEORIA, IL 61614


ı	DRAWN BY:	BTE
I	CHECKED BY:	TAZ
I	DATE:	02/25/15
I	PROJECT #:	7544


EQUIPMENT **ENCLOSURE** PLAN & SECTION



ELECTRICAL NOTES ALL WORK IS TO COMPLY WITH THE NATIONAL ELECTRICAL CODE (N.E.C.) AND ANY LOCAL ORDINANCES, CODES, AND ALL OTHER ADMINISTRATIVE AUTHORITIES HAVING JURISDICTION. THE CONTRACTOR SHALL FURNISH AND PAY FOR ALL PERMITS AND RELATED FEES. ALL EQUIPMENT AND MATERIAL FURNISHED AND INSTALLED UNDER THIS CONTRACT SHALL BE UNDERWRITERS LABORATORIES (U.L.) LISTED, NEW, FREE FROM DEFECTS, AND SHALL BE GUARANTEED FOR A PERIOD OF ONE YEAR FROM DATE OF FINAL ACCEPTANCE BY OWNER OR HIS REPRESENTATIVE. SHOULD ANY TROUBLE DEVELOP DURING THIS PERIOD DUE TO FAULTY WORKMANSHIP, MATERIAL OR EQUIPMENT, THE CONTRACTOR SHALL FURNISH ALL NECESSARY MATERIALS AND LABOR TO CORRECT THE TROUBLE WITHOUT COST TO THE OWNER. \triangleleft SBA S 5900 BROK BOCA F PHONE: \mathbf{m} ഗ EXISTING ELECTRIC -ALL WORK SHALL BE EXECUTED IN A WORKMAN LIKE MANNER AND SHALL PRESENT A NEAT MECHANICAL APPEARANCE WHEN COMPLETED. THE CONTRACTOR SHALL BE RESPONSIBLE FOR ALL CUTTING AND PATCHING RELATED TO ELECTRICAL WORK, AND SHALL RESTORE ALL EXISTING LANDSCAPING, SPRINKLER SYSTEMS, CONDUITS, WIRING, PIPING, ETC. DAMAGED BY THE ELECTRICAL WORK TO MATCH EXISTING CONDITIONS. VAULT 24" x 36" PRINT IS THE FULL SCALE TERRY Busse High Ridge, IL 847/698-847/698-ELECTRICAL WORK SHALL INCLUDE, BUT NOT BE LIMITED TO, ALL LABOR, MATERIALS AND EQUIPMENT REQUIRED TO COMPLETE ELECTRICAL POWER AND LIGHTING SYSTEMS, TELEPHONE AND COMMUNICATION SYSTEMS, PANEL BOARDS, CONDUIT, CONTROL WIRING, GROUNDING, ETC. AS INDICATED ON ELECTRICAL DRAWINGS AND/OR AS REQUIRED BY GOVERNING CODES. PRIOR TO INSTALLING ANY ELECTRICAL WORK. THE CONTRACTOR SHALL VISIT THE JOB SITE AND VERIFY EXISTING SITE LOCATIONS AND CONDITIONS AND UTILITY SERVICE REQUIREMENTS OF THE JOB, AND BY REFERENCE TO ARCHITECTURE AND EQUIPMENT SUPPLIERS DRAWINGS. SHOULD THERE BE ANY QUESTION OR PROBLEM CONCERNING THE NECESSARY PROVISIONS TO BE MADE, PROPER DIRECTIONS SHALL BE OBTAINED BEFORE PROCEEDING WITH ANY WORK. PROVIDE POWER AND TELEPHONE TO SERVICE POINTS PER UTILITY COMPANY REQUIREMENTS. CONTRACTOR SHALL CONTACT UTILITY SERVICE PLANNERS AND OBTAIN ALL SERVICE REQUIREMENTS AND INCLUDE COSTS FOR SUCH IN HIS BID. SERVICE EQUIPMENT SHALL HAVE A SHORT CIRCUIT WITHSTAND RATING EQUAL TO OR EXCEEDING THE MAXIMUM AVAILABLE FAULT CURRENT AT THE SUPPLY TERMINAL. THE INSTALLATION SHALL BE FREE FROM ANY SHORT CIRCUITS AND GROUNDS. (1) 4" FIBER CONDUIT FROM FIBER HANDHOLE TO LESSEE SHELTER, 78± L.F. ALL WIRING SHALL BE COPPER WITH THHN/THWN DUAL RATED 600 VOLTS INSULATION. IN THE EVENT OF ANY CONFLICT OR INCONSISTENCY BETWEEN ITEMS SHOWN ON THE PLANS AND/OR SPECIFICATIONS, THE NOTE, SPECIFICATION OR CODE WHICH PRESCRIBES AND ESTABLISHES THE HIGHEST STANDARD OF PERFORMANCE SHALL PREVAIL. SERVICE CONDUITS SHALL HAVE NO MORE THAN (2) -90° BENDS IN ANY SINGLE RUN. THE CONTRACTOR SHALL PROVIDE PULL BOXES AS NEEDED WHERE CONDUIT REQUIREMENTS EXCEED THESE CONDITIONS. (5) 11. ALL ELECTRICAL EQUIPMENT SHALL BE ANCHORED TO WITHSTAND 100 M.P.H. WIND SPEED AND DESIGNED FOR EXPOSURE C. 3" WITH (3) 4/O + (1) # 2 G., 53± L.F. ALL COAX, POWER AND TELEPHONE SYSTEM CONDUITS SHALL HAVE A MINIMUM 24" RADIUS SWEEPS TO EQUIPMENT, PULLBOXES, MONOPOLE, ETC., UNLESS OTHERWISE NOTED, OR AS REQUIRED BY UTILITY COMPANIES. 12. 13. FUSE TYPE SHALL BE BUSSMAN RKI LOW PEAK FUSE (LPU-RK-100). PROPOSED MULTI-GANG UPON COMPLETION OF THE JOB, THE CONTRACTOR SHALL FURNISH AS-BUILT DRAWINGS TO THE OWNER. METER H-FRAME AS-BUILT DRAWINGS TO THE OWNER. CONTRACTOR TO PROVIDE GUTTER TAP(S) AS REQUIRED. GENERAL GROUNDING CRITERIA (FOR TENANT IMPROVEMENTS): 1ST STEP: GROUND TO EXISTING BUILDING STRUCTURAL STEEL AND TO THE STREET SIDE OF EXISTING WATER METER COLD WATER LINE. THEN TEST GROUNDING RESISTANCE TO WITHIN 1 TO 5 OHMS OVERALL GROUND RESISTANCE TO WITHIN 1 TO 5 OHMS OVERALL GROUND RESISTANCE DOES NOT MEET THIS CRITERIA, PROVIDE SUPPLEMENTAL GROUNDING AND RE-TEST UNTIL GROUND RESISTANCE FALLS BELOW THIS LEVEL. SUPPLEMENTAL GROUND MAY CONSIST OF ONE OR MORE OF THE FOLLOWING: 1) COUNTERPOISE, 2) UFER GROUND, 3) GROUND MD ROD AND/OR GROUND WELL IN EXTREMELY ADVERSE SOIL CONDITIONS. WHERE THE EXISTING BUILDING STEEL DOES NOT PROVIDE AN EFFECTIVE GROUND RESISTANCE. THEN THE CONTRACTOR SHALL PROVIDE A SEPARATE GROUND CONDUCTOR FROM ROOF MOUNTED BTS EQUIPMENT LOCATIONS EITHER DOWN THROUGH THE INSIDE OF THE BUILDING OR DOWN THE OUTSIDE OF THE BUILDING, DEPENDING UPON OWNER PREFERENCE. WHERE THE GROUND CONDUCTOR FROM THE ROOF MOUNTED EQUIPMENT IS ROUTED IN CONDUIT. THE CONDUIT SALL BE EFFECTIVELY GROUNDED TO THE GROUND CONDUCTOR AT BOTH ENDS OF THE CONDUIT. (MONOPOLE INSTALLATIONS): FOR INSTALLATIONS WHERE WOODEN STRUCTURES, TOWERS, CONCRETE SILOS ETC. ARE ENCOUNTERED A SEPARATE DAY A MINIMUM OF 12 INCHES FROM THE ANTENNAS SEPARATED BY A MINIMUM OF 12 INCHES FROM THE ANTENNAS SEPARATED BY A MINIMUM OF 12 INCHES FROM THE CONTROL CASH SHALL BE PROVIDED FROM THE ANTENNAS SEPARATED BY A MINIMUM OF 12 INCHES FROM THE CONTROL SHALL BE STERLED TO THE EXTERIOR OF OUTSIDE STRUCTURES WITH NONMET ALLATIONS AND PROCEED PER THE ABOVE STEPS. 7. CONTRACTOR TO COLOR PHASE CONDUCTORS BLACK OF DUASED BY A MINIMUM OF 12 INCHES FROM THE CONTROL OF THE BLACK OF DUASED BEACK ON DUASED BEACK ON DUASED BEFOR OUTSIDE STRUCTURES WITH NONMET ALLATIONS AND PROCEED PER THE ABOVE STEPS. 15. CONTRACTOR TO PROVIDE GUTTER TAP(S) AS REQUIRED. PROPOSED FIBER HANDHOLE-(BY FIBER PROVIDER) **SITE IL16128-B** PROPOSED PEORIA 3 TRANSFORMER PRIMARY ELECTRIC FEED FROM EXISTING FLECTRIC VAULT TO NEW TRANSFORMER, CONTRACTOR TO PROVIDE (2) 4" C., 182 L.F.± FOR CONTINUATION HALE AVE OF FIBER RUN PEORIA, IL 61614 (SEE LP SHEET) BTE TAZ DATE 02/25/15 OPERATES 24 HOURS A DAY 365 DAYS A YEAR 7544 PROJECT # FIBER SERVICE SHEET TITLE EXTENSION FROM R.O.W., UTILITY ROUTING PLAN 408 L.F.± TO HANDHOLE CONTRACTOR TO COLOR PHASE CONDUCTORS BLACK (B PHASE), RED (A PHASE), WHITE (NEUTRAL), AND Before You Dig (TO BE DETERMINED) 18. ALL ELECTRICAL WORK SHALL BE IN ACCORDANCE WITH SHEET NUMBER UTILITIES: POWER PHONE APPLICABLE SECTIONS OF THE LOCAL AND STATE BUILDING CODES AMEREN ILLINOIS T.B.D. ILLINOIS ONE CALL SYSTEM MICHELLE MCIRVIN CALL JULIE TOLL FREE 309-693-4879 48 HOURS BEFORE YOU DIG

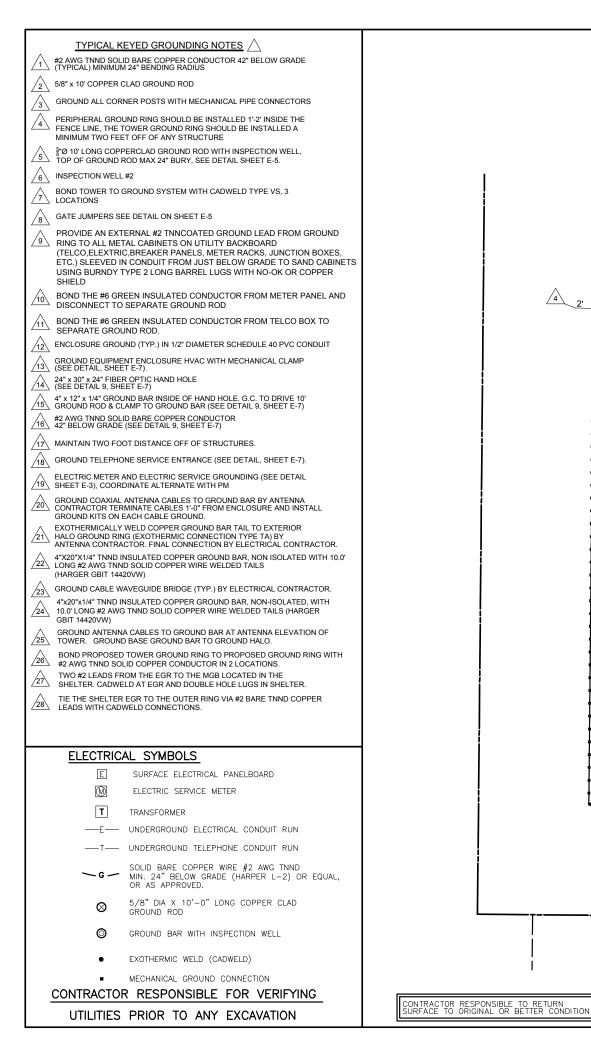

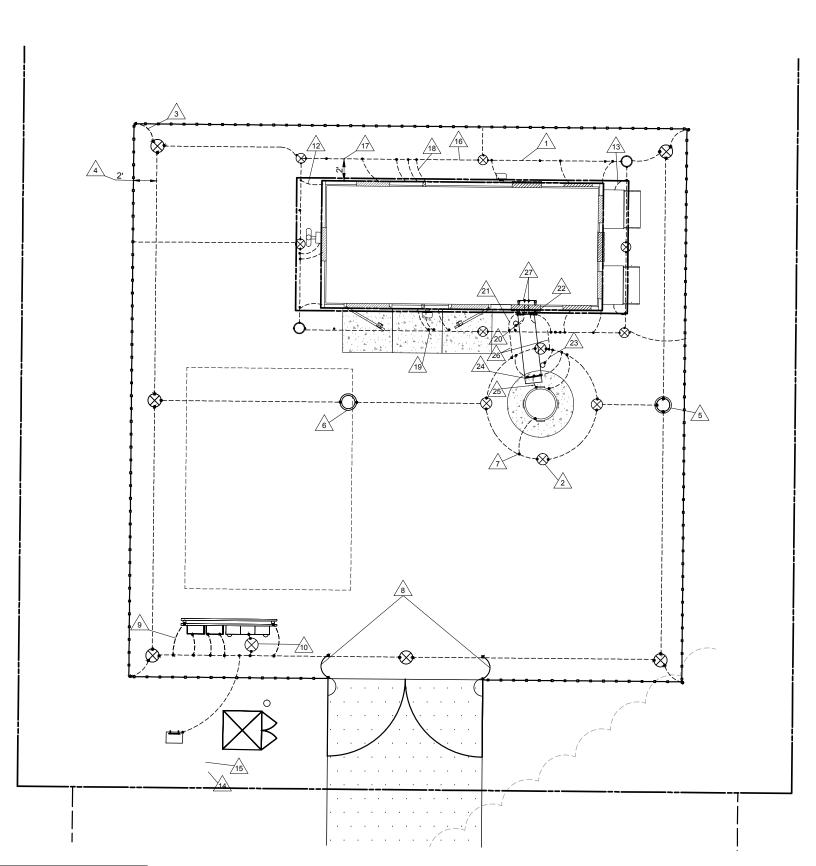

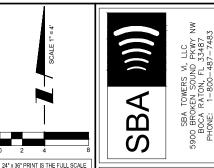

FORMAT. ANY SIZE OTHER THAN THAT IS AT REDUCED SCALE.



	DATE	02/25/15	02/27/15	03/11/15	03/25/15	04/17/15			
REVISIONS	DESCRIPTION	ISSUED FOR REVIEW	REVISED LEASE AREA	UPDATE ACCESS DRIVE MATERIAL	UPDATE SBA LEASE AREA	UPDATE PER CITY OF PEORIA COMMENTS			
	NO.	1	←.	2.	3.	4			

SITE IL16128-B

PEORIA 3

HALE AVE PEORIA, IL 61614

	DRAWN BY:	BTE				
	CHECKED BY:	TAZ				
	DATE:	02/25/15				
URS YEAR	PROJECT #:	7544				
	SHEET TITLE					
,	SHEET TITLE					

Call SHEET TITLE
STORE SITE GROUNDING
PLAN


OPERATES 24 HO A DAY 365 DAYS A

ILLINOIS ONE CALL SYSTEM

48 HOURS BEFORE YOU DIG SHEET NUMBER

E-2

ALL CONNECTIONS TO GROUND BAR SHALL
BE COATED WITH A NON-OXIDIZING COMPOUND

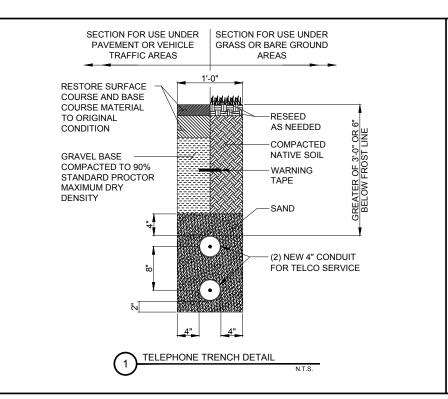

2 125A TENANT SERVICE DISCONNECT (SQUARE D CATALOG

W/ 20A COMMERCIAL GRADE DUPLEX RECEPTACLE

(TESSCO #302065, OR APPROVED EQUAL)


125A 120/240V 1 PHASE, 3 WIRE, 12 POSITION LOAD CENTER


(SQUARE D QO LOAD CENTER #QO112L125GRB, OR APPROVED EQUAL)

80kA 120/240V, 1 PHASE, 3 WIRE TRANSIENT VOLTAGE SURGE SUPPRESSER

120/240V 1-GANG COMMERCIAL GRADE OUTDOOR ELECTRICAL BOX

#QOM2125MVH, OR EQUAL)

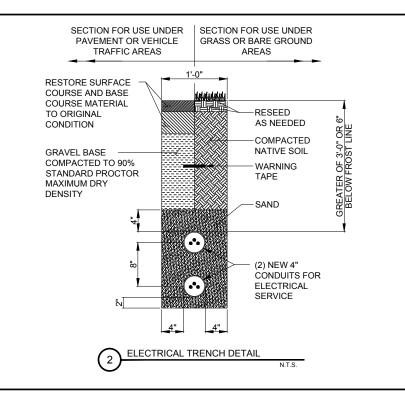

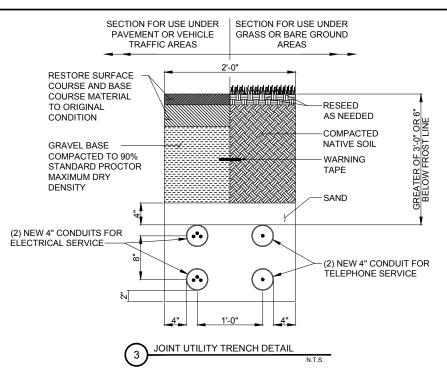

(7)

TELCO H-FRAME

REAR VIEW

(11) 6' #6 GROUND WIRE COILED AT POST. CONNECT TO GROUNDING SYSTEM

(12) #2 AWG BARE SOLID TINNED COPPER WIRE ROUTED TO GROUNDING

SYSTEM (TYP. EACH LEG)

(10)







SITE IL16128-B

PEORIA 3


HALE AVE PEORIA, IL 61614

QUEET TITLE	
PROJECT#:	7544
DATE:	02/25/15
CHECKED BY:	TAZ
DRAWN BY:	BTE

UTILITY DETAILS

SHEET NUMBER

E-3

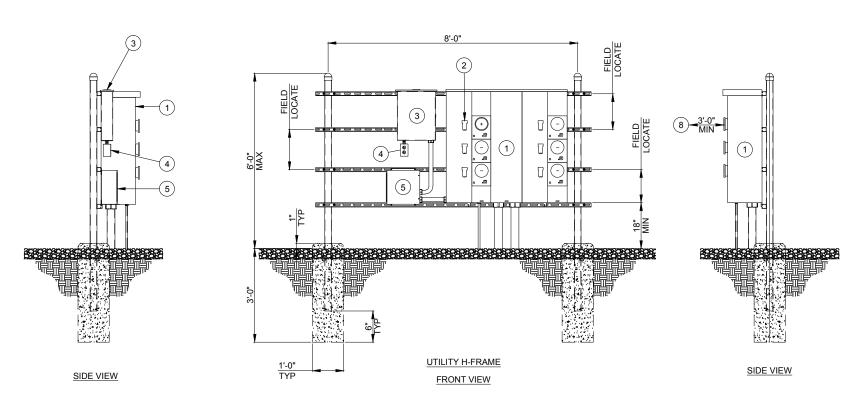

BALLOON REFERENCE NOTES:

- (6) 3" NOMINAL GALVANIZED STEEL PIPE WITH PIPE CAP (1) 800A, 120/240V, 1 PHASE, 3 WIRE, 6 POSITION METERING CENTER (200A MAX CIRCUIT BREAKER) (SQUARE D METER PAK MPR86200, OR EQUAL)
 - (7) HORIZONTAL SUPPORT MEMBER (UNISTRUT P1000, OR APPROVED EQUAL)
 - CONTRACTOR TO MAINTAIN 3'-0" MINIMUM CLEARANCE FROM METERING
 - CENTER TO NEAREST OBSTRUCTION
 - PROPOSED TELCO PEDESTAL (PROVIDED BY AT&T) LOCATED NEXT TO UTILITY POLE IN R.O.W.

 - 4'x4' HOFFMAN BOX FOR TELCO

UTILITY & TELCO H-FRAME DETAIL

LOAD PER PHASE (VA)				SBA PA	NEL SCH	HEDULE				LOAD	
		MAIN: 125A MAIN LUGS VOLTAGE: 120/240V PHASE: 1 WIRE: 3 FEEDER: INTERRUPT RATING: 10 KAIC ENCLOSURE: NEMA 3R									PHASE (VA)
Α	В	CIRCUIT DESCRIPTION BREAKER WIRE NO. NO. WIRE BREAKER CIRCUIT DESCRIPTION							Α	В	
-	-	DUPLEX RECEPTACLE 20A #10 1 2 - SPARE						-	-		
-	-	SPARE 3 4 SPARE						-	-		
-	-	SPARE	-	-	5	6	-	-	SPARE	-	-
-	-	SPARE	-	-	7	8	-	-	SPARE	-	-
-	-	SPARE	-	-	9	10	-	-	SPARE	-	-
-	-	SPARE	-	-	11	12	-	-	SPARE	-	-


 SERVICE BOND IS TO BE MADE BY DEVICES (STRAPS, SCREWS. ETC.) SUPPLIED BY EQUIPMENT MANUFACTURER. IF NO SUCH DEVICE IS SUPPLIED, BOND IS TO BE MADE IN ACCORDANCE WITH NEC ARTICLE 250.

310-16.

- CONDUCTOR OVERCURRENT PROTECTION DEVICES
 ARE SELECTED IN ACCORDANCE WITH NEC ARTICLE
 240-3.
 CONDUCTOR SIZING IS SELECTED FROM NEC ARTICLE
- CONDUCTOR OVERCURRENT PROTECTION DEVICES
 ARE SELECTED IN ACCORDANCE WITH NEC ARTICLE
 240-3.
 CONDUCTOR SIZING IS SELECTED FROM NEC
 ARTICLE 310-16.
- 4. ALL LUGS THAT HOLD MORE THAN ONE WIRE SHALL BE LISTED FOR MULTI-BARRELL CONNECTIONS.
- 5. ALL CONDUCTORS SHALL BE INSULATED THHN WIRE

1) LOAD CENTER PANEL SCHEDULE & NOTES

N.T.S.

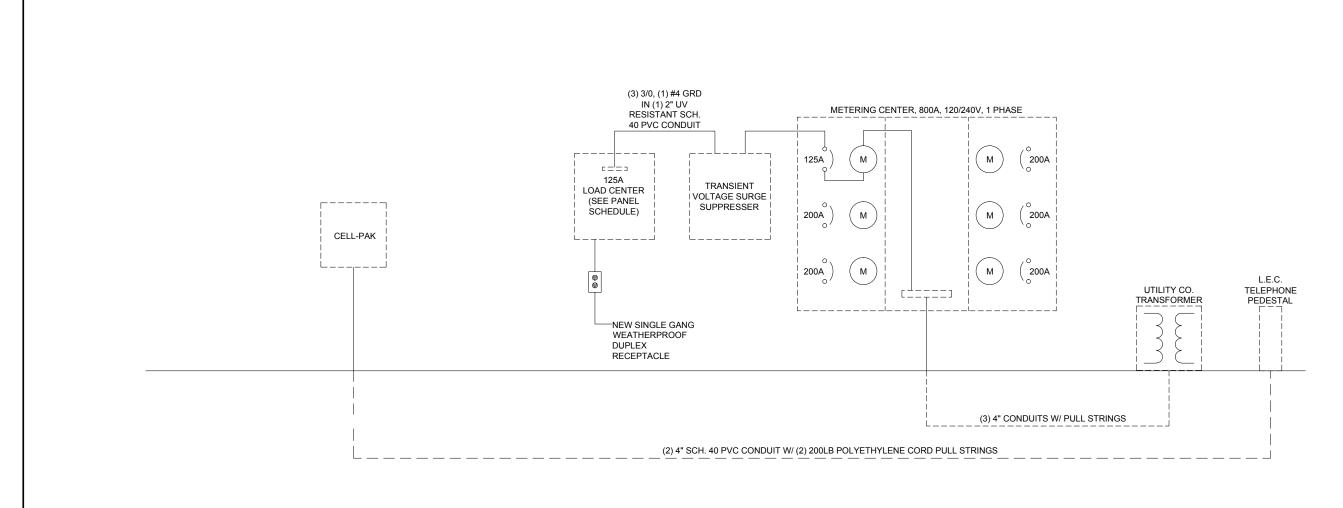





NO. DESCRIPTION DATE - ISSUED FOR REVIEW 02/25/15 1. REVISED LEASE AREA 02/27/15 2. UPDATE ACCESS DRIVE MATERIAL 03/11/15 3. UPDATE SBA LEASE AREA 03/11/15 4. UPDATE PER CITY OF PEORIA COMMENTS 04/17/15		REVISIONS	
ISSUED FOR REVIEW REVISED LEASE AREA UPDATE ACCESS DRIVE MATERIAL UPDATE SBA LEASE AREA UPDATE PER CITY OF PEORIA COMMENTS	Š		DATE
REVISED LEASE AREA UPDATE ACCESS DRIVE MATERIAL UPDATE SBA LEASE AREA UPDATE PER CITY OF PEORIA COMMENTS	'	ISSUED FOR REVIEW	02/25/15
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UPDATE SBA LEASE AREA UPDATE PER CITY OF PEORIA COMMENTS	2	UPDATE ACCESS DRIVE MATERIAL	03/11/15
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SITE IL16128-B


PEORIA 3

HALE AVE PEORIA, IL 61614

DRAWN BY:	BTE
CHECKED BY:	TAZ
DATE:	02/25/15
PROJECT #:	7544

SINGLE LINE DIAGRAM & PANEL SCHEDULE



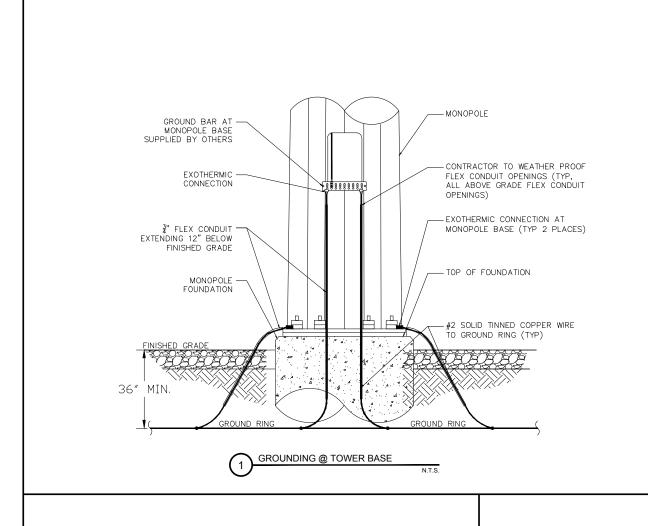

CADWELD CONNECTIONS (OR APPROVED EQUAL)



PARALLEL HORIZONTAL CONDUCTORS PARALLEL THROUGH CONNECTION OF HORIZONTAL CABLES TYPE PT



THROUGH CABLE TO GROUND ROD THROUGH CABLE TO TOP OF GROUND ROD TYPE GT



HORIZONTAL SPLICE SPLICE OF HORIZONTAL CABLES



HORIZONTAL STEEL SURFACE TO FLAT STEEL SURFACE OR HORIZONTAL PIPE TYPE




VERTICAL STEEL SURFACE CABLE DOWN AT 45° TO VERTICAL STEEL SURFACE INCLUDING PIPE TYPE VS



VERTICAL PIPE CABLE DOWN AT 45° TO RANGE OF VERTICAL PIPES



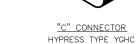



BURNDY CONNECTIONS

(OR APPROVED EQUAL)


BOND JUMPER FIELD FABRICATED GREEN STRANDED INSULATED TYPE





COPPER LUGS TWO HOLE — LONG BARREL LENGTH TYPE YA-2

N.T.S.

TYPICAL WELDING CONNECTIONS

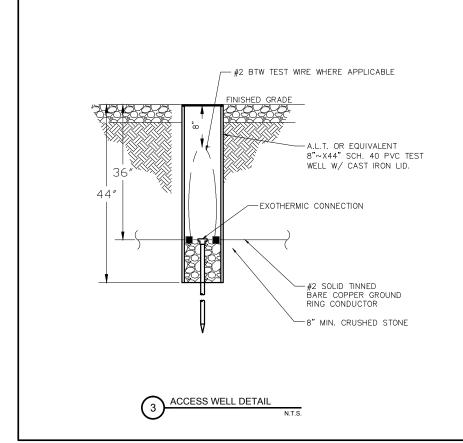

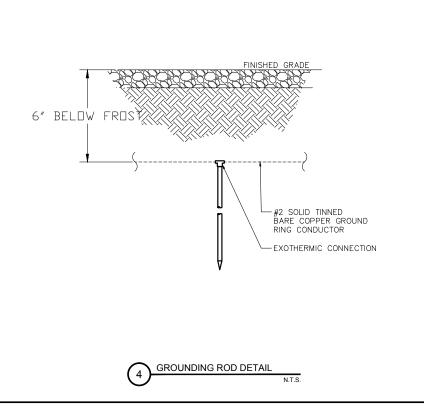

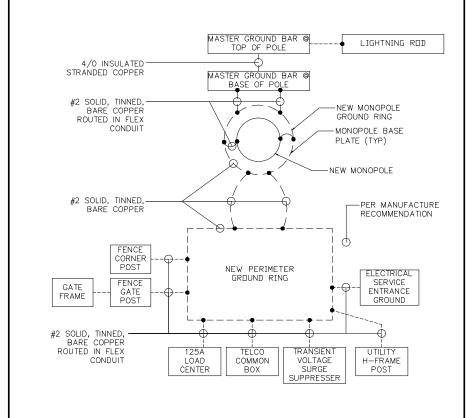

GROUNDING SCHEMATIC




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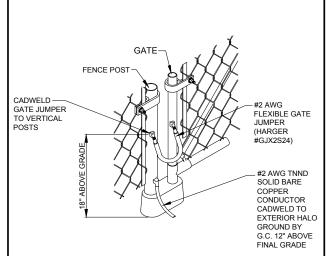
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SHEET TITLE ELECTRICAL & **GROUNDING DETAILS**

SHEET NUMBER

E-5





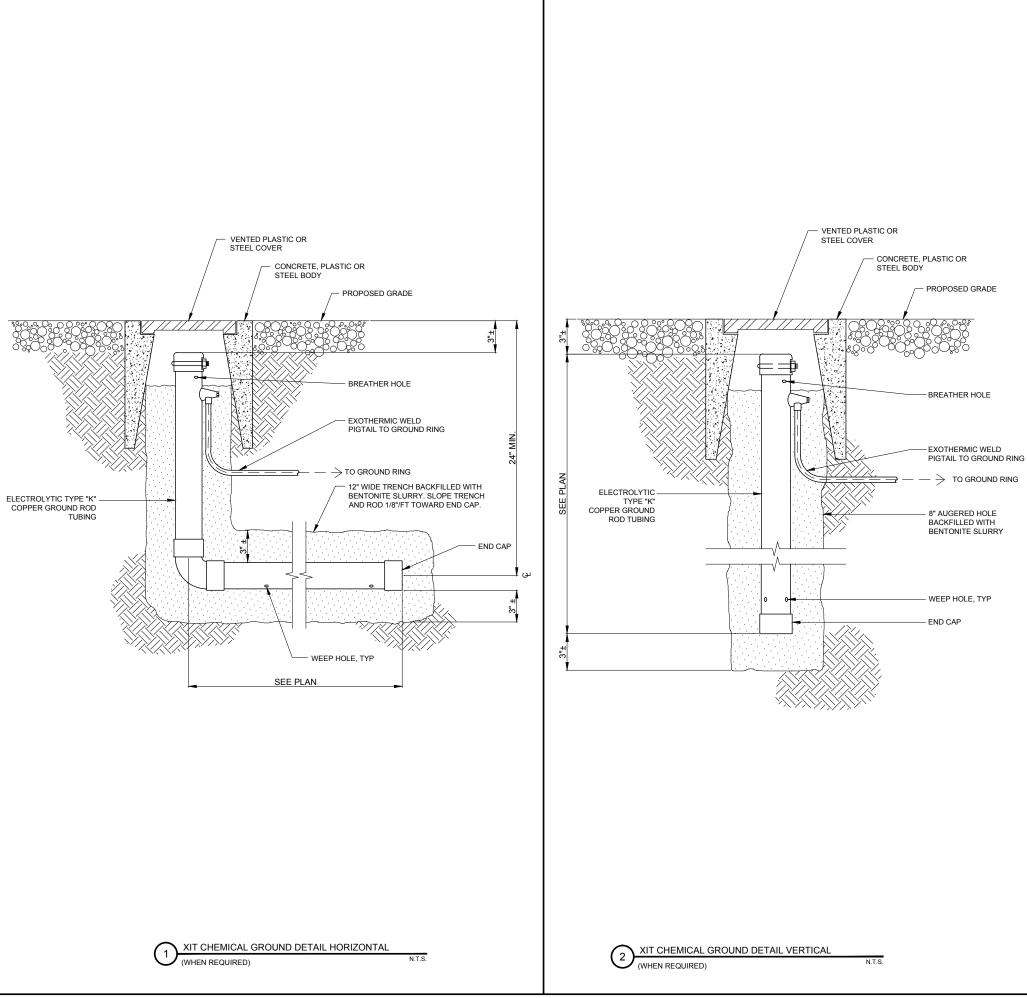



	DATE	02/25/15	02/27/15	03/11/15	03/25/15	04/17/15	
REVISIONS	DESCRIPTION	ISSUED FOR REVIEW	REVISED LEASE AREA	UPDATE ACCESS DRIVE MATERIAL	UPDATE SBA LEASE AREA	UPDATE PER CITY OF PEORIA COMMENTS	
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PEORIA 3

HALE AVE PEORIA, IL 61614


DRAWN BY:	BTE
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DATE:	02/25/15
PROJECT #:	7544

SHEET TITLE
ELECTRICAL &
GROUNDING DETAILS

SHEET NUMBER

E-6

3 CORNER AND GATE FENCE POST DETAIL

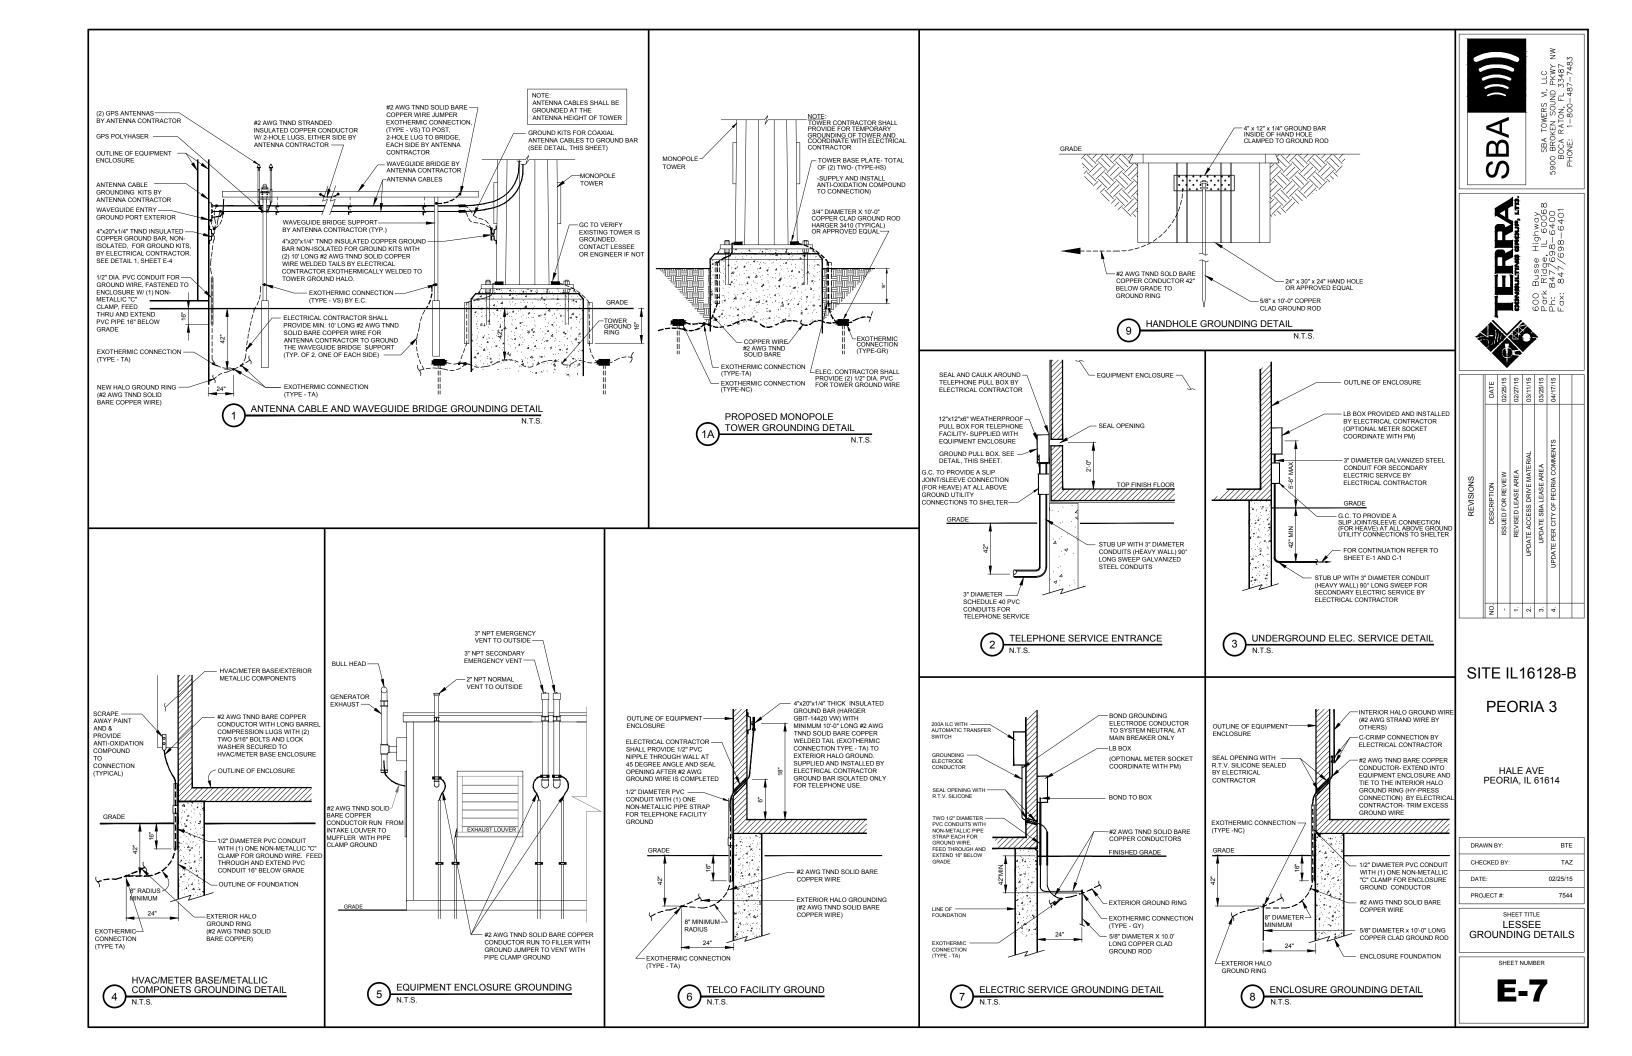

- 1. ALL REFERENCES TO OWNER HEREIN SHALL BE CONSTRUED TO MEAN SBA OR IT'S DESIGNATED REPRESENTATIVE.
- 2.ALL WORK PRESENTED ON THESE DRAWINGS MUST BE COMPLETED UNLESS NOTED OTHERWISE. THE CONTRACTOR MUST HAVE CONSIDERABLE EXPERIENCE IN PERFORMANCE OF WORK SIMILAR TO THAT DESCRIBED HEREIN. BY ACCEPTANCE OF THIS ASSIGNMENT, THE CONTRACTOR IS ATTESTING THAT HE DOES HAVE SUFFICIENT EXPERIENCE AND ABILITY. THAT HE IS KNOWLEDGEABLE OF THE WORK TO BE PERFORMED AND THAT HE IS LICENSED AND PROPERLY REGISTERED TO DO THIS WORK IN THE STATE AND/OR COUNTY IN WHICH IT IS TO BE
- 3. UNLESS SHOWN OR NOTED OTHERWISE ON THE CONTRACT DRAWINGS, OR IN THE SPECIFICATIONS, THE FOLLOWING NOTES SHALL APPLY TO THE MATERIALS LISTED HEREIN, AND TO THE PROCEDURES TO BE USED ON THIS PROJECT.
- 4. ALL HARDWARE ASSEMBLY MANUFACTURER'S INSTRUCTIONS SHALL BE FOLLOWED EXACTLY AND SHALL SUPERCEDE ANY CONFLICTING NOTES ENCLOSED HEREIN.
- 5.IT IS THE CONTRACTOR'S SOLE RESPONSIBILITY TO DETERMINE ERECTION PROCEDURE AND SEQUENCE TO INSURE THE SAFETY OF THE STRUCTURE AND ITS COMPONENT PARTS DURING ERECTION AND/OR FIELD MODIFICATIONS. THIS INCLUDES, BUT IS NOT LIMITED TO, THE ADDITION OF WHATEVER TEMPORARY BRACING, GUYS OR TIE DOWNS THAT MAY BE NECESSARY. SUCH MATERIAL SHALL BE REMOVED AND SHALL REMAIN THE PROPERTY OF THE CONTRACTOR AFTER COMPLETION OF THE PROJECT.
- 6. ALL DIMENSIONS, ELEVATIONS AND EXISTING CONDITIONS SHOWN ON THE DRAWINGS SHALL BE FIELD VERIFIED BY THE CONTRACTOR AND THE TESTING AGENCY PRIOR TO BEGINNING ANY MATERIALS ORDERING, FABRICATION OR CONSTRUCTION WORK ON THIS PROJECT. ANY DISCREPANCIES SHALL BE IMMEDIATELY BROUGHT TO THE ATTENTION OF THE OWNER AND THE OWNER'S ENGINEER. THE DISCREPANCIES MUST BE RESOLVED BEFORE THE CONTRACTOR IS TO PROCEED WITH THE WORK. THE CONTRACT DOCUMENTS DO NOT INDICATE THE METHOD OF CONSTRUCTION. THE CONTRACTOR SHALL SUPERVISE AND DIRECT THE WORK AND SHALL BE SOLELY RESPONSIBLE FOR ALL CONSTRUCTION MEANS, METHODS, TECHNIQUES, SEQUENCES AND PROCEDURES, OBSERVATION VISITS TO THE SITE BY THE OWNER AND/OR THE ENGINEER SHALL NOT INCLUDE INSPECTION OF THE PROTECTIVE MEASURES OR THE CONSTRUCTION PROCEDURES.
- 7. ALL MATERIALS AND EQUIPMENT FURNISHED SHALL BE NEW AND OF GOOD QUALITY, FREE FROM FAULTS AND DEFECTS AND IN CONFORMANCE WITH THE CONTRACT DOCUMENTS. ANY AND ALL SUBSTITUTIONS MUST BE PROPERLY APPROVED AND AUTHORIZED IN WRITING BY THE OWNER AND ENGINEER PRIOR TO INSTALLATION. THE CONTRACTOR SHALL FURNISH SATISFACTORY EVIDENCE AS TO THE KIND AND QUALITY OF THE MATERIALS AND EQUIPMENT BEING SUBSTITUTED.
- 8. THE CONTRACTOR SHALL BE RESPONSIBLE FOR INITIATING, MAINTAINING AND SUPERVISING ALL SAFETY PRECAUTIONS AND PROGRAMS IN CONNECTION WITH THE WORK. THE CONTRACTOR IS RESPONSIBLE FOR INSURING THAT THIS PROJECT AND RELATED WORK COMPLIES WITH ALL APPLICABLE LOCAL, STATE AND FEDERAL SAFETY CODES AND REGULATIONS GOVERNING THIS WORK.
- 9. ALL WORK SHALL BE COMPLETED IN ACCORDANCE WITH THE LATEST EDITION OF THE LOCAL BUILDING CODE.
- ALL PROPOSED CELLULAR EQUIPMENT AND FIXTURES SHALL BE FURNISHED BY OWNER FOR INSTALLATION BY THE CONTRACTOR, UNLESS SPECIFICALLY NOTED OTHERWISE HEREIN.
- 11. ACCESS TO THE PROPOSED WORK SITE MAY BE RESTRICTED. THE CONTRACTOR SHALL COORDINATE INTENDED CONSTRUCTION ACTIVITY, INCLUDING WORK SCHEDULE AND MATERIALS ACCESS WITH THE RESIDENT LEASING AGENT FOR APPROVAL.
- 12. RADIO EQUIPMENT INSTALLATION SHALL BE IN ACCORDANCE WITH THE MANUFACTURER'S SPECIFICATIONS.

- 1. DESIGN REQUIREMENTS PER LOCAL BUILDING CODE AND THE E1A/TIA-222-G STRUCTURAL STANDARDS FOR STEEL ANTENNAS TOWERS AND SUPPORTING STRUCTURES.
- 2. STRUCTURAL STEEL SHALL CONFORM TO THE LATEST EDITION OF A.I.S.C. SPECIFICATIONS FOR STRUCTURAL STEEL BUILDINGS-ALLOWABLE STRESS DESIGN AND PLASTIC DESIGN INCLUDING THE COMMENTARY AND THE A.I.S.C. CODE OF STANDARD PRACTICE.
- 3. STRUCTURAL STEEL PLATES AND SHAPES SHALL CONFORM TO ASTM A36. ALL STRUCTURAL STEEL PIPES SHALL CONFORM TO ASTM A53 GRADE 8. ALL STRUCTURAL STEEL TUBING SHALL CONFORM TO ASTM A500 GRACE 8. ALL STRUCTURAL STEEL COMPONENTS AND FABRICATED ASSEMBLIES SHALL BE HOT DIP GALVANIZED AFTER FABRICATION.
- 4. WELDING SHALL BE IN ACCORDANCE WITH THE AMERICAN WELDING SOCIETY (AWS) D.1.1-96. STRUCTURAL WELDING CODE-STEEL WELD ELECTRODES SHALL BE E70XX.
- 5. ALL COAXIAL CABLE CONNECTORS AND TRANSMITTER EQUIPMENT SHALL BE AS SPECIFIED BY THE OWNER AND IS NOT INCLUDED IN THESE CONSTRUCTION DOCUMENTS. THE CONTRACTOR SHALL FURNISH ALL CONNECTION HARDWARE REQUIRED TO SECURE THE CABLES. CONNECTION HARDWARE SHALL BE STAINLESS STEEL.
- NORTH ARROW SHOWN ON PLANS REFERS TO TRUE NORTH. CONTRACTOR SHALL VERIFY NORTH AND INFORM OWNER OF ANY DISCREPANCY BEFORE STARTING CONSTRUCTION.
- 7. ALL CAST IN PLACE CONCRETE SHALL BE MIXED AND PLACED IN ACCORDANCE WITH THE REQUIREMENTS OF ACI 318 AND AC1 301, AND SHALL HAVE A 28 DAY MINIMUM COMPRESSIVE STRENGTH OF 3000 PSI (U.O.N.). CONCRETE SHALL BE PLACED AGAINST UNDISTURBED SOIL UNLESS OTHERWISE NOTED. MINIMUM CONCRETE COVER SHALL BE 3 INCHES UNLESS OTHERWISE NOTED.
- ALL REINFORCING STEEL SHALL CONFORM TO ASTM 615 GRADE
 80, DEFORMED BILLET STEEL BARS. WELDED WIRE FABRIC
 REINFORCING SHALL CONFORM TO ASTM A185.
- THE FABRICATION AND ERECTION OF STRUCTURAL STEEL SHALL CONFORM TO THE LATEST A.I.S.C. SPECIFICATIONS.
- 10. ALL CONNECTIONS NOT FULLY DETAILED ON THESE PLANS SHALL BE DETAILED BY THE STEEL FABRICATOR IN ACCORDANCE WITH A LS C. SPECIFICATIONS
- HOT-DIP GALVANIZE ITEMS SPECIFIED TO BE ZINC-COATED. AFTER FABRICATION WHERE PRACTICAL. GALVANIZING: ASTM A 123, ASTM A 153/A 153M OR ASTM A 653/A 653M, G90, AS APPLICABLE.
- 12. REPAIR DAMAGED SURFACES WITH GALVANIZING REPAIR METHOD AND PAINT' CONFORMING TO ASTM A 780 OR BY APPLICATION OF STICK OR THICK PASTE MATERIAL SPECIFICALLY DESIGNED FOR REPAIR OF GALVANIZING. CLEAN AREAS TO BE REPAIRED, AND REMOVE SLAG FROM WELDS. HEAT SURFACES TO WHICH STICK OR PASTE MATERIAL IS APPLIED WITH A TORCH TO A TEMPERATURE SUFFICIENT TO MELT THE METALLICS. IN STICK OR PASTE, SPREAD MOLTEN MATERIAL UNIFORMLY OVER SURFACES TO BE COATED AND WIPE OFF EXCESS MATERIAL.
- 13. CONTRACTOR SHALL FOLLOW THE MANUFACTURER'S INSTRUCTIONS/ SPECIFICATIONS IF NO INFORMATION IS CONTAINED IN THESE PLANS OR IF THE MANUFACTURER'S SPECIFICATIONS ARE STRICTER.

PERMITS

- CONTRACTOR SHALL SECURE ALL NECESSARY PERMITS FOR THIS PROJECT FROM ALL APPLICABLE GOVERNMENTAL AGENCIES. (NOT SUPPLIED BY OWNER)
- 2. ANY PERMITS WHICH MUST BE OBTAINED SHALL BE THE CONTRACTORS RESPONSIBILITY. THE CONTRACTOR SHALL BE RESPONSIBLE FOR ABIDING BY ALL CONDITIONS AND REQUIREMENTS OF THE PERMITS. (NOT SUPPLIED BY OWNER)
- 3. ALL WORK SHALL BE IN ACCORDANCE WITH LOCAL CODES AND THE LATEST APPLICABLE CODES AND STANDARDS.
- 4. THE CONTRACTOR SHALL NOTIFY THE APPLICABLE JURISDICTIONAL (STATE, COUNTY, OR CITY) ENGINEER 24 HOURS PRIOR TO THE BEGINNING OF CONSTRUCTION.
- 5. CONTRACTOR RESPONSIBLE FOR CLOSING AND FILING ALL PERMITS ASSOCIATED WITH SITE.

FOR LOCATION OF EXISTING UTILITIES PRIOR TO COMMENCEMENT OF ANY CONSTRUCTION ACTIVITIES.
LOCATION OF EXISTING SEWER, WATER LINES, GAS LINES, CONDUITS OR OTHER STRUCTURES ACROSS, UNDERNEATH, OR OTHERWISE ALONG THE LINE OF PROPOSED WORK ARE NOT NECESSARILY SHOWN ON THE PLANS, AND IF SHOWN ARE ONLY APPROXIMATELY CORRECT. CONTRACTOR ASSUMES SOLE RESPONSIBILITY FOR VERIFYING LOCATION AND ELEVATION OF ALL UNDERGROUND UTILITIES (INCLUDING TEST PITS BY HAND IF NECESSARY) IN AREAS

1 CONTRACTOR SHALL CONTACT A SUBSURFACE UTILITY LOCATOR

SHOWN ON THE PLANS, OR IF THERE APPEARS TO BE A CONFLICT.

2. CONTRACTOR SHALL COORDINATE ALL UTILITY CONNECTIONS WITH APPROPRIATE UTILITY OWNERS AND CONSTRUCTION MANAGER.

OF CONSTRUCTION PRIOR TO STARTING WORK. CONTACT ENGINEER

IMMEDIATELY IF LOCATION DR ELEVATION IS DIFFERENT FROM THAT

- 3. DAMAGE BY THE CONTRACTOR TO UTILITIES OR PROPERTY OF OTHERS, INCLUDING EXISTING PAVEMENT AND OTHER SURFACES DISTURBED BY THE CONTRACTOR DURING CONSTRUCTION SHALL BE REPAIRED TO PRE CONSTRUCTION CONDITIONS BY THE CONTRACTOR AT NO ADDITIONAL COST TO THE CLIENT. FOR GRASSED AREAS. SEED AND MULCH SHALL BE ACCEPTABLE.
- 4. THE CONTRACTOR SHALL COORDINATE WITH THE OWNER THE REQUIREMENTS FOR AND LIMITS OF OVERHEAD AND/OR UNDERGROUND ELECTRICAL SERVICE.
- 5. THE CONTRACTOR SHALL COORDINATE THE LOCATION OF NEW UNDERGROUND TELEPHONE SERVICE WITH THE TELEPHONE UTILITY AND THE OWNER'S REQUIREMENTS.
- 6. ALL UNDERGROUND UTILITIES SHALL BE INSTALLED AND TESTED SATISFACTORY PRIOR TO COMMENCING ANY PAVING OPERATIONS WHERE SUCH UTILITIES ARE WITHIN THE LIMITS OF PAVEMENT.

GRADING

- 1. THE CONTRACTOR SHALL REWORK (DRY, SCARIFY, ETC...) ALL MATERIAL NOT SUITABLE FOR SUB GRADE IN ITS PRESENT STATE. IF THE MATERIAL, AFTER REWORKING, REMAINS UNSUITABLE THEN THE CONTRACTOR SHALL UNDERCUT THIS MATERIAL AND REPLACE WITH APPROVED MATERIAL AT HIS EXPENSE. ALL SUB GRADES SHALL BE PROOF ROLLED WITH A FULLY LOADED TANDEM AXLE DUMP TRUCK PRIOR TO PAVING. ANY SOFT MATERIAL SHALL BE REWORKED OR REPLACED.
- 2. THE CONTRACTOR IS REQUIRED TO MAINTAIN ALL DITCHES, PIPES, AND OTHER DRAINAGE STRUCTURES FREE FROM OBSTRUCTION UNTIL WORK IS ACCEPTABLE BY THE OWNER. THE CONTRACTOR IS RESPONSIBLE FOR ANY DAMAGES CAUSED BY FAILURE TO MAINTAIN DRAINAGE STRUCTURES IN OPERABLE CONDITION.
- ALL MATERIALS AND WORKMANSHIP SHALL BE WARRANTED FOR ONE (1) YEAR FROM DATE OF ACCEPTANCE.
- 4. ALL DIMENSIONS SHALL BE VERIFIED WITH THE PLANS (LATEST REVISION) PRIOR TO COMMENCING CONSTRUCTION. NOTIFY THE OWNER IMMEDIATELY IF DISCREPANCIES ARE DISCOVERED. THE CONTRACTOR SHALL HAVE A SET OF APPROVED PLANS AVAILABLE AT THE SITE AT ALL TIMES WHEN WORK IS BEING PRE FORMED. A DESIGNATED RESPONSIBLE EMPLOYEE SHALL BE AVAILABLE FOR CONTACT BY GOVERNING AGENCY INSPECTORS.

- 1. CONTRACTOR TO COORDINATE PAINTING REQUIREMENTS WITH OWNER.
- 2. PAINT COLORS SHALL BE SELECTED TO MATCH EXISTING COLORS AND TEXTURES
- 3. PROVIDE THE BEST QUALITY GRADE OF COATINGS AS REGULARLY MANUFACTURED BY APPROVED PAINT MATERIAL MANUFACTURERS. MATERIALS NOT DISPLAYING THE MANUFACTURER'S IDENTIFICATION AS A STANDARD, BEST-GRADE PRODUCT WILL NOT BE ACCEPTABLE.
- 4.PROVIDE UNDERCOAT PAINT PRODUCED BY THE SAME MANUFACTURER AS THE FINISH COATS. USE ONLY THINNERS APPROVED BY THE PAINT MANUFACTURER AND USE ONLY WITHIN RECOMMENDED LIMITS.
- 5. COMPLETELY COVER TO PROVIDE AN OPAQUE, SMOOTH SURFACE OF UNIFORM FINISH, COLOR, APPEARANCE, AND COVERAGE. CLOUDINESS, SPOTTINGS, HOLIDAYS, LAPS, BRUSH MARKS, RUNS, SAGS, ROPINESS, OR OTHER SURFACE IMPERFECTIONS WILL NOT BE ACCEPTABLE.

FERROUS METALS SHOP PRIMED

TOUCH-UP COAT - RED OXIDE METAL PRIMER FINISH COATS - SEMI-GLOSS-ALKYD ENAMEL

SBA CONSTRUCTION REQUIREMENTS

- AWARDED CONTRACTOR WILL BE REQUIRED TO SIGN AND RETURN A COPY OF AN AWARD LETTER FOR SBA'S FILE.
- CONTRACTOR WILL BE REQUIRED TO PROVIDE PROOF OF LICENSE TO PERFORM WORK IN JURISDICTION AT TIME OF BID AWARD.
- 3. CONTRACTOR WILL PROVIDE A CONSTRUCTION SCHEDULE PRIOR TO CONSTRUCTION STARTING <u>AND</u> WILL PROVIDE UPDATE/CHANGES (WITH EXPLANATIONS) TO THAT SCHEDULE WHEN/IF ITEMS ARE DELAYED OR PUSHED OUT.
- CONTRACTOR WILL BE RESPONSIBLE FOR ALL CONCRETE COMPRESSIVE TESTING AND REQUIRED TO SUBMIT FINAL TEST RESULTS WITH CLOSE OUT BOOK.
- CONTRACTOR WILL BE RESPONSIBLE TO PROVIDE SBA PROJECT MANAGERS WITH PHOTOS OF THE MAJOR CONSTRUCTION MILESTONES AS THEY OCCUR.
- 6. CONTRACTOR WILL BE RESPONSIBLE TO ASSIST IN COORDINATING AND OBTAINING PRIMARY POWER TO THE SITE PRIOR TO TOWER ERECTION, AS WELL AS TELCO SERVICE BEFORE PROJECT COMPLETION. (ON SITE VISITS WITH UTILITY COMPANY REPRESENTATIVES AS NECESSARY, ETC....).
- CONTRACTOR WILL HAVE A REPRESENTATIVE ON A WEEKLY CONFERENCE CALL TO PROVIDE SBA WITH SITE SPECIFIC UPDATES. CURRENTLY, THIS CONFERENCE CALL IS HELD EACH <u>AND</u> EVERY THURSDAY AT 4 PM (EASTERN TIME).
- 8. CONTRACTOR SHOULD BE PREPARED FOR RANDOM SBA SAFETY INSPECTIONS AT ALL TIMES.
- CONTRACTOR IS EXPECTED TO MAINTAIN PROPER WORKING
 CONDITIONS AND PROCEDURES PER OSHA STANDARDS AT ALL TIMES
 CONTRACTOR WILL BE REQUIRED TO OBTAIN THE NECESSARY
- ELECTRICAL PERMITS AND INSPECTIONS AS REQUIRED BY
 JURISDICTION.
- 11. CONTRACTOR IS EXPECTED TO CLOSE-OUT THE JOB SITE AS QUICKLY AS POSSIBLE (OBTAINING A CERTIFICATE OF OCCUPANCY AND GETTING SBA'S REGIONAL SITE MANAGER'S SIGN-OFF/CHECKLIST APPROVAL ON THE SITE).
- CONTRACTOR WILL PROVIDE A COMPLETED TOWER HEIGHT VERIFICATION FORM AND TAPE DROP WITHIN 24 HOURS OF REACHING OVERALL HEIGHT.
- 13. CONTRACTOR WILL UTILIZE ALL OF THE SBA PROVIDED DOCUMENTATION INCLUDING BUT NOT LIMITED TO: TOWER CONSTRUCTION ACCEPTANCE CHECKLIST, CONSTRUCTION SCHEDULE, CONSTRUCTION CLOSE-OUT LIST & TOWER HEIGHT VERIFICATION.
- 14. CONTRACTOR IS RESPONSIBLE FOR CONCRETE COMPRESSION TESTING.
- 15. CONTRACTOR IS RESPONSIBLE FOR GROUND MEG TESTING.



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PEORIA 3

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GENERAL NOTES

SHEET NUMBER

N-1

GENERAL LANDSCAPE NOTES

- PRUNE NEWLY INSTALLED SHRUBS. WORK SHALL BE DONE BY EXPERIENCED PERSONNEL TO THE ACCEPTED HORTICULTURAL AND ARBORICULTURAL STANDARDS. PRUNING SHALL RESULT IN A LOOSE OUTLINE CONFORMING TO THE GENERAL SHAPE OF THE SHRUB TYPE. DO NOT USE HEDGE SHEARS.
- 2. ALL PLANTING STOCK SHALL BE NURSERY-GROWN IN ACCORDANCE WITH GOOD HORTICULTURAL PRACTICE. PLANTS SHALL BE FREE OF DISEASE, INSECTS EGGS, LARVAE AND DEFECTS SUCH AS KNOTS, SUN-SCALD, INJURIES, ABRASIONS OR DISFIGUREMENT. THEY SHALL HAVE SOUND, HEALTHY VIGOROUS AND UNIFORM GROWTH TYPICAL OF THE SPECIES AND VARIETY, WELL-FORMED, FREE FROM IRREGULARITIES, WITH THE MINIMUM QUALITY AND SIZE CONFORMING TO AMERICAN STANDARD FOR NI IRSERY STOCK
- 3. GUARENTEE: WARRANT ALL PLANT MATERIAL TO BE TRUE TO BOTANICAL NAME AND SPECIFIED SIZE. AFTER COMPLETION OF PLANTING, ALL PLANT MATERIALS SHALL BE WARRANTED AGAINST DEFECTS, INCLUDING DEATH AND UNSATISFACTORY GROWTH FOR A WARRANTY PERIOD OF ONE YEAR. THE CONTRACTOR WILL NOT BE RESPONSIBLE FOR DEFECTS RESULTING FROM NEGLECT ABUSE, DAMAGE BY OTHERS, OR UNUSUAL PHENOMENA OR INCIDENTS BEYOND THE CONTRACTORS CONTROL WHICH RESULT FROM NATURAL CAUSES SUCH AS FLOODS STORMS, FIRES OR VANDALISM.

 REPLACEMENTS: DURING THE WARANTY PERIOD, REPLACE ONE TIME, AT NO ADDITIONAL COST TO THE OWNER, PLANT MATERIALS THAT ARE DEAD, OR IN THE OPINION OF THE LANDSCAPE ARCHITECT, IN AN UNHEALTHY OR UNSIGHTLY CONDITION. REJECTED PLANT MATERIALS SHALL BE REMOVED FROM THE SITE AT CONTRACTOR'S EXPENSE. REPLACEMENTS ARE TO BE MADE NO LATER

THAN THE SUBSEQUENT PLANTING SEASON. RESTORE AREAS DISTURBED BY

4. MULCHING SHALL BE DONE WITHIN 48 HOURS AFTER PLANTING. MULCH SHRUB BEDS TO A UNIFORM DEPTH OF THREE INCHES. MULCH SHALL BE CLEAN COMPOSTED PINE BARK MULCH FREE OF FOREIGN MATERIAL AND LARGE PIECES OVER THREE INCHES LONG. DO NOT MULCH TREE AND SHRUB PLANTING PITS.


REPLACEMENT OPERATIONS.

- 5. TOPSOIL SHALL CONSIST OF FERTILE FRIABLE NATURAL LOAM, CONTAINING A LIBERAL AMOUNT OF HUMUS AND SHALL BE SUBJECT TO INSPECTION AND APPROVAL. IT SHALL BE FREE OF ADMIXTURES OF SUBSOIL AND FREE OF CRAB GRASS, ROOTS, STICKS AND OTHER EXTRANEOUS MATTER, AND SHALL NOT BE USED FOR PLANTING OPERATIONS WHILE IN A FROZEN OR MUDDY CONDITIONS.
- 6. REPAIR ALL TURF AREAS BY SEEDING. SEEDING INSTALLATION SHALL BE EXECUTED ONLY AFTER ALL FINISH GRADING HAS BEEN COMPLETED. NO SEEDING WORK SHALL BE DONE PAST SEPTEMBER 15, UNLESS APPROVED BY THE OWNER'S REPRESENTATIVE.

 SEED: SEDD MIX SHALL MATCH EXISTING TURF, OR BE A 50/50 MIX OF CERTIFIED IMPROVED BLEND OF BLUEGRASS AND CERTIFIED IMPROVED PERENNIAL RYE. MIX SHALL BE APPROVED BY THE OWNER'S REPRESENTATIVE PRIOR TO PLANTING. SEEDING SHALL BE APPLIED AT A MINIMUM RATE OF 120 POUNDS PER ACRE. FUTERRA BLANKET, OR EQUAL, SHALL BE USED FOR EROSION CONTROL MULCH WHERE NECESSARY IN LIEU OF HYDRO MULCH.
- PLANT MATERIAL SHALL CONFORM WITH THE CURRENT AMERICAN STANDARDS FOR NURSERY STOCK, PUBLISHED BY THE AMERICAN ASSOCIATION OF NURSERYMEN FOR THAT TYPE OF TREE OR SHRUB AT THE TIME OF INSTALLATION.
- B. ALL TREES SHALL BE GROWN IN A NURSERY LOCATED IN THE NORTHERN HALF OF THE STATE OF ILLINOIS AND LICENSED BY THE STATE OF ILLINOIS.
- THE PLANTING SEASON SHALL BE APPROXIMATELY OCTOBER 15 TO DECEMBER 1, AND MARCH 15 TO MAY 1.

OPERATES 24 HOURS A DAY 365 DAYS A YEAR



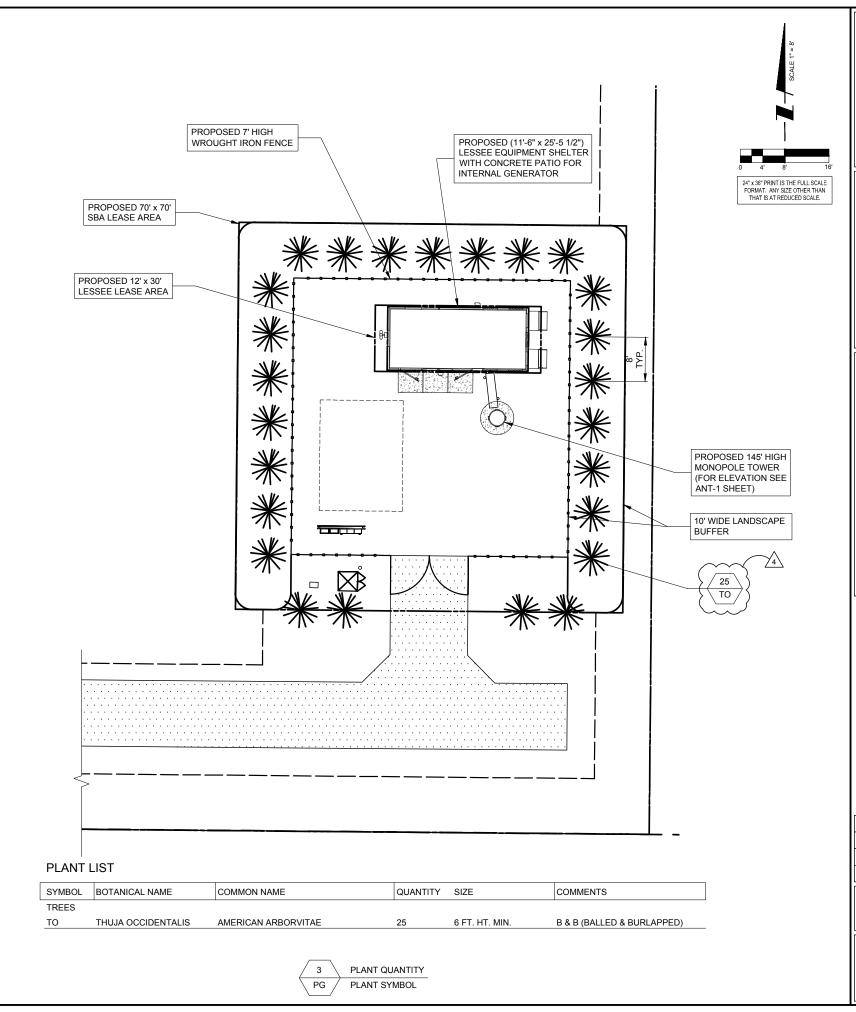

SBA

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SITE IL16128-B

PEORIA 3

HALE AVE PEORIA, IL 61614

SHEET TITLE LANDSCAPE PLAN

SHEET NUMBER

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02/25/15

