


PROJECT INFORMATION AT&T APPROVAL APPLICANT 930 NATIONAL PARKWAY SITE ACQUISITION MANAGER-SCHAUMBURG, IL 60173 MASTEC CONSTRUCTION MANAGER: Date FA CODE: 10094797 MASTEC SA PROJECT MANAGER: Date PROPOSED USE: TELECOMMUNICATIONS FACILITY MASTEC SA SPECIALIST: Date STRUCTURE TYPE: MONOPOLE MASTEC COMPLIANCE MANAGER: Date 1601 WEST GIFT AVENUE PEORIA, IL 61604 SITE ADDRESS: SITE NUMBER: IL5550 AT&T RF PROJECT MANAGER: AT&T PROJECT MANAGER: PROPERTY OWNER: AMERICAN TOWER CORPORATION (ATC, 50690, EL VISTA) Date 10 PRESIDENTIAL WA WOBURN, MA 01801 SITE NAME: EL VISTA AT&T MOBILITY APPROVAL CONTACT PERSON: JAMES PALMER PHONE: 781-926-4758 Real Estate. Date PARCEL NUMBER-PROJECT: JURISDICTION: PEORIA COUNTY Date 40" 43" 13 699" N LTE 3C (1900) / LTE 4C FNET (700)_RESCOPE LATITUDE: Operation Date 89" 37" 09.998" W LONGITUDE: PROJECT DESCRIPTION: ___ LAT/ LONG TYPE: NAD 83 LTE PROJECT REMOVE EXISTING MOUNTING FRAME & REPLACE W/ 20' MONOPOLE EXTENSION. GROUND ELEVATION: INSTALL NEW PLATFORM. RELOCATE (6) ANTENNAS POWER COMPANY: AMEREN CIPS REPLACE (3) EXISTING ANTENNAS, INSTALL (6) NEW RRUS ON POS.1. PHONE-(866) 992-6619 TELEPHONE COMPANY: AT&T REMOVE (6) COAX CABLES & GSM TMA's. 700 **AWS** 1900 850 wcs **FNET** ADD (1) DC POWER & (1) FIBER CABLES. ADD (1) NEW RAYCAP DC6. PHONE: (800) 257-0902 700 DRAWING INDEX REV VICINITY MAP APPLICABLE BUILDING CODES AND STANDARDS CONTRACTOR'S WORK SHALL COMPLY WITH ALL APPLICABLE NATIONAL, STATE, AND LOCAL CODES AS ADOPTED BY THE LOCAL AUTHORITY HAWING JURISDICTION (AHJ) FOR THE LOCATION. THE EDITION OF THE ANJ ADOPTED CODES AND STANDARDS IN EFFECT ON THE DATE OF CONTRACT AWARD SHALL IL5550-01 TITLE SHEET) В DIRECTION: (FROM O'HARE INTERNATIONAL AIRPORT) DEPART CHICAGO O'HARE INTERNATIONAL AIRPORT TAKE RAMP (RIGHT) ONTO I-190/CHICAGO AT EXIT 1D, TURN SITE PLAN (B) IL5550-02 B RIGHT ONTO RAMP I-294/INDIANA MERGE ONTO I-294 [TRI-STATE TOLLWAY]TURN RIGHT ONTO RAMP IL5550-03 **ELEVATION** В 1-55/STEVENSON EXPY/CHOAGO/ST LOUIS TAKE RAMP (RIGHT) ONTO 1-55 /STEVENSON EXPY/ST LOUIS AT EXIT 163, TAKE RAMP (RIGHT) ONTO 1-55 /STEVENSON EXPY/ST LOUIS AT EXIT 163, TAKE RAMP (RIGHT) ONTO 1-74/PEORIA AT EXIT 918, TURN RIGHT ONTO RAMP UNIVERSITY ST NORTH BEAR RIGHT (NORTH) ONTO N UNIVERSITY ST TURN LEFT (WEST) ONTO W GIFT AVE TURN LEFT TO STAY ON W GIFT AVE ARRIVE 1601 W GIFT AVE, PEORIA, IL 61604 IL5550-04 ANTENNA LAYOUT В BUILDING CODE-IL5550-05 **EQUIPMENT LAYOUT** В [INTERNATIONAL BUILDING CODE (IBC), 2015 AS ADOPTED BY LOCAL BUILDING AUTHORITY] IL5550-06 RRUS SPECIFICATIONS В IL5550-07 [NATIONAL FIRE PROTECTION ASSOCIATION (NFPA) 70-2002; CONSTRUCTION DETAILS В PROJECT 2011 NATIONAL ELECTRICAL CODE, AS ADOPTED BY LOCAL BUILDING AUTHORITY] IL5550-08 ANTENNA MATRIX В SITE PEORIA LIGHTNING PROTECTION CODE-IL5550-09 COAX COLOR CODING В [NFPA 780 - 2000, LIGHTNING PROTECTION CODE] IL5550-10 FIBER-OPTIC JUMPER COLOR CODING В CONTRACTOR'S WORK SHALL COMPLY WITH THE LATEST EDITION OF THE FOLLOWING STANDARDS. **GENERAL NOTES** В AMERICAN CONCRETE INSTITUTE (ACI) 318, BUILDING CODE REQUIREMENTS FOR STRUCTURAL IL5550-S01 MOUNT MODIFICATION B В AMERICAN INSTITUTE OF STEEL CONSTRUCTION (AISC), MANUAL OF STEEL CONSTRUCTION, ASD, NINTH IL5550-S02 PLATFORM DETAILS В FDITION TELECOMMUNICATIONS INDUSTRY ASSOCIATION (TIA) 222-G, STRUCTURAL STANDARDS FOR STEEL PLATFORM DETAILS IL5550-S03 В ANTENNA TOWER AND ANTENNA SUPPORTING STRUCTURES: TIA 607, COMMERCIAL BUILDING GROUNDING AND BONDING REQUIREMENTS FOR TELECOMMUNICATIONS IL5550-S04 PLATFORM DETAILS В INSTITUTE FOR ELECTRICAL AND ELECTRONICS ENGINEERS (IEEE) 81, GUIDE FOR MEASURING EARTH RESISTIVITY, GROUND IMPEDANCE, AND EARTH SURFACE POTENTIALS OF A GROUND SYSTEM IEEE 1100 (1999) RECOMMENDED PRACTICE FOR POWERING AND GROUNDING OF ELECTRONIC IEEE C62.41, RECOMMENDED PRACTICES ON SURGE VOLTAGES IN LOW VOLTAGE AC POWER CIRCUITS (FOR LOCATION CATEGORY "C3" AND "HIGH SYSTEM EXPOSURE") TELCORDIA GR-1275, GENERAL INSTALLATION REQUIREMENTS TELCORDIA GR-1503, COAXIAL CABLE CONNECTIONS TELCORIA GR-1503, CUANAL CAGE CONTROL SYSTEMS — TELECOM, ENVIRONMENTAL PROTECTION ANSI TI.311, FOR TELECOM — DC POWER SYSTEMS — TELECOM, ENVIRONMENTAL PROTECTION FOR ANY CONFLICTS BETWEEN SECTIONS OF USITED CODES AND STANDARDS ASSUMEDED MATERIAL METHODS OF CONSTRUCTION, OR OTHER REQUIREMENTS, THE MOST RESIDENCE OF COUNTRY WHERE THERE IS CONFLICT BETWEEN A GENERAL REQUIREMENT AND SPECIAL SYSTEMS. I HEREBY CERTIFY THAT THESE PLANS WERE PREPARED JUNDER MY DIRECT SUPERVISION AND TO THE BEST OF PROFESSIONAL KNOWLEDGE THEY OPPLY WITH THE REQUIREMENT OF ALL APPLICABLE CODES AND PROHAMESES. SITE QUALIFICATION PARTICIPANTS SATISHKUMAR C. THESE DRAWINGS ARE PREPARED NAME COMPANY BASED ON INFORMATION PROVIDED PATEL SATISH PATEL A/E APEX ENGINEERS, INC. (630) 627-1800 BY MASTEC NETWORK SOLUTION. SA MANUEL M. FERRA MASTEC (847) 463-5957 081-004996 GENERAL CONTRACTOR TO VERIFY RF AT&T MOBILITY AND INCORPORATE MOST RECENT DATE: 08/27/19 PM LAURA FEHRMAN MASTEC (847) 634-4949 VERSION OF RFDS PRIOR TO CM MASTEC SATISHKUMAR C. PATEL, S.E. STRUCTURA CONSTRUCTION. 1 (800) 892-0123 ILLINOIS S.E. LICENSE # 081-004996 EXPIRES 11-30-2020 Apex Engineers, Inc. «MasTec AT&T MOBILITY Structural & Civil Engineers **EL VISTA** 個 500 East 22nd Street, Suite B Lombard, Illinois 60148 **Network Solutions** B 08/27/1 SITE NO. IL5550 REVISED PER COMMENTS TITLE SHEET Ph. (630) 627-1800 1351 E. Irving Park Rd Itasco, IL 60143 1601 WEST GIFT AVENUE A 11/07/1 ISSUED FOR REVIEW EW EW SP Fax. (630) 627-1165 PEORIA, IL 61604 NO. DATE REVISIONS BY CHK APP'D APEX JOB No. AT12-236 SCALE: AS SHOWN DESIGNED BY: XX IL5550-01 DRAWN BY: XX 11 x 17 B S77 5 4 3

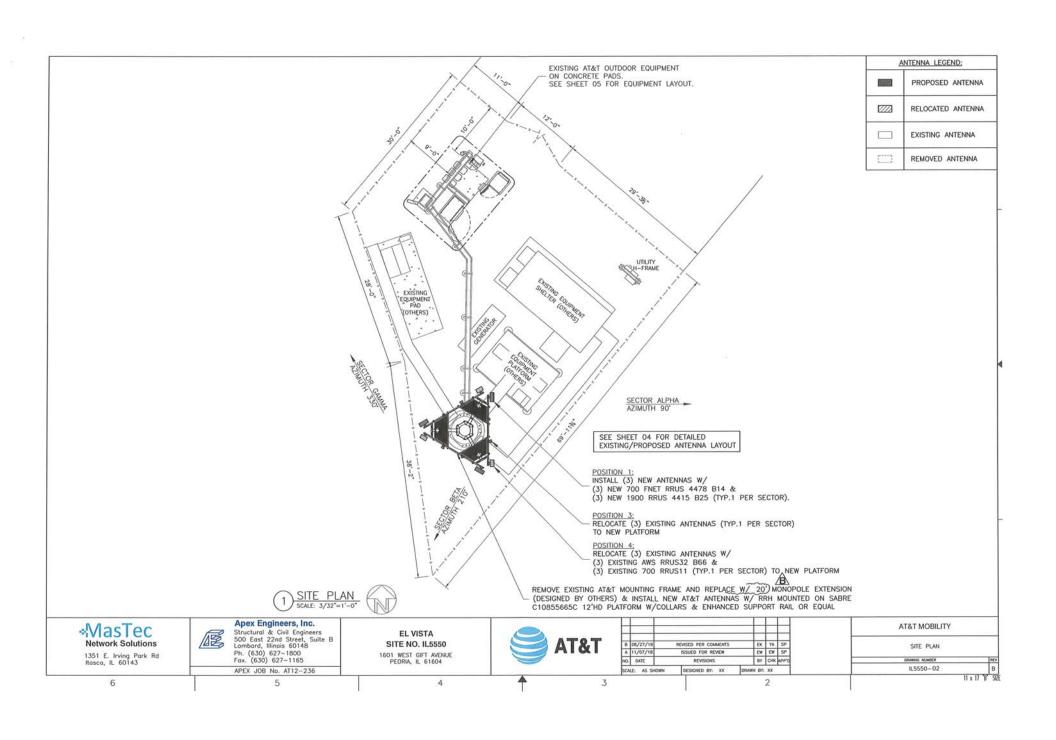

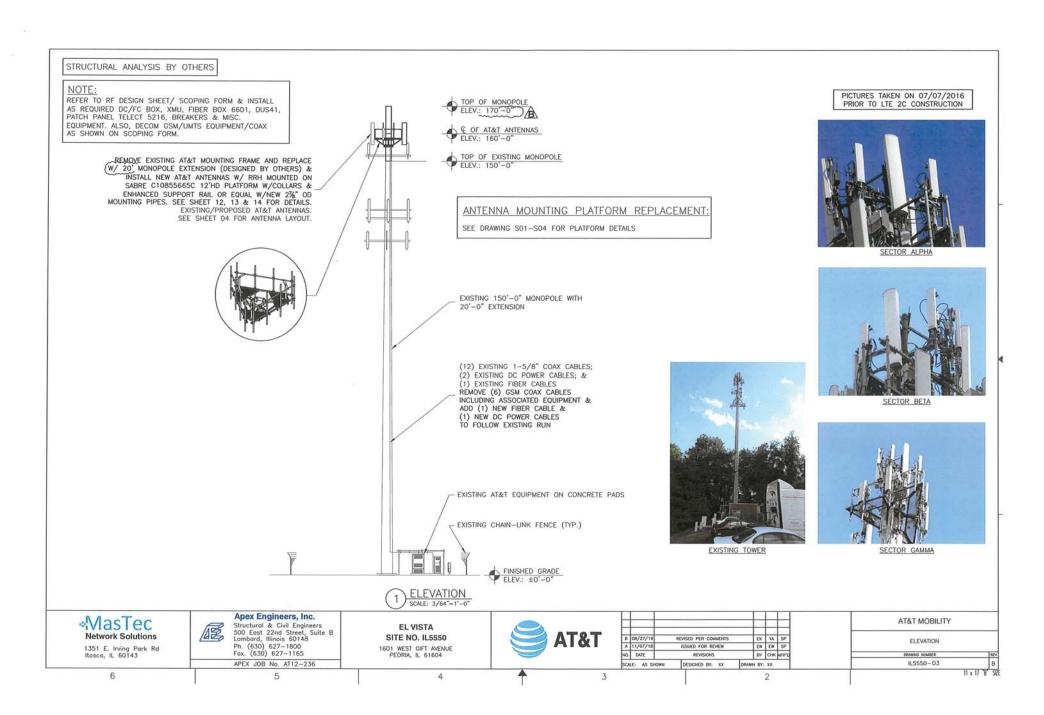

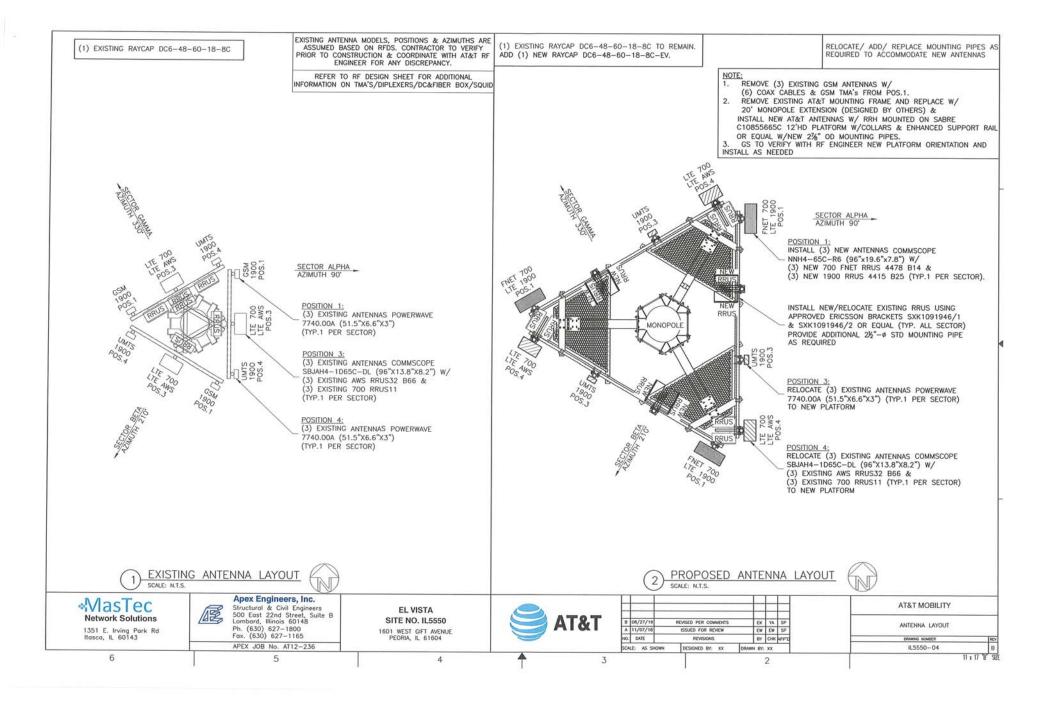

NOTES:

1. EXISTING SPACE FOR PROPOSED EQUIPMENT ASSUMED TO BE ADEQUATE, PRIOR TO INSTALLATION, COORDINATE FINAL LOCATION WITH CONSTRUCTION MANAGER.

2. COORDINATE WITH CONSTRUCTION MANAGER FOR THE PROVISION OF DC CIRCUIT BREAKERS AND OTHER ANCILLARY ITEMS TO SUPPORT THE NEW EQUIPMENT.

PROPERLY BOND ALL EQUIPMENT AND CONDUCTIVE SURFACES TO EXISTING GROUND PER NEC AND AT&T STANDARDS.

4. PURCELL CABINET TO INCLUDE LTE DIGITAL UNIT (DU). GPS 01 RECOVER PER MANUFACTURER'S INSTRUCTIONS.


(1) EXISTING DC12-48-60-0-25E TO REMAIN.

FINAL BBU CONFIGURATION: (1) EXISTING 6601, & (1) EXISTING XMUs. DECOM (1) DUS41.

ADD (1) 5216, (2) 6601, & (1) XMU.

ADD (6) 25A BREAKERS & (1) RECTIFIERS.

DECOM UMTS/GSM AS SHOWN ON SCOPING FORM.

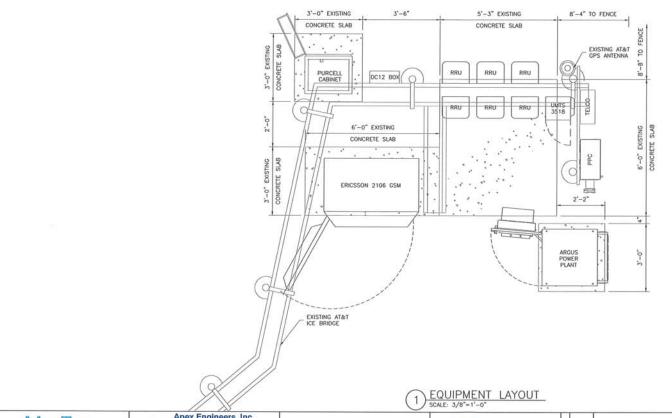

«MasTec **Network Solutions**

1351 E. Irving Park Rd Itasco, IL 60143

Apex Engineers, Inc. Structural & Civil Engineers 500 East 22nd Street, Suite B Lombard, Illinois 60148 Ph. (630) 627-1800 Fax. (630) 627-1165

APEX JOB No. AT12-236

EL VISTA SITE NO. IL5550

1601 WEST GIFT AVENUE PEORIA, IL 61604



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AT&T MOBILITY	
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