CONSULTANT TEAM

CONSULTANT:

TERRA CONSULTING GROUP, LTD. 600 BUSSE HIGHWAY PARK RIDGE, IL 60068

(847) 698-6400

SURVEYOR: WILLIAMS AND WORKS 549 OTTAWA AVE NW

GRAND RAPIDS. MI 49503

(616) 224-1500

APPROVALS

REAL ESTATE:

CONSTRUCTIO

EQUIPMENT ENGINEERING

PROJECT TYPE

PROPOSED LESSEE ANTENNAS MOUNTED ON A NEW MONOPOLE TOWER WITH PROPOSED 11'-6" X 12'-0" EQUIPMENT PLATFORM AT


SITE COORDINATES:

LATITUDE: 40° 46' 59.71" N (1A CERTIFICATION) LONGITUDE: 89° 40' 23.19" W (1A CERTIFICATION)

ELEVATION: ±688' (1A)

DRIVING DIRECTIONS:

FROM LESSEE OFFICE: MERGE ONTO I-55 S VIA THE RAMP ON THE LEFT TOWARD ST LOUIS. MERGE ONTO I-80 W VIA EXIT 250B TOWARD IOWA. MERGE ONTO I-39 S/US-51 S VIA EXIT 79A TOWARD BLOOMINGTON/NORMAL. TAKE THE IL-18 EXIT, EXIT 41, TOWARD HENRY/STREATOR. MERGE ONTO IL-18 TOWARD HENRY. TURN LEFT ONTO STATE ROUTE 26/IL-26. CONTINUE TO FOLLOW II -26 TURN RIGHT ONTO 5TH ST/II -17 CONTINUE TO FOLLOW IL-17, TURN LEFT ONTO S RAILROAD ST/IL-29, CONTINUE TO FOLLOW IL-29. TURN RIGHT ONTO IL-6 S. TAKE THE US-150/WAR MEMORIAL DR EXIT, EXIT 2, TOWARD KICKAPOO. MERGE ONTO W WAR MEMORIAL DR/US-150 W TOWARD KICKAPOO. TAKE THE 1ST RIGHT ONTO STATE ROUTE 91/IL-91. TURN LEFT ONTO W AMERICAN PRAIRIE DR. DESTINATION WILL BE ON THE RIGHT.

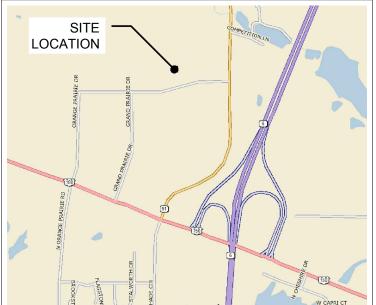

VICINITY MAP

N.T.S.



REGIONAL MAP

CENTRAL STATES TOWER III, LLC

323 SOUTH HALE STREET SUITE 100 WHEATON, IL 60187



1515 WOODFIELD ROAD, SUITE 1400 SCHAUMBURG, ILLINOIS 60173

LOCATION NUMBER: 313801

SITE NAME: SHOPPES OF GRAND PRAIRIE



SITE NUMBER: IL-00-5999

SITE NAME: SHOPPES OF GRAND PRAIRIE

W AMERICAN PRAIRIE DR **PEORIA, IL 61615**



POWER: AMEREN

MICHELLE MCIRVIN MIKE GRIFFIN

(214) 620-4245

(309) 693-4879

PREMISE # 116302520

ZONING:

OCCUPANCY: UNINHABITED CONSTRUCTION TYPE: RAW LAND

PROPERTY OWNER: NORTHWEST PEORIA RETAIL DEVELOPMENT, L.P.

2020 W. WAR MEMORIAL DR. #103

PEORIA. IL 61614

CENTRAL STATES TOWER III, LLC APPLICANT:

323 SOUTH HALE STREET. SUITE 100

WHEATON, IL 60187

SHEET	DRAWING INDEX	REVISION
T-1 LP C-1 C-2 C-3 C-4 C-5 C-6 C-7 C-8 C-9 ANT-1 ANT-2 ANT-3 ANT-4 EQ-1 EQ-2 EQ-3 E-1 E-1A E-1B E-1C E-2 E-3 E-4 E-5 E-6 E-7 L-1	TITLE SHEET LOCATION PLAN ENGINEERING SITE PLAN SITE GRADING PLAN (SHEET 1 OF 1) FENCE DETAILS GENERAL NOTES SITE DETAILS GENERATOR FOUNDATION PLAN ELEVATED STEEL EQUIPMENT PLATFORM FOUNDATION PLAN ELEVATED STEEL EQUIPMENT PLATFORM FLOOR FRAMING PLAN LP TANK DETAILS SITE ELEVATION ANTENNA INFORMATION ANTENNA MOUNTING DETAILS ANTENNA MOUNTING DETAILS EQUIPMENT DETAILS EQUIPMENT DETAILS PLATFORM ELEVATIONS UTILITY ROUTING PLAN GENERATOR UTILITY ROUTING PLAN GENERATOR SINGLE LINE DIAGRAM & ALARM WIRING PANEL SCHEDULE & LIGHTING PLAN SINGLE LINE DIAGRAM & LINE DETAILS ELECTRICAL AND GROUNDING NOTES SITE GROUNDING PLAN GROUNDING DETAILS GROUNDING DETAILS ELECTRICAL DETAILS ELECTRICAL DETAILS ELECTRICAL DETAILS ELECTRICAL DETAILS	3. 3. 3. 3. 3. 3. 3. 3. 3. 3. 3. 3. 3. 3
	ATTACHMENTS	
PS-1	PLAT OF SURVEY	-



N.T.S.



	Ŏ.	DESCRIPTION	DATE	ВУ	
^	-	REVISED PER POWER COORDINATION	12/28/15	MTC	
_	2.	ISSUED FOR FIBER COORDINATION	01/18/16	MT	
_	ю.	UPDATED TO CABINET LAYOUT	10/23/15	SEA	
^	4	UPDATE PER CLIENT COMMENTS	02/08/16	MTC	
١ ٨	2.	ISSUED FOR FINAL	03/22/16	MTL	
	9	REMOVED PLATFORM CANOPY	04/04/16	BTE	
	7.	UPDATE PER LL COMMENTS	04/14/16	ВТЕ	

IL-00-5999 SHOPPES OF GRAND PRAIRIE


W AMERICAN PRAIRIE DR PEORIA, IL 61615

DRAWN BY:	PF
CHECKED BY:	TAZ
DATE:	07/17/15
PROJECT#:	50-168

SHEET TITLE TITLE SHEET

T-1



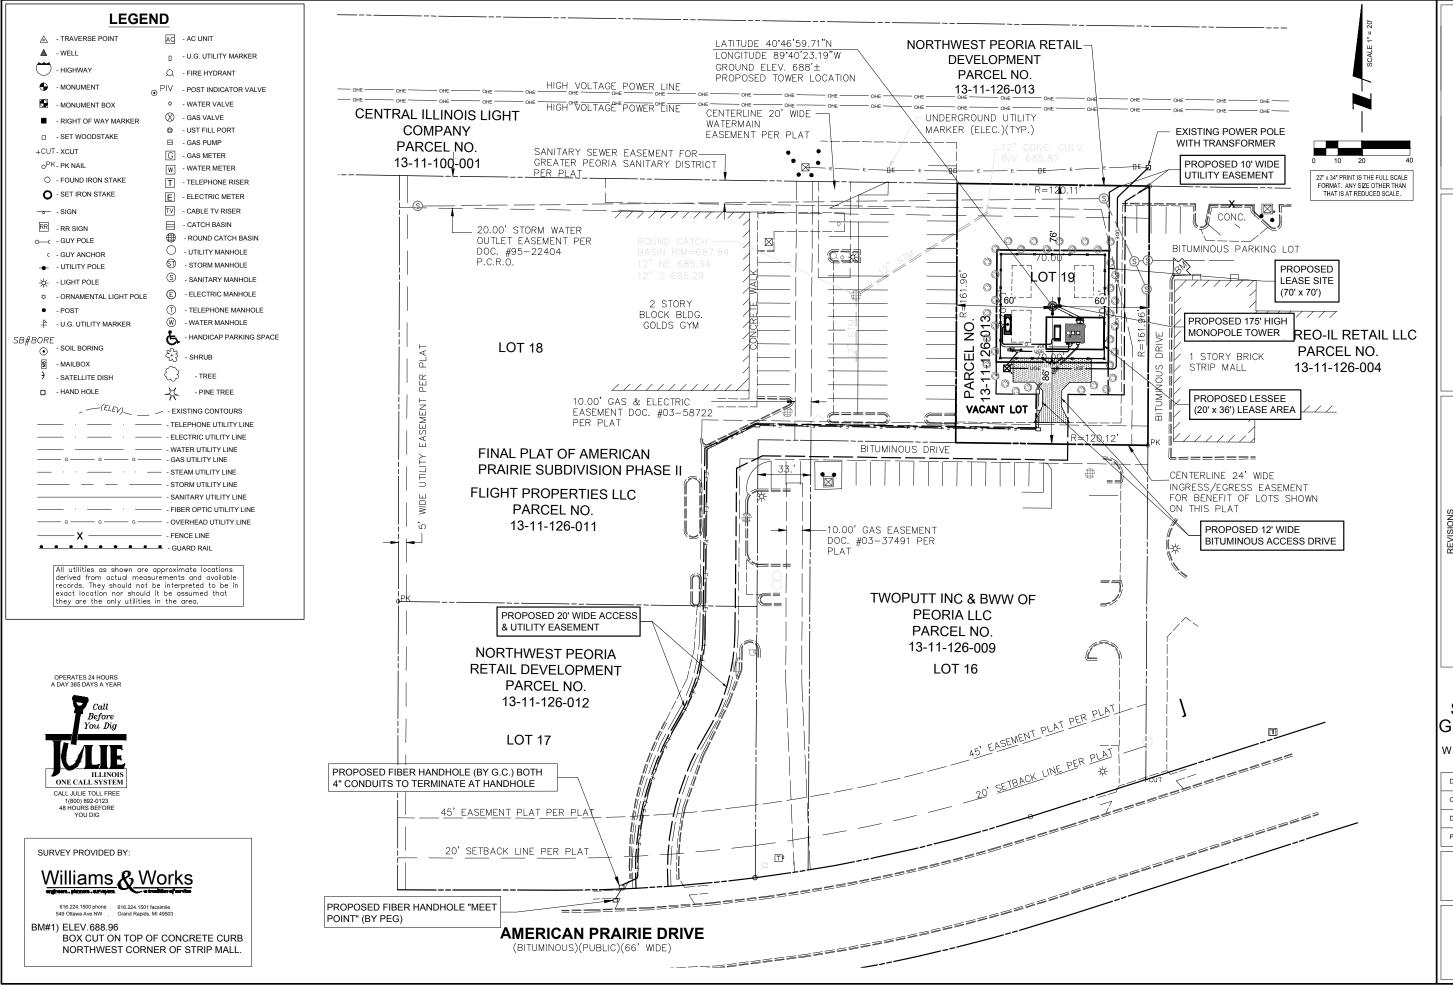

AMERICAN PRAIRIE DRIVE

(BITUMINOUS)(PUBLIC)(66' WIDE)

POINT" (BY PEG)

BM#1) ELEV.688.96

BOX CUT ON TOP OF CONCRETE CURB

NORTHWEST CORNER OF STRIP MALL.





	NO.	DESCRIPTION	DATE	ВУ	
	- :	REVISED PER POWER COORDINATION	12/28/15	MTC	
	2.	ISSUED FOR FIBER COORDINATION	01/18/16	MT	
	ω.	UPDATED TO CABINET LAYOUT	10/23/15	SEA	
	4	UPDATE PER CLIENT COMMENTS	02/08/16	MTL	
	5.	ISSUED FOR FINAL	03/22/16	MTC	
	.9	REMOVED PLATFORM CANOPY	04/04/16	BTE	
	7.	UPDATE PER LL COMMENTS	04/14/16	BTE	
ı					


IL-00-5999 SHOPPES OF **GRAND PRAIRIE**


W AMERICAN PRAIRIE DR **PEORIA, IL 61615**


DRAWN BY:	PP
CHECKED BY:	TAZ
DATE:	07/17/15
PROJECT #:	50-168

LOCATION PLAN

SHEET NUMBER

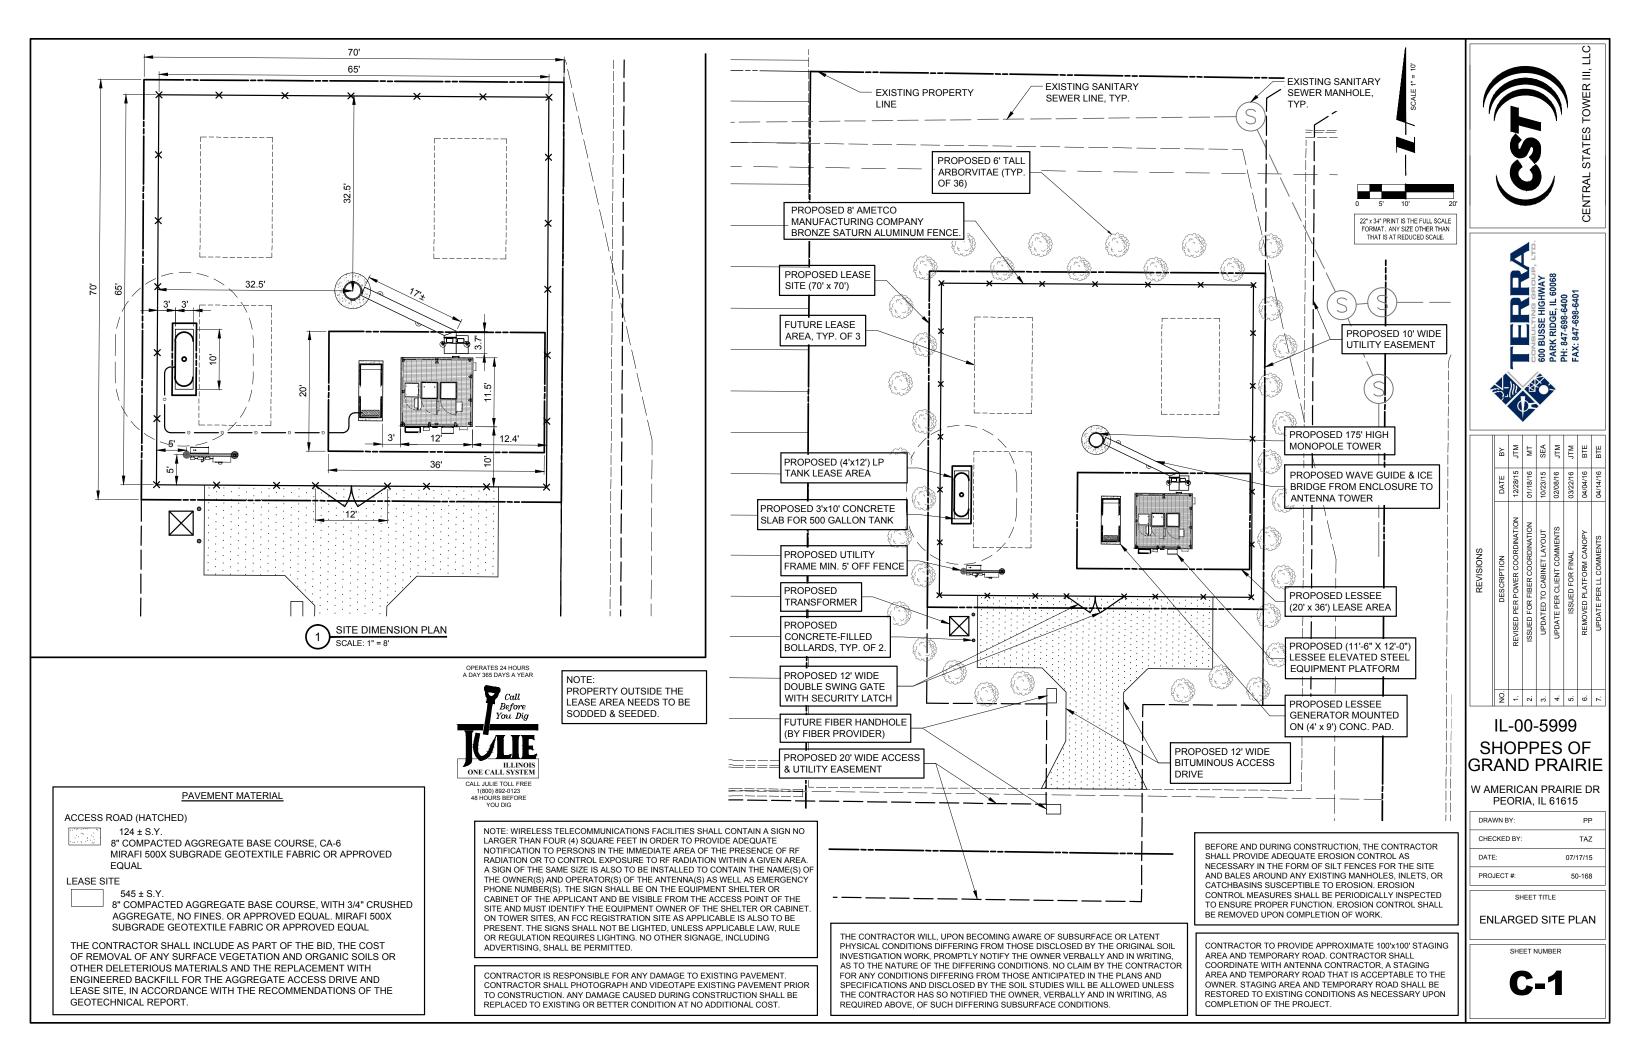

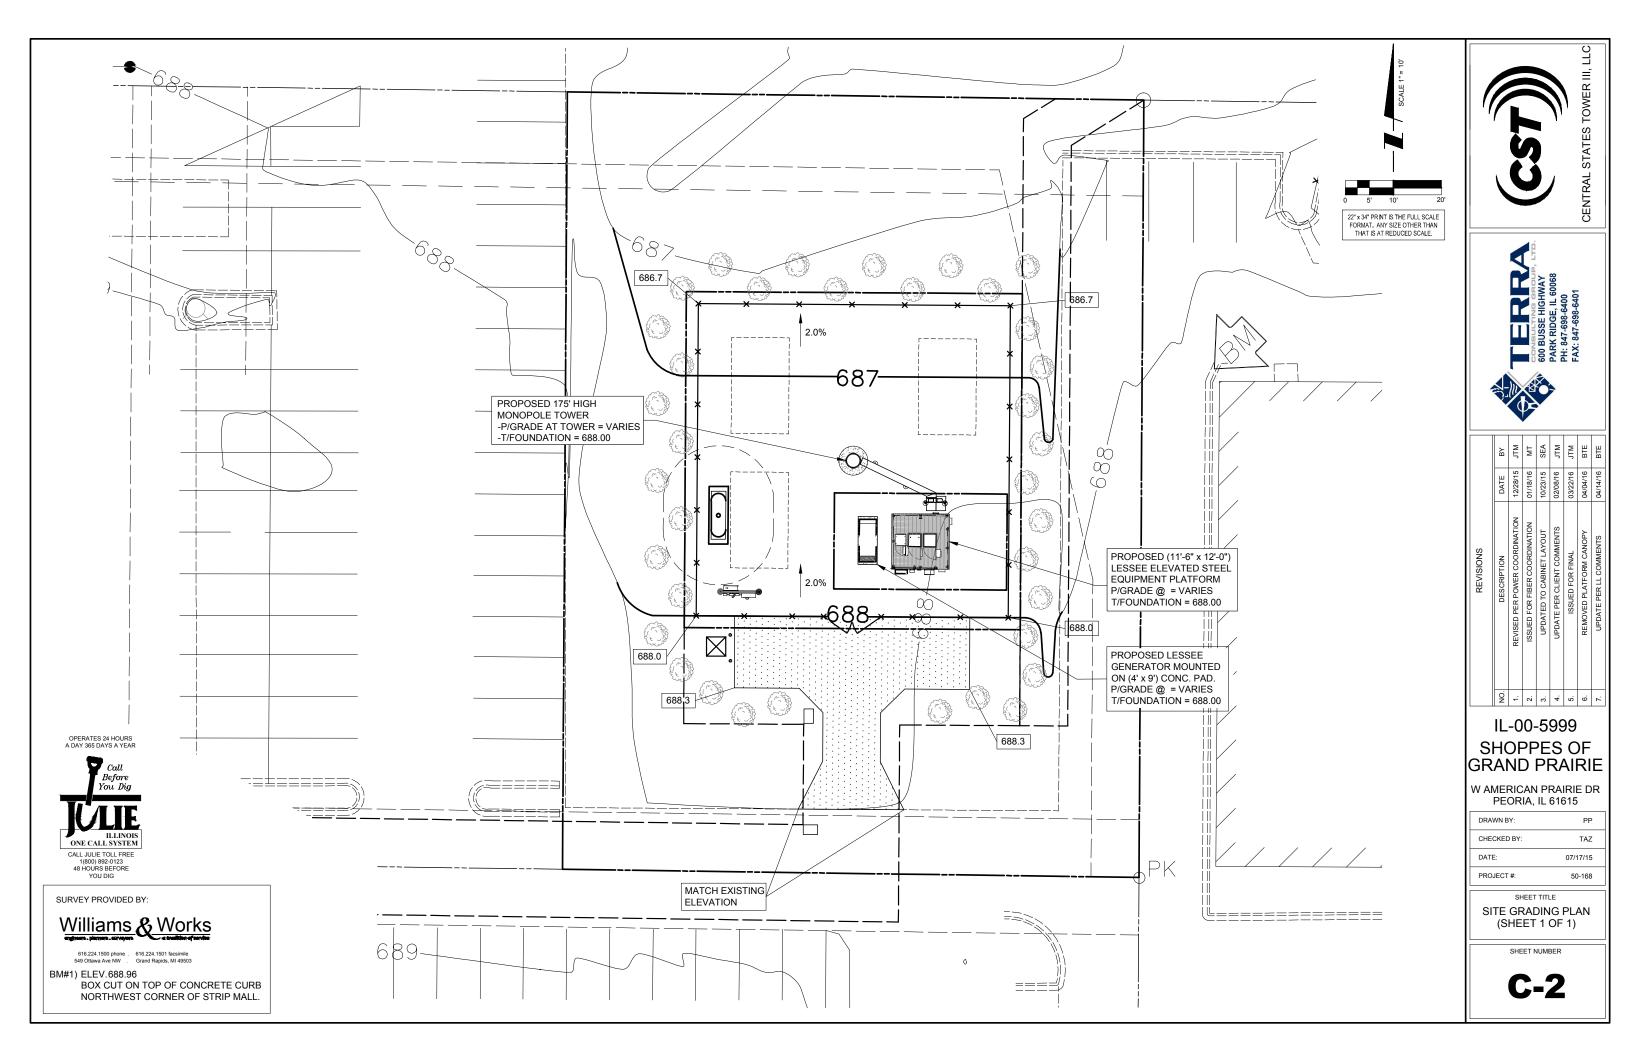

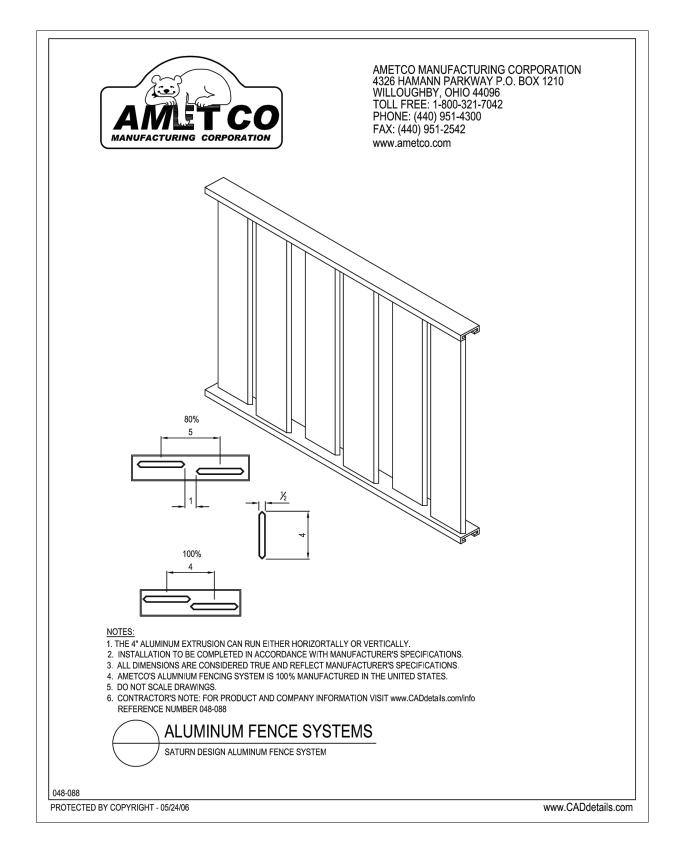





REVISIONS	DESCRIPTION DATE BY	ISSUED FOR REVIEW 07/17/15 PP	REVISED PER POWER COORDINATION 10/23/15 JTM	ISSUED FOR FIBER COORDINATION 12/28/15 MT	UPDATED TO CABINET LAYOUT 01/18/16 SEA	UPDATE PER CLIENT COMMENTS 02/08/16 JTM	ISSUED FOR FINAL 03/22/16 JTM	REMOVED PLATFORM CANOPY 04/04/16 BTE	
	NO.		1.	2.	3.	4.	5.	9.	

IL-00-5999 SHOPPES OF GRAND PRAIRIE

W AMERICAN PRAIRIE DR PEORIA, IL 61615

DRAWN BY:	PP
CHECKED BY:	TAZ
DATE:	07/17/15
PROJECT #:	50-168
	CHECKED BY: DATE:

SHEET TITLE
SITE DETAILS

SHEET NUMBER

SITE WORK GENERAL NOTES:

- 1. THE SUBCONTRACTOR SHALL CONTACT UTILITY LOCATING SERVICES PRIOR TO THE START OF CONSTRUCTION.
- 2. ALL EXISTING ACTIVE SEWER, WATER, GAS, ELECTRIC, AND OTHER UTILITIES WHERE ENCOUNTERED IN THE WORK, SHALL BE PROTECTED AT ALL TIMES, AND WHERE REQUIRED FOR THE PROPER EXECUTION OF THE WORK, SHALL BE RELOCATED AS DIRECTED BY CONTRACTOR. EXTREME CAUTION SHOULD BE USED BY THE SUBCONTRACTOR WHEN EXCAVATING OR DRILLING PIERS AROUND OR NEAR UTILITIES. SUBCONTRACTOR SHALL PROVIDE SAFETY TRAINING FOR THE WORKING CREW. THIS WILL INCLUDE BUT NOT BE LIMITED TO A) FALL PROTECTION B) CONFINED SPACE C) ELECTRICAL SAFETY D) TRENCHING & EXCAVATION.
- 3. ALL SITE WORK SHALL BE AS INDICATED ON THE DRAWINGS AND PROJECT SPECIFICATIONS.
- 4. IF NECESSARY, RUBBISH, STUMPS, DEBRIS, STICKS, STONES AND OTHER REFUSE SHALL BE REMOVED FROM THE SITE AND DISPOSED OF LEGALLY.
- 5. ALL EXISTING INACTIVE SEWER, WATER, GAS, ELECTRIC AND OTHER UTILITIES, WHICH INTERFERE WITH THE EXECUTION OF THE WORK, SHALL BE REMOVED AND/OR CAPPED, PLUGGED OR OTHERWISE DISCONTINUED AT POINTS WHICH WILL NOT INTERFERE WITH THE EXECUTION OF THE WORK, SUBJECT TO THE APPROVAL OF CONTRACTOR, OWNER AND/OR LOCAL UTILITIES.
- 6. SUBCONTRACTOR SHALL MINIMIZE DISTURBANCE TO EXISTING SITE DURING CONSTRUCTION
- 7. THE SUBCONTRACTOR SHALL PROVIDE SITE SIGNAGE IN ACCORDANCE WITH THE TECHNICAL SPECIFICATION FOR SITE SIGNAGE.
- 8. THE SITE SHALL BE GRADED TO CAUSE SURFACE WATER TO FLOW AWAY FROM THE BTS EQUIPMENT AND TOWER AREAS.
- 9. NO FILL OR EMBANKMENT MATERIAL SHALL BE PLACED ON FROZEN GROUND. FROZEN MATERIALS, SNOW OR ICE SHALL NOT BE PLACED IN ANY FILL OR EMBANKMENT.
- 10. THE SUB GRADE SHALL BE COMPACTED AND BROUGHT TO A SMOOTH UNIFORM GRADE PRIOR TO FINISHED SURFACE APPLICATION.

 11. THE AREAS OF THE OWNERS PROPERTY DISTURBED BY THE WORK AND NOT COVERED BY THE TOWER, EQUIPMENT OR DRIVEWAY, SHALL BE GRADED TO A UNIFORM SLOPE, AND STABILIZED TO PREVENT EROSION AS SPECIFIED IN THE PROJECT SPECIFICATIONS.
- 12. SUBCONTRACTOR SHALL MINIMIZE DISTURBANCE TO EXISTING SITE DURING CONSTRUCTION. EROSION CONTROL MEASURES, IF REQUIRED DURING CONSTRUCTION, SHALL BE IN CONFORMANCE WITH THE LOCAL GUIDELINES FOR EROSION AND SEDIMENT CONTROL.
- 13. ALL REMOVED SPOILS TO BE UTILIZED FOR BACKFILL SHALL BE PROTECTED FROM FREEZE

STRUCTURAL STEEL NOTES:

- 1. ALL STEEL WORK SHALL BE PAINTED IN ACCORDANCE WITH THE PROJECT SPECIFICATIONS AND IN ACCORDANCE WITH ASTM A36 UNLESS OTHERWISE NOTED.
- 2. ALL WELDING SHALL BE PERFORMED USING E70XX ELECTRODES AND WELDING SHALL CONFORM TO AISC. WHERE FILLET WELD SIZES ARE NOT SHOWN, PROVIDE THE MINIMUM SIZE PER TABLE J2.4 IN THE AISC "MANUAL OF STEEL CONSTRUCTION". PAINTED SURFACES SHALL BE TOLICHED UP
- 3. BOLTED CONNECTIONS SHALL BE ASTM A325 BEARING TYPE (3/4"Ø) CONNECTIONS AND SHALL HAVE MINIMUM OF TWO BOLTS UNLESS NOTED OTHERWISE.
- 4. NON-STRUCTURAL CONNECTIONS FOR STEEL GRATING MAY USE 5/8" DIA. ASTM A 307 BOLTS UNLESS NOTED OTHERWISE.
- 5. INSTALLATION OF CONCRETE EXPANSION/WEDGE ANCHOR, SHALL BE PER MANUFACTURER'S WRITTEN RECOMMENDED PROCEDURE. THE ANCHOR BOLT, DOWEL OR ROD SHALL CONFORM TO MANUFACTURER'S RECOMMENDATION FOR EMBEDMENT DEPTH OR AS SHOWN ON THE DRAWINGS. NO REBAR SHALL BE CUT WITHOUT PRIOR CONTRACTOR APPROVAL WHEN DRILLING HOLES IN CONCRETE. SPECIAL INSPECTIONS, REQUIRED BY GOVERNING CODES, SHALL BE PERFORMED IN ORDER TO MAINTAIN MANUFACTURER'S MAXIMUM ALLOWABLE LOADS.

CONCRETE AND REINFORCING STEEL NOTES:

- ALL CONCRETE WORK SHALL BE IN ACCORDANCE WITH THE ACI 301, ACI 318, ACI 336, ASTM A184, ASTM A185 AND THE DESIGN AND CONSTRUCTION SPECIFICATION FOR CAST-IN-PLACE CONCRETE.
- 2. ALL CONCRETE SHALL HAVE A MINIMUM COMPRESSIVE STRENGTH OF 4000 PSI AT 28 DAYS, UNLESS NOTED OTHERWISE. SLAB FOUNDATION DESIGN ASSUMING ALLOWABLE SOIL BEARING PRESSURE OF 2000 PSF.
- 3. REINFORCING STEEL SHALL CONFORM TO ASTM A 615, GRADE 60, DEFORMED UNLESS NOTED OTHERWISE. WELDED WIRE FABRIC SHALL CONFORM TO ASTM A 185 WELDED STEEL WIRE FABRIC UNLESS NOTED OTHERWISE. SPLICES SHALL BE CLASS "B" AND ALL HOOKS SHALL BE STANDARD, UNO.
- 4. THE FOLLOWING MINIMUM CONCRETE COVER SHALL BE PROVIDED FOR REINFORCING STEEL UNLESS SHOWN OTHERWISE ON DRAWINGS:

CONCRETE NOT EXPOSED TO EARTH OR WEATHER OR NOT CAST AGAINST THE GROUND:

SLAB AND WALL3/4 II BEAMS AND COLUMNS1 1/2

- 5. A CHAMFER 3/4" SHALL BE PROVIDED AT ALL EXPOSED EDGES OF CONCRETE, UNO, IN ACCORDANCE WITH ACI 301 SECTION 4.2.4.
- 6. INSTALLATION OF CONCRETE EXPANSION/WEDGE ANCHOR, SHALL BE PER MANUFACTURER'S WRITTEN RECOMMENDED PROCEDURE. THE ANCHOR BOLT, DOWEL OR ROD SHALL CONFORM TO MANUFACTURER'S RECOMMENDATION FOR EMBEDMENT DEPTH OR AS SHOWN ON THE DRAWINGS. NO REBAR SHALL BE CUT WITHOUT PRIOR ENGINEERING APPROVAL WHEN DRILLING HOLES ON CONCRETE. EXPANSION BOLTS SHALL BE PROVIDED BY RAMSET/REDHEAD OR APPROVED EQUAL.
- 7. COLD WEATHER CONCRETING (BELOW 40°). SHALL COMPLY WITH ACI 301. CONTRACTOR SHALL NEVER PLACE CONCRETE ON FROZEN SUBGRADE AND REBAR TEMPERATURE SHALL NEVER BE BELLOW 32°F DURING CONCRETE PLACEMENT. STEEL TEMPERATURE CAN BE RAISED BY BATHING IT IN WATER UNTIL ICE DOES NOT FORM ON BARS. CONCRETE MATERIALS MAY BE HEATED, BUT MIX TEMPERATURE SHALL BE BETWEEN 50°F & 70°F AT TIME OF PLACING. ALL CONCRETE EXPOSED TO FREEZING DURING PLACEMENT OR DURING SERVICE LIFE SHALL BE AIR ENTRAINED. INSULATED BLANKETS (OR APPROVED EQUAL METHOD) SHALL BE PLACED OVER FRESHLY FINISHED CONCRETE TO ALLOW PROPER CURING/COMBAT FREEZING. THE CONCRETE TEMP. SHOULD BE MAINTAINED AT 50°F FOR FIVE (5) DAYS OR 70° FOR THREE (3) DAYS. CONCRETE SHALL NOT BE ALLOWED TO FREEZE BEFORE IT HAS REACHED A STRENGTH OF AT LEAST 500 PSI

GENERAL NOTES

- FOR THE PURPOSE OF CONSTRUCTION DRAWING, THE FOLLOWING DEFINITIONS SHALL APPLY:
 CONTRACTOR TO BE DETERMINED
 SUBCONTRACTOR GENERAL CONTRACTOR (CONSTRUCTION)
 OWNER CENTRAL STATES TOWERS
 OEM ORIGINAL EQUIPMENT MANUFACTURE
- 2. PRIOR TO THE SUBMISSION OF BIDS, THE BIDDING SUBCONTRACTOR SHALL VISIT THE CELL SITE TO FAMILIARIZE WITH THE EXISTING CONDITIONS AND TO CONFIRM THAT THE WORK CAN BE ACCOMPLISHED AS SHOWN ON THE CONSTRUCTION DRAWINGS. ANY DISCREPANCY FOUND SHALL BE BROUGHT TO THE ATTENTION OF CONTRACTOR.
- 3. ALL MATERIALS FURNISHED AND INSTALLED SHALL BE IN STRICT ACCORDANCE WITH ALL APPLICABLE CODES, REGULATIONS, AND ORDINANCES. SUBCONTRACTOR SHALL ISSUE ALL APPROPRIATE NOTICES AND COMPLY WITH ALL LAWS, ORDINANCES, RULES, REGULATIONS, AND LAWFUL ORDERS OF ANY PUBLIC AUTHORITY REGARDING THE PERFORMANCE OF THE WORK. ALL WORK CARRIED OUT SHALL COMPLY WITH ALL APPLICABLE MUNICIPAL AND UTILITY COMPANY SPECIFICATIONS AND LOCAL JURISDICTIONAL CODES, ORDINANCES AND APPLICABLE REGULATIONS.
- 4. DRAWINGS PROVIDED HERE ARE NOT TO SCALE AND ARE INTENDED TO SHOW OUTLINE ONLY.
- 5. UNLESS NOTED OTHERWISE, THE WORK SHALL INCLUDE FURNISHING MATERIALS, EQUIPMENT, APPURTENANCES, AND LABOR NECESSARY TO COMPLETE ALL INSTALLATIONS AS INDICATED ON THE DRAWINGS.
- THE SUBCONTRACTOR SHALL INSTALL ALL EQUIPMENT AND MATERIALS IN ACCORDANCE WITH MANUFACTURER'S RECOMMENDATIONS UNLESS SPECIFICALLY STATED OTHERWISE.
- 7. IF THE SPECIFIED EQUIPMENT CANNOT BE INSTALLED AS SHOWN ON THESE DRAWINGS, THE SUBCONTRACTOR SHALL PROPOSE AN ALTERNATIVE INSTALLATION FOR APPROVAL BY THE CONTRACTOR.
- 8. SUBCONTRACTOR SHALL DETERMINE ACTUAL ROUTING OF CONDUIT, POWER AND T1 CABLES, GROUNDING CABLES AS SHOWN ON THE POWER, GROUNDING AND TELCO PLAN DRAWING.
- 9. THE SUBCONTRACTOR SHALL PROTECT EXISTING IMPROVEMENTS, PAVEMENTS, CURBS, LANDSCAPING AND STRUCTURES. ANY DAMAGED PART SHALL BE REPAIRED AT SUBCONTRACTOR'S EXPENSE TO THE SATISFACTION OF OWNER.
- 10. SUBCONTRACTOR SHALL LEGALLY AND PROPERLY DISPOSE OF ALL SCRAP MATERIALS SUCH AS COAXIAL CABLES AND OTHER ITEMS REMOVED FROM THE EXISTING FACILITY. ANTENNAS REMOVED SHALL BE RETURNED TO THE OWNER'S DESIGNATED LOCATION.
- 11. SUBCONTRACTOR SHALL LEAVE PREMISES IN CLEAN CONDITION.
- 12. CONSTRUCTION SHALL COMPLY WITH "GENERAL CONSTRUCTION SERVICES FOR CONSTRUCTION OF CINGULAR GSM SITES."

APPLICABLE BUILDING CODES AND STANDARDS:

SUBCONTRACTOR'S WORK SHALL COMPLY WITH ALL APPLICABLE NATIONAL, STATE, AND LOCAL CODES AS ADOPTED BY THE LOCAL AUTHORITY HAVING JURISDICTION (AHJ) FOR THE LOCATION. THE EDITION OF THE AHJ ADOPTED CODES AND STANDARDS IN EFFECT ON THE DATE OF CONTRACT AWARD SHALL GOVERN THE DESIGN.

2003 INTERNATIONAL BUILDING CODE (2003 IBC OR LATEST EDITION)

2008 NATIONAL ELECTRICAL CODE (NEC 2008)

UNDERWRITER LABORATORIES APPROVED ELECTRICAL PRODUCTS LIFE SAFETY CODE NFPA-101 SUBCONTRACTOR'S WORK SHALL COMPLY WITH THE LATEST EDITION OF THE FOLLOWING

AMERICAN CONCRETE INSTITUTE (ACI) 318, BUILDING CODE REQUIREMENTS FOR STRUCTURAL AMERICAN INSTITUTE OF STEEL CONSTRUCTION (AISC), MANUAL OF STEEL CONSTRUCTION, ASD.

TELECOMMUNICATIONS INDUSTRY ASSOCIATION (TIA) EIA-222-G, EXPOSURE CATEGORY C, STRUCTURE CLASS II, TOPO CATEGORY 1. STRUCTURAL STANDARD FOR STRUCTURAL ANTENNA TOWER AND ANTENNA SUPPORTING STRUCTURES.

INSTITUTE FOR ELECTRICAL AND ELECTRONICS ENGINEERS (IEEE) 81, GUIDE FOR MEASURING EARTH RESISTIVITY, GROUND IMPEDANCE, AND SURFACE POTENTIALS OF A GROUND SYSTEM IEEE 1100 (1999) RECOMMENDED PRACTICE FOR POWERING AND GROUNDING OF ELECTRONICS IEEE C62.41, RECOMMENDED PRACTICES ON SURGE VOLTAGES IN LOW VOLTAGE AC POWER CIRCUITS (FOR LOCATION CATEGORY "C3" AND HIGH SYSTEM EXPOSURE")

TIA 607 COMMERCIAL BUILDING GROUNDING AND BONDING REQUIREMENTS FOR TELCORDIA GR-1503 COAXIAL CABLE CONNECTIONS

FOR ANY CONFLICTS BETWEEN SECTIONS OF LISTED CODES AND STANDARDS REGARDING MATERIAL, METHODS OF CONSTRUCTION, OR OTHER REQUIREMENTS, THE MOST RESTRICTIVE REQUIREMENTS SHALL GOVERN. WHERE THERE IS CONFLICT BETWEEN GENERAL REQUIREMENTS AND A SPECIFIC REQUIREMENT, THE SPECIFIC REQUIREMENT SHALL GOVERN.





DESCRIPTION DATE ISSUED FOR REVIEW 07/17/15 REVISED PER POWER COORDINATION 10/23/15
ISSUED FOR FIBER COORDINATION 12/28/15
UPDATED TO CABINET LAYOUT 01/18/16
UPDATE PER CLIENT COMMENTS 02/08/16
ISSUED FOR FINAL 03/22/16
REMOVED PLATFORM CANOPY 04/04/16


IL-00-5999 SHOPPES OF GRAND PRAIRIE

W AMERICAN PRAIRIE DR PEORIA, IL 61615

DRAWN BY:	PP
CHECKED BY:	TAZ
DATE:	07/17/15
PROJECT #:	50-168


SHEET TITLE

GENERAL NOTES

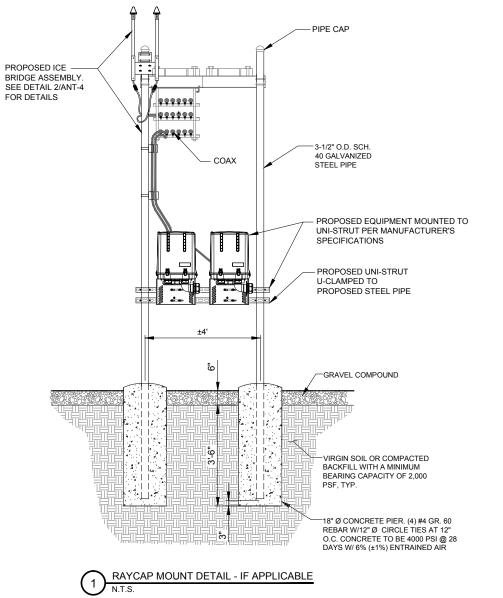


OPERATES 24 HOURS A DAY 365 DAYS A YEAR

CALL JULIE TOLL FREE 1(800) 892-0123 48 HOURS BEFORE YOU DIG

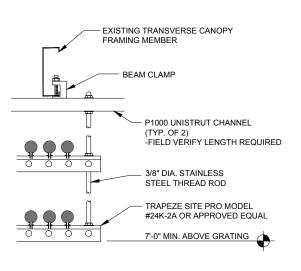

2 COAX TRAPEZE DETAIL (AT PLATFORM)
N.T.S.

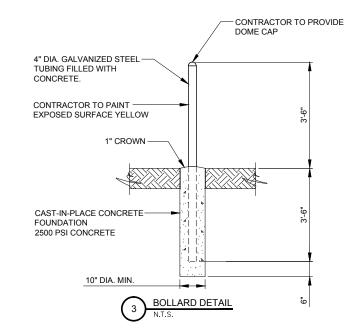





	ВУ	ЬР	MTC	MT	SEA	MTC	MTC	BTE	
	DATE	07/17/15	10/23/15	12/28/15	01/18/16	02/08/16	03/22/16	04/04/16	
REVISIONS	DESCRIPTION	ISSUED FOR REVIEW	REVISED PER POWER COORDINATION	ISSUED FOR FIBER COORDINATION	UPDATED TO CABINET LAYOUT	UPDATE PER CLIENT COMMENTS	ISSUED FOR FINAL	REMOVED PLATFORM CANOPY	
	NO.		1.	2.	3.	4.	5.	6.	
		_	_	_					ı


IL-00-5999 SHOPPES OF GRAND PRAIRIE

W AMERICAN PRAIRIE DR PEORIA, IL 61615

DRAWN BY:	PP
CHECKED BY:	TAZ
DATE:	07/17/15
PROJECT #:	50-168

SHEET TITLE
SITE DETAILS

SHEET NUMBER

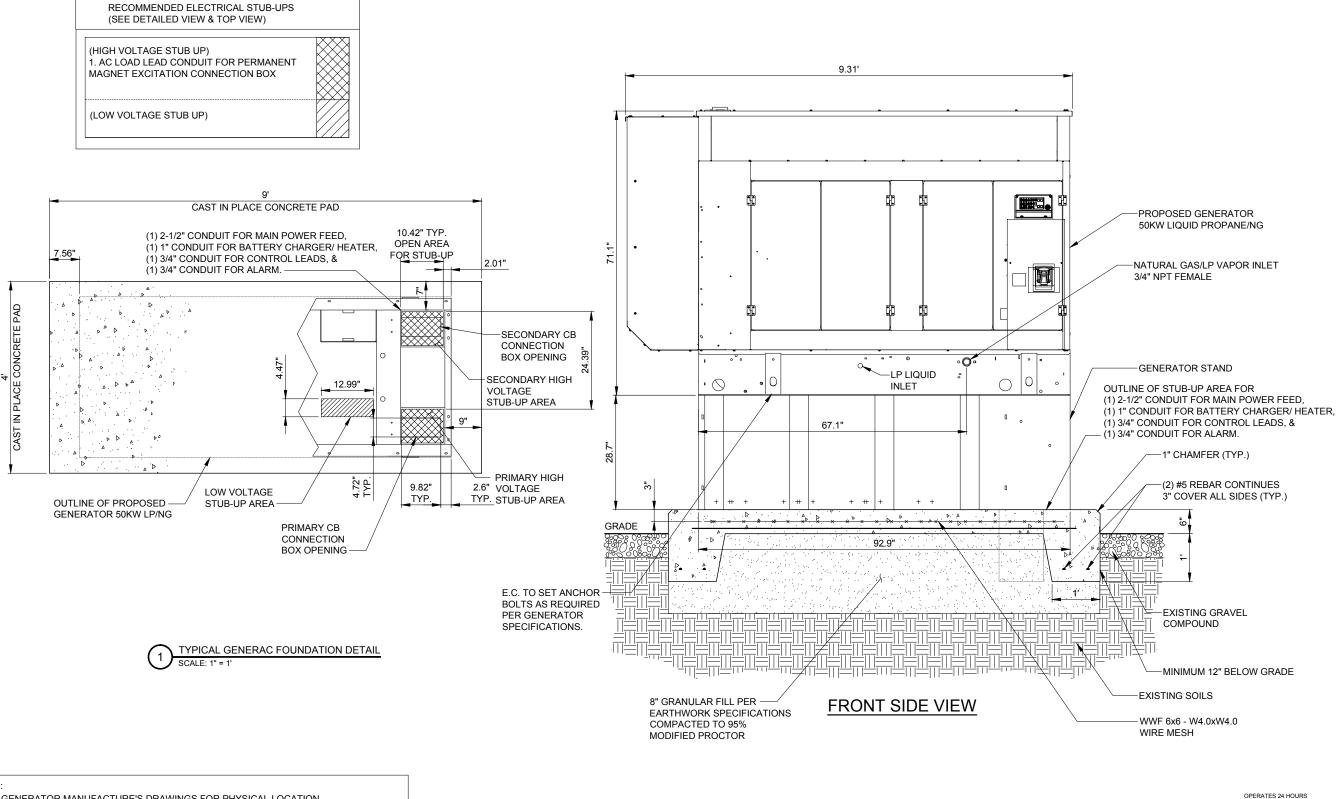

NOTES:

- 1. SEE GENERATOR MANUFACTURE'S DRAWINGS FOR PHYSICAL LOCATION OF FUEL LINES, CONTROL AND POWER INTERCONNECTIONS AND OTHER INTERFACES THAT ARE TO CAST INTO THE CONCRETE. THE PREFERRED METHOD IS TO BRING THE CONDUIT THROUGH THE PAD TO THE UNDERSIDE OF THE GENERATOR (MINIMIZES RODENT DAMAGE). FINISH CONNECTIONS WITH FLEXIBLE CONDUIT PER GENERATOR MANUFACTURES SPECS. RIGID CONDUITS SHALL BE SECURED TO THE EXISTING SLAB, THEN BURIED BETWEEN SLAB AND SHELTER.
- -THE GENERATOR SHALL BE LOCATED A MIN 5' AWAY FROM A COMBUSTIBLE WALL.
 -THE GENERATOR SHALL BE LOCATED A MIN OF 3' AWAY FROM A NON-COMBUSTIBLE WALL.







	ВУ	윤	MTC	MT	SEA	MTC	MTC	BTE
	DATE	07/17/15	10/23/15	12/28/15	01/18/16	02/08/16	03/22/16	04/04/16
REVISIONS	DESCRIPTION	ISSUED FOR REVIEW	REVISED PER POWER COORDINATION	ISSUED FOR FIBER COORDINATION	UPDATED TO CABINET LAYOUT	UPDATE PER CLIENT COMMENTS	ISSUED FOR FINAL	REMOVED PLATFORM CANOPY
	Š.		-	2.	က်	4.	5.	9

IL-00-5999 SHOPPES OF GRAND PRAIRIE


W AMERICAN PRAIRIE DR PEORIA, IL 61615


DRAWN BY:	PP
CHECKED BY:	TAZ
DATE:	07/17/15
PROJECT #:	50-168


SHEET TITLE
GENERATOR
FOUNDATION DETAILS


SHEET NUMBER

1(800) 892-0123 48 HOURS BEFORE YOU DIG

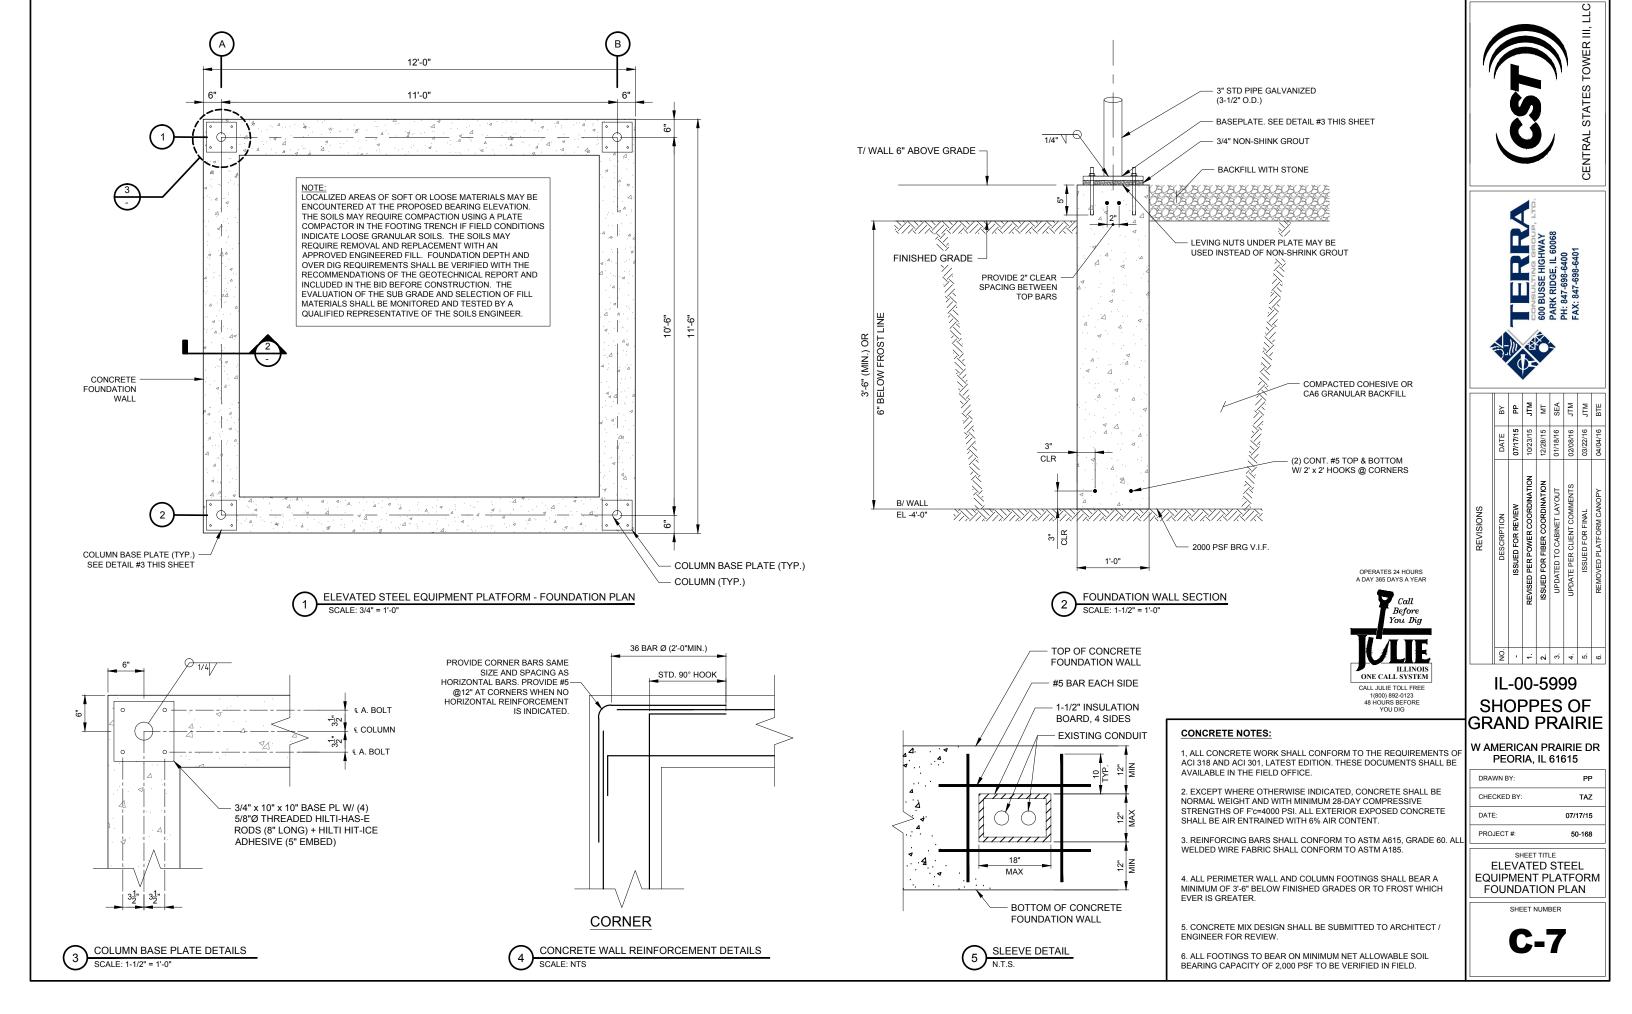

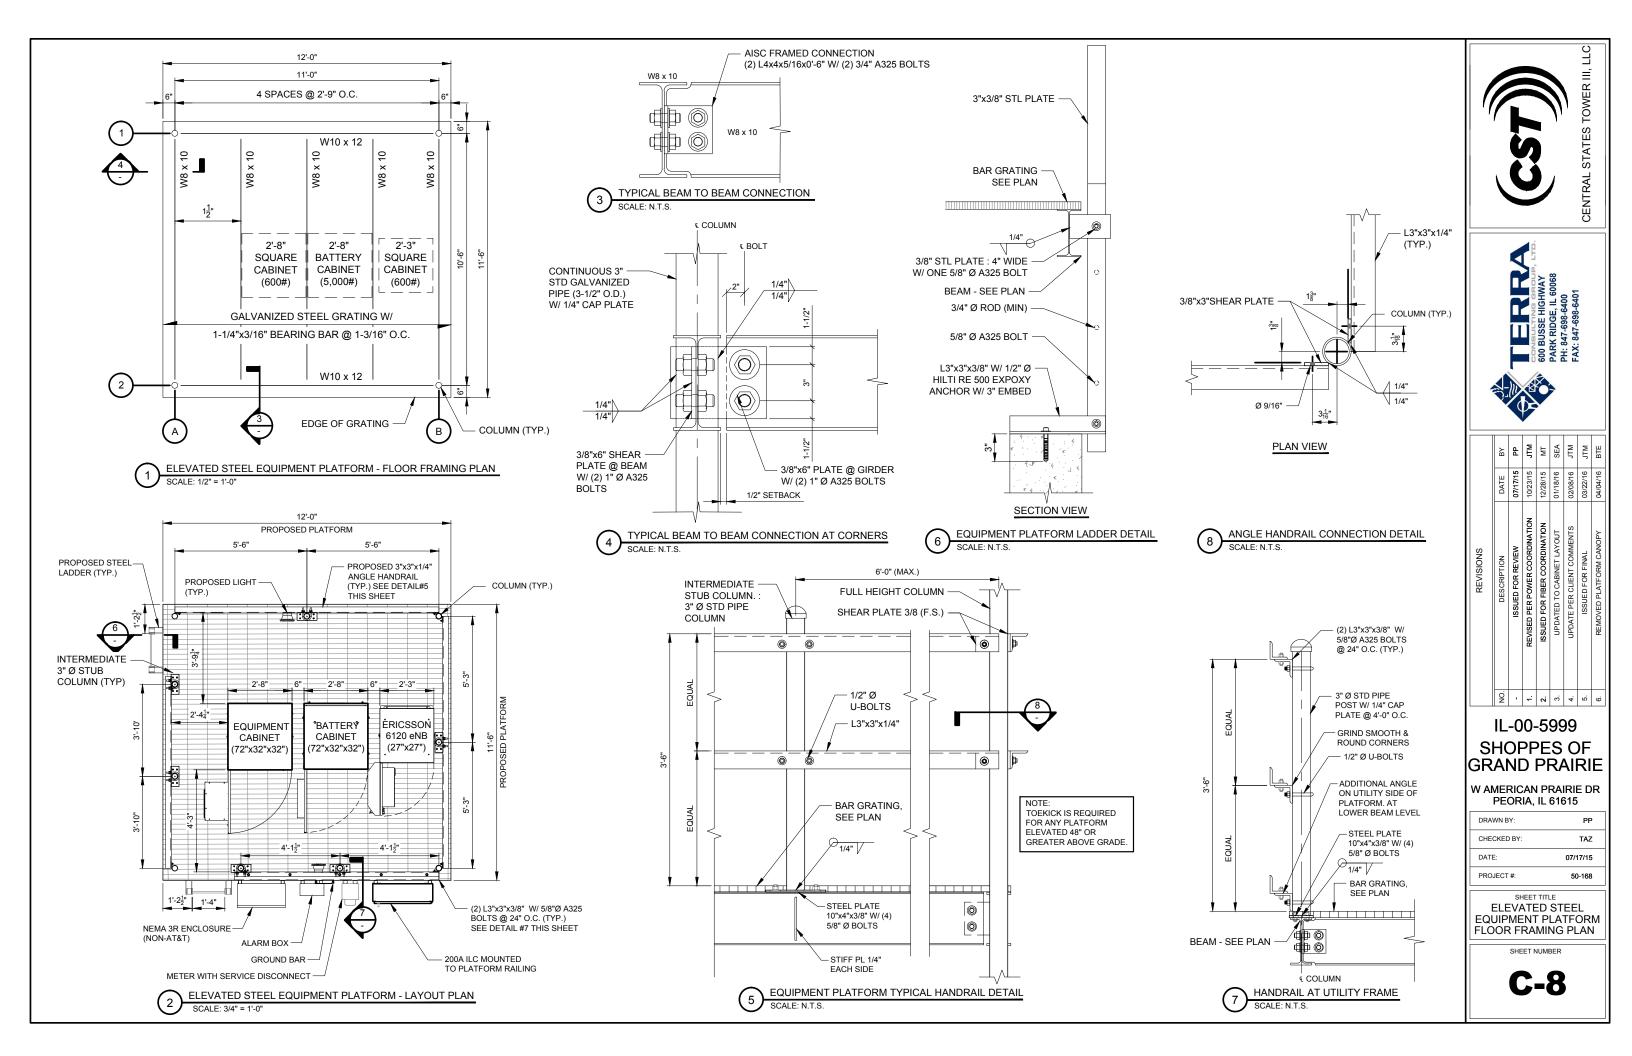

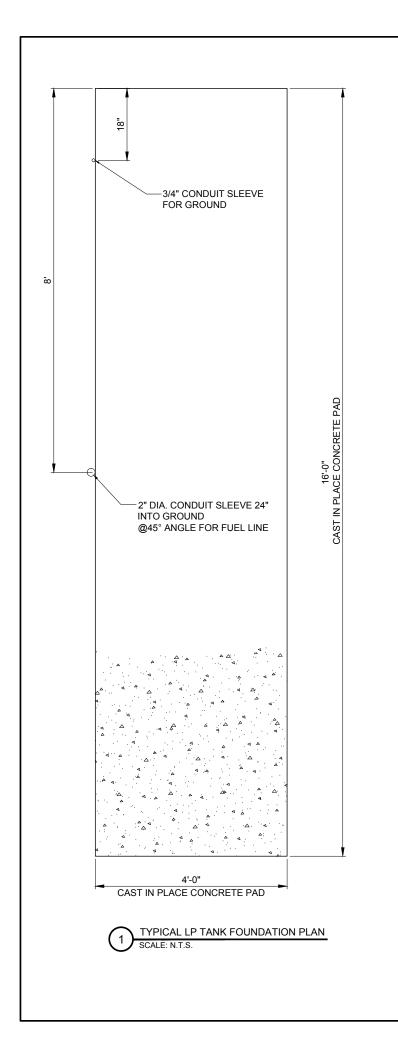

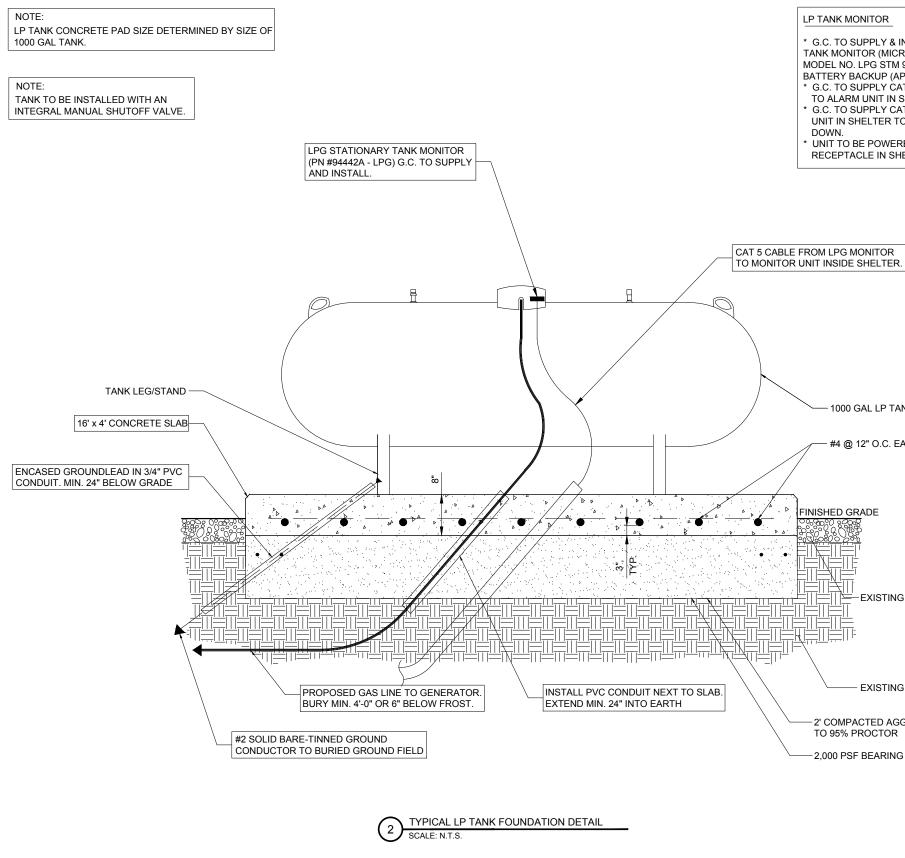

LP TANK MONITOR

- G.C. TO SUPPLY & INSTALL PROPANE TANK MONITOR (MICRO-DESIGN, INC., MODEL NO. LPG STM 94442A) WITH A BATTERY BACKUP (APC MODEL ES 350).
- * G.C. TO SUPPLY CAT 5 FROM UNIT TO ALARM UNIT IN SHELTER.
- G.C. TO SUPPLY CAT 5 FROM ALARM UNIT IN SHELTER TO ALARM PUNCH

- 1000 GAL LP TANK, ASSUMED

-EXISTING COMPOUND

EXISTING SOILS

2' COMPACTED AGGREGATE TO 95% PROCTOR

-2,000 PSF BEARING

- #4 @ 12" O.C. EACH WAY

INISHED GRADE

* UNIT TO BE POWERED FROM RECEPTACLE IN SHELTER.



									1
	ВУ	Ь	MTC	MT	SEA	MTC	MTC	BTE	
	DATE	07/17/15	10/23/15	12/28/15	01/18/16	02/08/16	03/22/16	04/04/16	
REVISIONS	DESCRIPTION	ISSUED FOR REVIEW	REVISED PER POWER COORDINATION	ISSUED FOR FIBER COORDINATION	UPDATED TO CABINET LAYOUT	UPDATE PER CLIENT COMMENTS	ISSUED FOR FINAL	REMOVED PLATFORM CANOPY	
	NO.	•	-	2.	က်	4	5.	9	ı

IL-00-5999 SHOPPES OF GRAND PRAIRIE

W AMERICAN PRAIRIE DR PEORIA, IL 61615

ı	DRAWN BY:	PP
ı	CHECKED BY:	TAZ
ı	DATE:	07/17/15
ı	PROJECT #:	50-168

LP TANK DETAILS

SHEET NUMBER



SCALE: 3/32"=1'-0"

22" x 34" PRINT IS THE FULL SCALE FORMAT. ANY SIZE OTHER THAN THAT IS AT REDUCED SCALE.





	ВУ	MF	MT	SEA	MTC	MTC	BTE	BTE	
	DATE	12/28/15	01/18/16	10/23/15	02/08/16	03/22/16	04/04/16	04/14/16	
REVISIONS	DESCRIPTION	REVISED PER POWER COORDINATION	ISSUED FOR FIBER COORDINATION	UPDATED TO CABINET LAYOUT	UPDATE PER CLIENT COMMENTS	ISSUED FOR FINAL	REMOVED PLATFORM CANOPY	UPDATE PER LL COMMENTS	
	NO.	-	2.	3.	4	5.	.9	7.	I
									1

IL-00-5999 SHOPPES OF GRAND PRAIRIE


W AMERICAN PRAIRIE DR PEORIA, IL 61615

DRAWN BY:	PP
CHECKED BY:	TAZ
DATE:	07/17/15
PROJECT #:	50-168

SITE ELEVATION

OUEST NUMBER

ANT-1

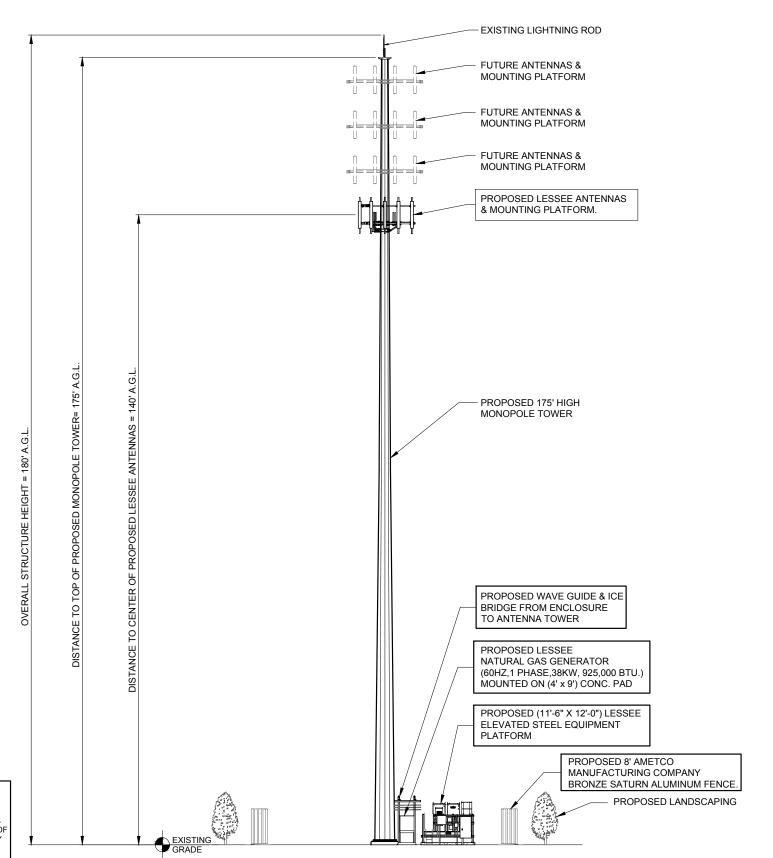

NOTE: WIRELESS TELECOMMUNICATIONS FACILITIES SHALL CONTAIN A SIGN NO LARGER THAN FOUR (4) SQUARE FEET IN ORDER TO PROVIDE ADEQUATE NOTIFICATION TO PERSONS IN THE IMMEDIATE AREA OF THE PRESENCE OF RF RADIATION OR TO CONTROL EXPOSURE TO RF RADIATION WITHIN A GIVEN AREA. A SIGN OF THE SAME SIZE IS ALSO TO BE INSTALLED TO CONTAIN THE NAME(S) OF THE OWNER(S) AND OPERATOR(S) OF THE ANTENNA(S) AS WELL AS EMERGENCY PHONE NUMBER(S). THE SIGN SHALL BE ON THE EQUIPMENT SHELTER OR CABINET OF THE APPLICANT AND BE VISIBLE FROM THE ACCESS POINT OF THE SITE AND MUST IDENTIFY THE EQUIPMENT OWNER OF THE SHELTER OR CABINET. ON TOWER SITES, AN FCC REGISTRATION SITE AS APPLICABLE IS ALSO TO BE PRESENT. THE SIGNS SHALL NOT BE LIGHTED, UNLESS APPLICABLE LAW, RULE OR REGULATION REQUIRES LIGHTING. NO OTHER SIGNAGE, INCLUDING ADVERTISING, SHALL BE PERMITTED.



ESTIMATI	NGTH	
ANTENNA CENTERLINE (±)	ICE BRIDGE LENGTH (±)	TOTAL (±)
140'	20'	160'

	on Nur		Shoppes of Grand Prair	RF Engineer	Matthew From			Cell ID Address			520 (5121 W America
Date o	f Requ	est	5/15/2015	PROPOSED CONFIG	Springfield			City/State	<i>/Zip</i> suration		a, IL, 61615 tion-A2
		Ante	nna	PROPOSED CONFIG	UKATION			Conne	uration	Οp	tion-A2
Sector	Pos	Port	RF Path	Antenna Manufacturer	Antenna Model	Antenna Serial Number	Centerline	Azimuth	Variable Tilt	Mechanical Tilt	Action
Sector	FUS	L1 (-45)	LTE C - RxTx0	Antenna Manuacturei	Aliterina model	Number	Centernine	Azimum		TIIL	Action
		L2 (+45)	LTE C - RxTx1						4		
	A1	H1 (-45)	AWS - Rx3	AMPHENOL	CWX063X25G00		140	0	2	0	Add-Install
	1	H2 (+45)	AWS - Rx4		31110007ab3000		1.0				
		H3 (-45) H4 (+45)	PCS - RxTx0	_					2		
		L1 (-45)	PCS - RxTx1 Unused at this time								
		L2 (+45)	Unused at this time								
	A2	H1 (-45)	Unused at this time								
		H2 (+45)	Unused at this time								
ā		H1 (-45)	Unused at this time	_							
Alpha		H2 (+45) L1 (-45)	Unused at this time Unused at this time								
⋖		L2 (+45)	Unused at this time								
	A3	H1 (-45)	Unused at this time								
	As	H2 (+45)	Unused at this time								
		H1 (-45)	Unused at this time								
		H2 (+45) L1 (-45)	Unused at this time								
		L1 (-45)	LTE C - RX4	-					4		
		H1 (-45)	AWS - RxTx0	⊣				_		_	
	A4	H2 (+45)	AWS - RxTx1	AMPHENOL	CWX063X25G00		140	0	2	0	Add-Install
		H1 (-45)	PCS - RxT2						2		
		H2 (+45)	PCS - RxT3						-		
		L1 (-45)	LTE C - RxTx0						4		
		L2 (+45)	LTE C - RxTx1						4		
	A1	H1 (-45)	AWS - Rx3	AMPHENOL	CWX063X25G00		140	120	2	0	Add-Install
		H2 (+45) H3 (-45)	AWS - Rx4	_							
		H3 (-45)	PCS - RxTx0 PCS - RxTx1						2		
		L1 (-45)	Unused at this time								
		L2 (+45)	Unused at this time								
	A2	H1 (-45)	Unused at this time								
		H2 (+45)	Unused at this time	_							
a		H1 (-45) H2 (+45)	Unused at this time	_							
퓿		L1 (-45)	Unused at this time Unused at this time								
ш		L2 (+45)	Unused at this time								
		H1 (-45)	Unused at this time								
	As	H2 (+45)	Unused at this time								
		H1 (-45)	Unused at this time								
		H2 (+45)	Unused at this time								
		L1 (-45) L2 (+45)	LTE C - RX4	_					4		
		H1 (-45)	AWS - RxTx0								
	A4	H2 (+45)	AWS - RxTx1	AMPHENOL	CWX063X25G00		140	120	2	0	Add-Install
		H1 (-45)	PCS - RxT2						2		
		H2 (+45)	PCS - RxT3						-		
		L1 (-45)	LTE C - RxTx0								
		L2 (+45)	LTE C - RxTx1						4		
	A1 A2 A4 A1 A2	H1 (-45)	AWS - Rx3	AMPHENOL	CWX063X25G00		140	240	2	0	Add-Install
		H2 (+45)	AWS - Rx4	_							
		H3 (-45) H4 (+45)	PCS - RxTx0 PCS - RxTx1	-					2		
		L1 (-45)	Unused at this time								
		L2 (+45)	Unused at this time	7							
	Δ2	H1 (-45)	Unused at this time								
		H2 (+45)	Unused at this time	_							
ū		H1 (-45)	Unused at this time	⊣							
Beta		H2 (+45) L1 (-45)	Unused at this time Unused at this time								
ш		L2 (+45)	Unused at this time	-							
	A3	H1 (-45)	Unused at this time								
	A3	H2 (+45)	Unused at this time								
		H1 (-45)	Unused at this time	_							
	-	H2 (+45)	Unused at this time								
		L1 (-45) L2 (+45)	LTE C - RX3	_					4		
		H1 (-45)	AWS - RxTx0	-							
	A4	H2 (+45)	AWS - RxTx1	AMPHENOL	CWX063X25G00		140	240	2	0	Add-Install
		H1 (-45)	PCS - RxT2						2		
	i .	H2 (+45)	PCS - RxT3					1	l -		

PPC CONNECTORS ONLY

PROPOSED ANTENNA SCHEDULE N.T.S.


Comments

Combiner - Cable Data

		Existin	g		
ē	Location	Diplexer Manufacturer	Dip	iexer Model	Count
Diplexer	Top (Platform)				
ൎ	Bottom (Shelter)				
	Sector	Coax Manufacturer	Туре	Size	Count
ă	Alpha				
Coax	Beta				
U	Gamma				

	1		Propo			
	Location Top (Platform)	Manufacturer	Component Model		Count	Action
	Top (Platform)	Westell		700 TMA	6	Install
S	Top (Platform)	Ericsson		JS 12 - AWS	3	Install
	Top (Platform)	Ericsson	KKC	A2	3	Install
Š	Top (Platform)	Ericsson	DDI	JS 12 - PCS	3	Install
Ē	Top (Platform)	Ericsson	IXIX	A2	3	Install
į	F	Liicaaoii		A2		install
é	Top (Platform) Top (Platform)					
Passive Components	Top (Platform)					
as	Top (Platform)	Raycap	RC3DC-3315-PF-48		2	Install
_	Bottom (Shelter)	rayoup	110000 001011 40		-	IIIStali
	Bottom (Shelter)					
	Bottom (Shelter)	Raycap	RC3E	C-3315-PF-48	2	Install
	,	,			_	
	Sector	Coax Manufacturer	Туре	Size	Count	Action
	Sector Alpha	Coax Manufacturer ANDREW	Type LDF7-50A	Size 15/8	Count 4	Action Install
×	Alpha	ANDREW	LDF7-50A	15/8	4	Install
Coax	Alpha Beta	ANDREW ANDREW	LDF7-50A LDF7-50A	15/8 15/8	4 4	Install Install

2 COMBINER CABLE DATA INFORMATION N.T.S.

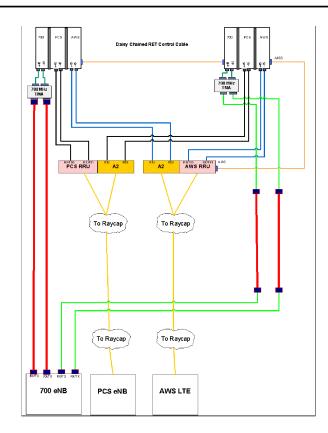

CABLE DIAGRAM
N.T.S.





REVISIONS DESCRIPTION DATE SUED FOR REVIEW 07/17/15 ER POWER COORDINATION 10/23/15 OR FIBER COORDINATION 12/28/15 ED TO CABINET LAYOUT 01/18/16 PER CLIENT COMMENTS 02/08/16 SSUED FOR FINAL 03/22/16 ED PLATFORM CANOPY 04/04/16		BY	윤	Ε	Ψ	SEA	MTC	MTC	BTE	
REVISIONS DESCRIPTION ERPOWER COORDINATION OR FIBER COORDINATION ED TO CABINET LAYOUT PER CLIENT COMMENTS SSUED FOR FINAL ED PLATFORM CANOPY		DATE	07/17/15	10/23/15	12/28/15	01/18/16	02/08/16	03/22/16	04/04/16	
	REVISIONS		ISSUED FOR REVIEW	REVISED PER POWER COORDINATION	ISSUED FOR FIBER COORDINATION	UPDATED TO CABINET LAYOUT	UPDATE PER CLIENT COMMENTS	ISSUED FOR FINAL	REMOVED PLATFORM CANOPY	
N . + S & 4 . 0 .0		8		- :	2	e,	4.	2.	9	

IL-00-5999 SHOPPES OF GRAND PRAIRIE


W AMERICAN PRAIRIE DR PEORIA, IL 61615


DRAWN BY:	PP
CHECKED BY:	TAZ
DATE:	07/17/15
PROJECT #:	50-168

SHEET TITLE
ANTENNA INFORMATION

SHEET NUMBER

ANT-2

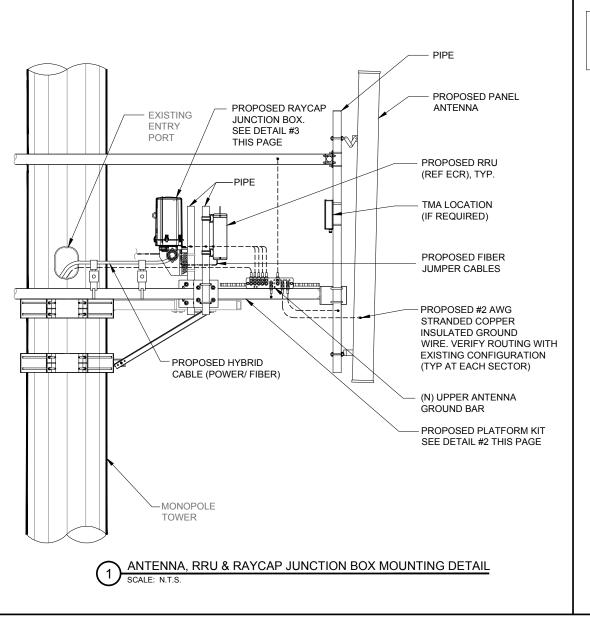


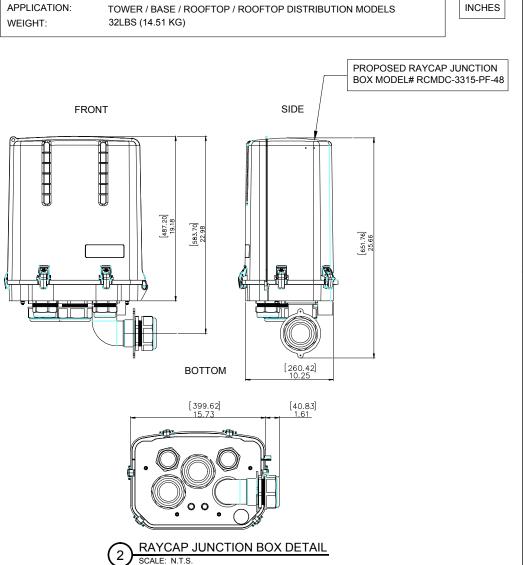



DC SURGE PROTECTION FOR RRU/INTEGRATED ANTENNA RADIO HEAD


[mm]

SPECIFICATIONS

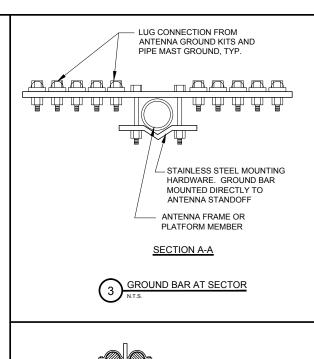

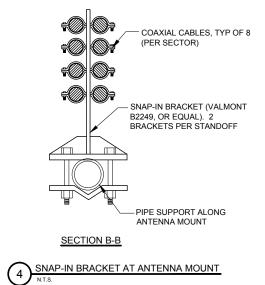

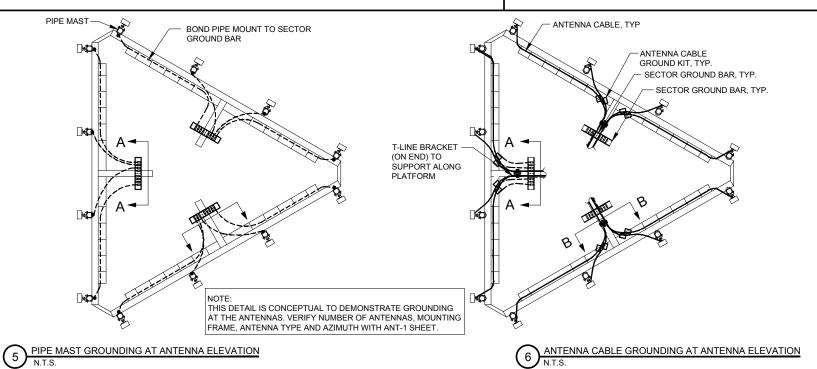

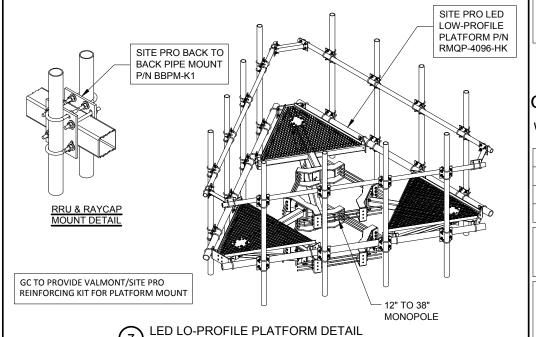





	ВУ	ద	MTC	MT	SEA	JTM	MTC	BTE	
	DATE	07/17/15	10/23/15	12/28/15	01/18/16	02/08/16	03/22/16	04/04/16	
REVISIONS	DESCRIPTION	ISSUED FOR REVIEW	REVISED PER POWER COORDINATION	ISSUED FOR FIBER COORDINATION	UPDATED TO CABINET LAYOUT	UPDATE PER CLIENT COMMENTS	ISSUED FOR FINAL	REMOVED PLATFORM CANOPY	
	Ŏ.		-	2.	က်	4.	2.	9	ı
	ш	-0	n N-	.5	gc	99			

IL-00-5999 SHOPPES OF GRAND PRAIRIE

W AMERICAN PRAIRIE DR PEORIA, IL 61615


ı	DRAWN BY:	PP
l	CHECKED BY:	TAZ
l	DATE:	07/17/15
l	PROJECT #:	50-168


ANTENNA


MOUNTING DETAILS


SHEET NUMBER


ANT-3

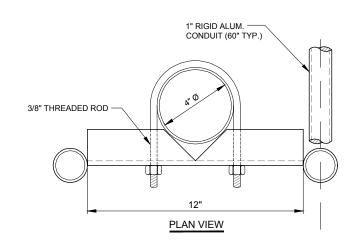


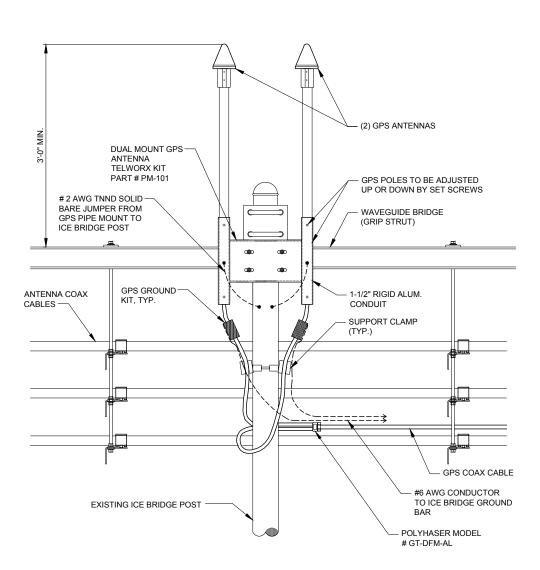

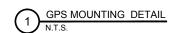

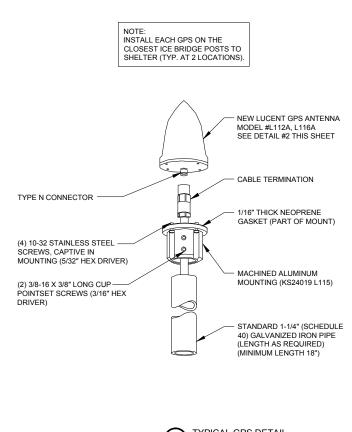

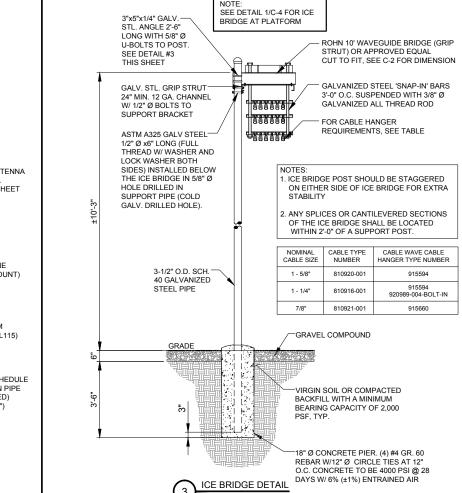

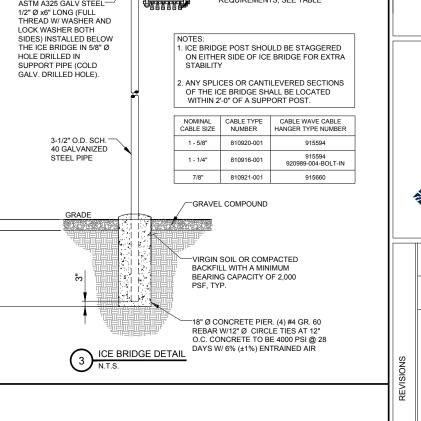



CENTRAL STATES TOWER III, LLC


W AMERICAN PRAIRIE DR PEORIA, IL 61615

GRAND PRAIRIE

DRAWN BY:	PP
CHECKED BY:	TAZ
DATE:	07/17/15
PROJECT #:	50-168

MOUNTING **DETAILS**

SHEET NUMBER

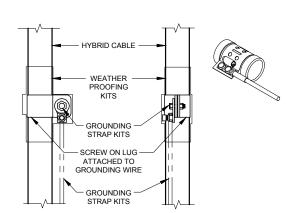

NOTES:
1. DO NOT INSTALL CABLE GROUND KIT AT A BEND

OUT OF THE STATE AND ALWAYS DIRECT GROUND WIRE DOWN TO

THIS DETAIL IS TYPICAL FOR EACH COAX CABLE

CABLE ALSO TO BE GROUNDED TO GROUND BAR


WHERE IT IS SPECIFIED TO BE GROUNDED


AT TOWER BASE IF APPLICABLE.


USE ONLY TIN PLATED GROUNDING KITS.

CABLE TO BE GROUNDED AT ANTENNA LEVEL AND PRIOR TO ENTERING SHELTER ENTRY PANEL

COAX/ HYBRID GROUND KIT DETAIL

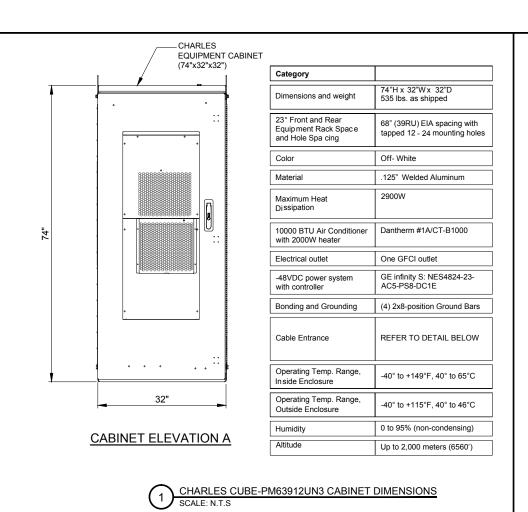

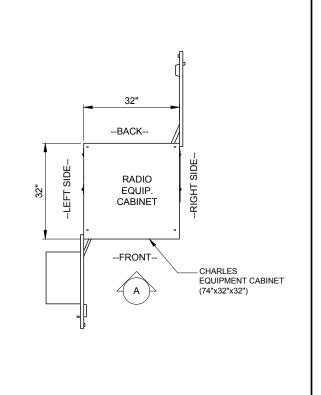

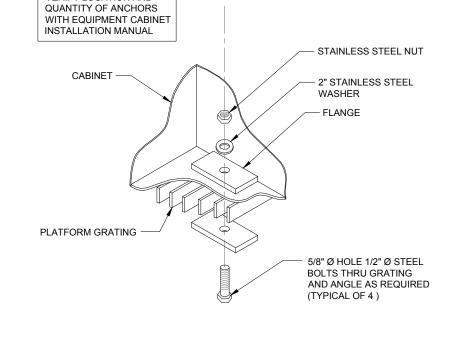

TYPICAL CABINET ANCHORING DETAIL SCALE: N.T.S

VERIFY LOCATION AND

2 CHARLES CUBE-PM63912UN3 CABINET DIMENSION PLAN SCALE: N.T.S





	ВУ	ద	MTC	MT	SEA	MTC	JTM	BTE	
	DATE	07/17/15	10/23/15	12/28/15	01/18/16	02/08/16	03/22/16	04/04/16	
REVISIONS	DESCRIPTION	ISSUED FOR REVIEW	REVISED PER POWER COORDINATION	ISSUED FOR FIBER COORDINATION	UPDATED TO CABINET LAYOUT	UPDATE PER CLIENT COMMENTS	ISSUED FOR FINAL	REMOVED PLATFORM CANOPY	
	NO.		-	2.	3.	4	5.	6.	۱
									1

IL-00-5999 SHOPPES OF GRAND PRAIRIE


W AMERICAN PRAIRIE DR PEORIA, IL 61615


ı	DRAWN DT.	PP
	CHECKED BY:	TAZ
	DATE:	07/17/15
	PROJECT #:	50-168

EQUIPMENT DETAILS


SHEET NUMBER


EQ-1

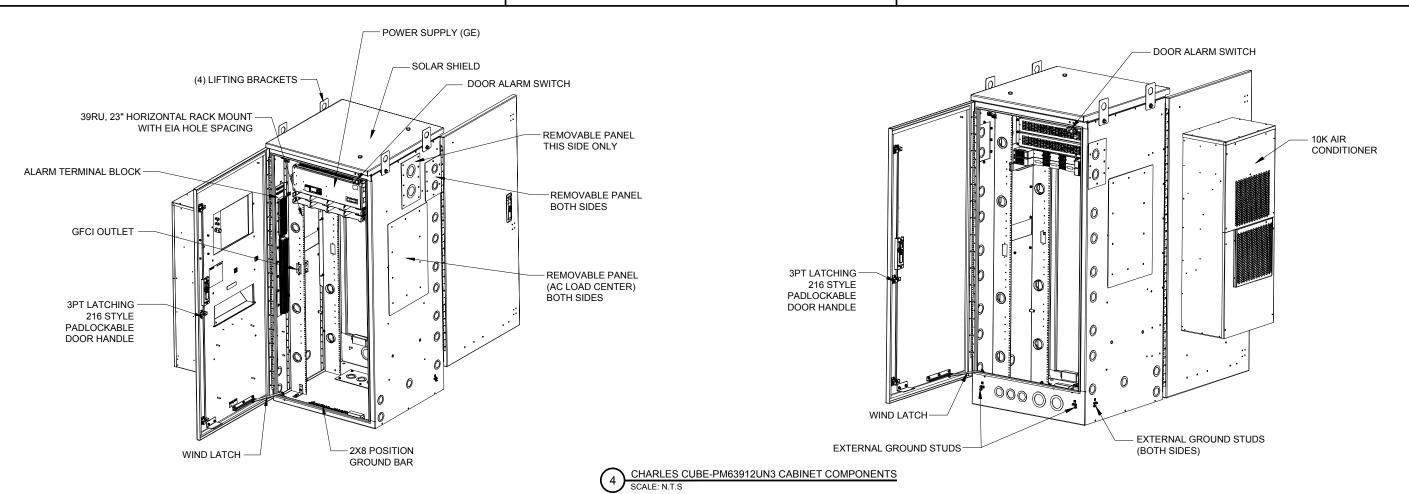


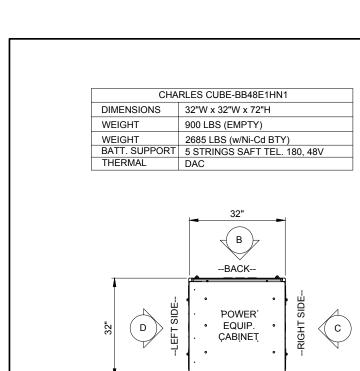

--FRONT--

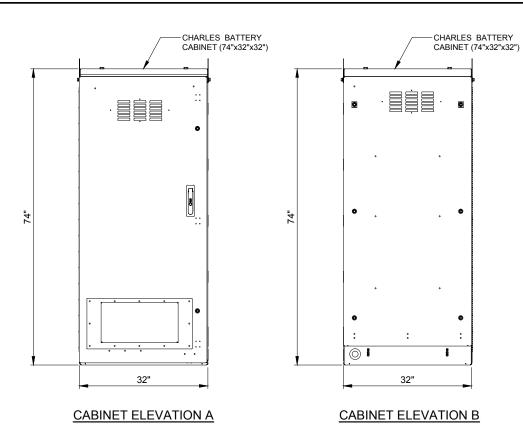

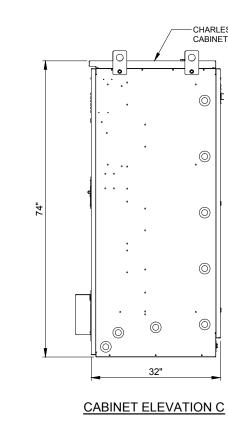

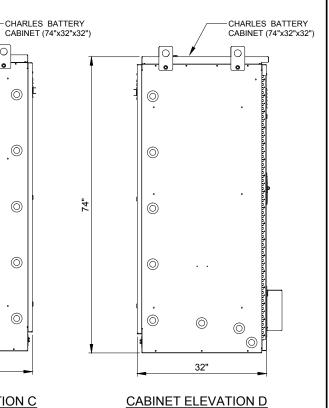





	ВУ	a	MTC	MT	SEA	MTC	MTC	ВТЕ
	DATE	07/17/15	10/23/15	12/28/15	01/18/16	02/08/16	03/22/16	04/04/16
REVISIONS	DESCRIPTION	ISSUED FOR REVIEW	REVISED PER POWER COORDINATION	ISSUED FOR FIBER COORDINATION	UPDATED TO CABINET LAYOUT	UPDATE PER CLIENT COMMENTS	ISSUED FOR FINAL	REMOVED PLATFORM CANOPY

IL-00-5999 SHOPPES OF GRAND PRAIRIE

(lbs.)

Depth


W AMERICAN PRAIRIE DR PEORIA, IL 61615


DRAWN BY:	PP
CHECKED BY:	TAZ
DATE:	07/17/15
PROJECT #:	50-168

EQUIPMENT DETAILS

SHEET NUMBER **EQ-2**

CHARLES CUBE-BB48E1HN1 CABINET DIMENSIONS

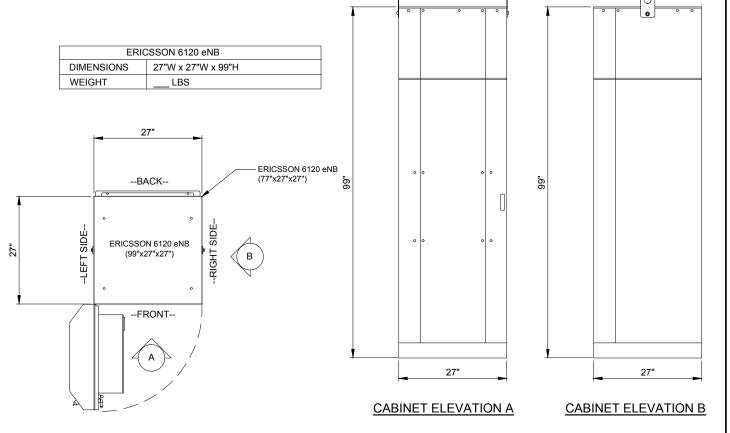


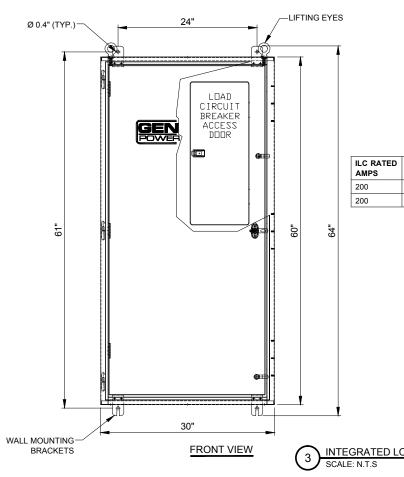


			ricigiit	wiatii	Dopu.	(155.)
	120/240	1	60"	30"	10"	350
	120/208	3	60"	30"	10"	350
1.0	DAD CEN	BC	HAIN ONDUIT CCESS 2'-6"	++ <u></u>	13"	
	0					

Width

ERICSSON 6120 eNB CABINET DIMENSIONS

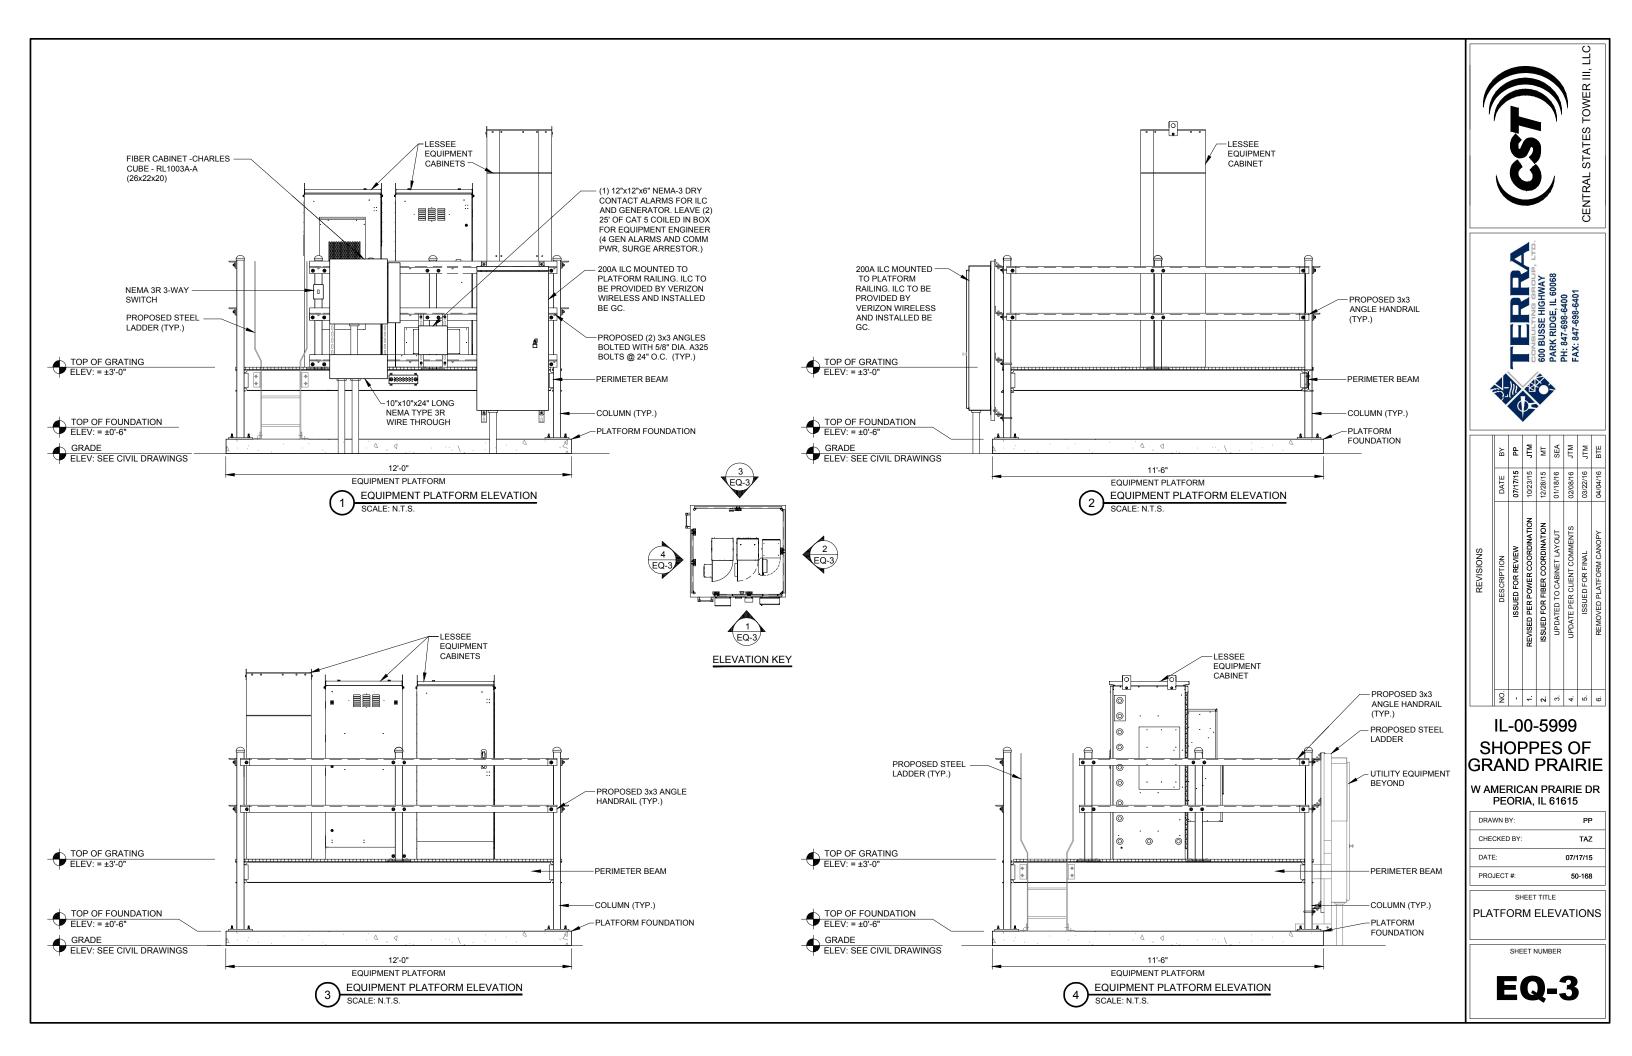

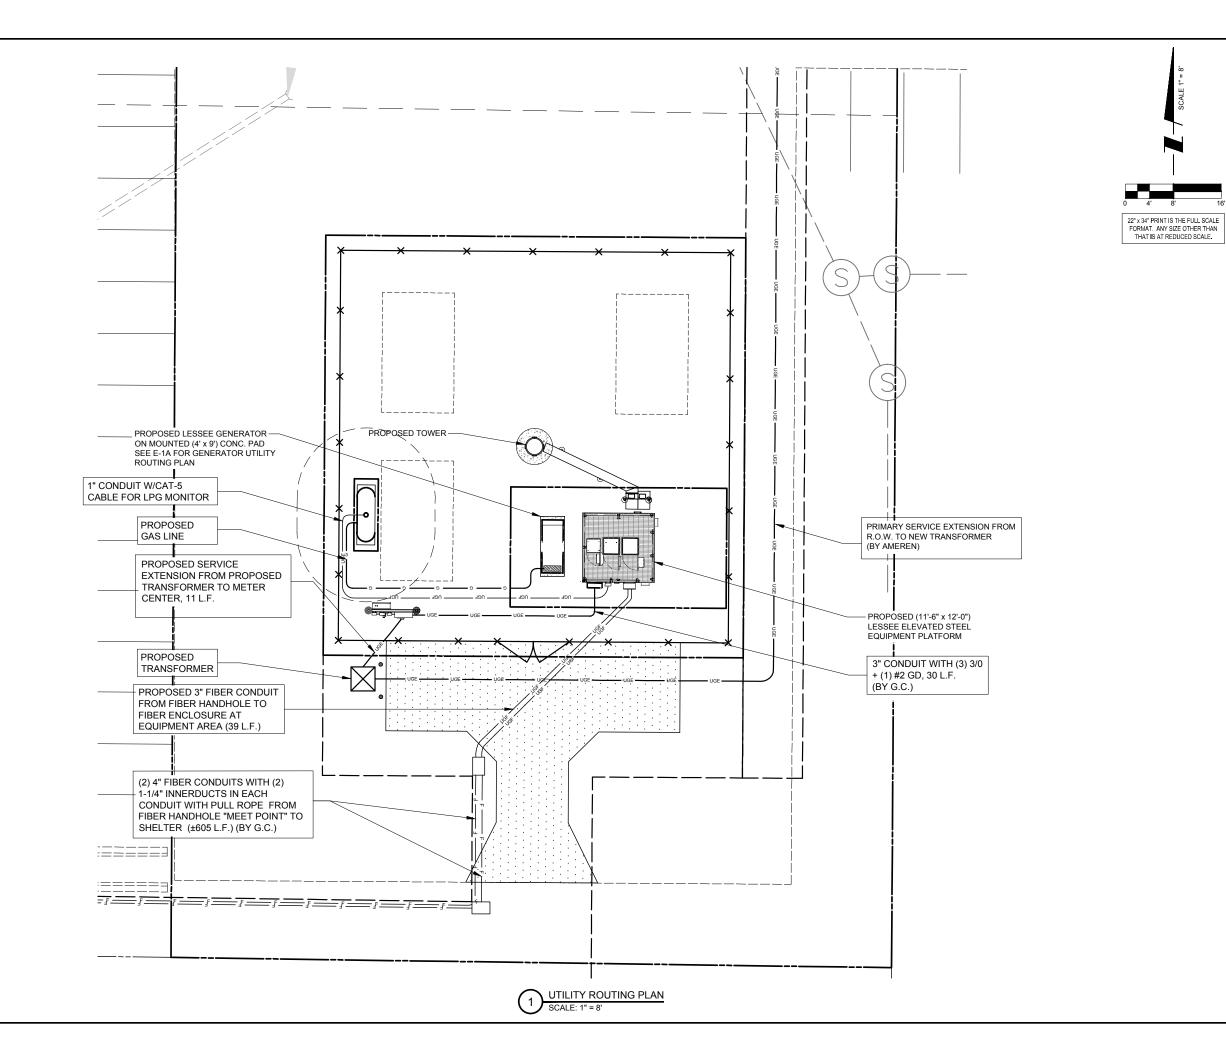

OPERATES 24 HOURS A DAY 365 DAYS A YEAR

CALL JULIE TOLL FREE 1(800) 892-0123 48 HOURS BEFORE YOU DIG





Ŏ.	DESCRIPTION	DATE	В
	ISSUED FOR REVIEW	07/17/15	윱
-	REVISED PER POWER COORDINATION	10/23/15	MTC
2	ISSUED FOR FIBER COORDINATION	12/28/15	MT
w.	UPDATED TO CABINET LAYOUT	01/18/16	SEA
4.	UPDATE PER CLIENT COMMENTS	02/08/16	JTM
5.	ISSUED FOR FINAL	03/22/16	JTM
9	REMOVED PLATFORM CANOPY	04/04/16	BTE
I			

IL-00-5999 SHOPPES OF GRAND PRAIRIE

W AMERICAN PRAIRIE DR PEORIA, IL 61615

ı	DRAWN BY:	PP
l	CHECKED BY:	TAZ
l	DATE:	07/17/15
l	PROJECT #:	50-168

SHEET TITLE UTILITY ROUTING PLAN

SHEET NUMBER

E-1

NOTES:

1) EXISTING MANUAL TRANSFER SWITCH TO BE REMOVED BY THE ELECTRICAL CONTRACTOR (E.C) AND TURNED OVER TO LESSEE. REMOVED EXTERNAL GROUND TERMINATION AND RECONNECT TO NEW TRANSFER SWITCH USING EXISTING GROUND LUG.

2) ALL UNDERGROUND GROUND TERMINATIONS AND TERMINATIONS TO EXISTING BUILDING GROUND GRID TO BE HEAVY DUTY EXOTHERMIC (CAD WELD).

3) NEW AUTOMATIC TRANSFER SWITCH, INSTALLED AND WIRED BY E.C. CONNECT EXTERNAL GROUND LUG AND GROUNDING CONDUCTOR THAT WAS REMOVED FROM MANUAL TRANSFER SWITCH.

4) EXISTING BUILDING GROUND GRID IS INDICATED ON THE NEW PLAN.
HOWEVER, EXACT LOCATION IS NOT KNOWN. E.C. MUST LOCATE THIS GROUND
GRID TO PROVIDE THE ATTACHMENT OF THE GENERATOR GROUND GRID.
ALSO THE UNDERGROUND CONDUITS FROM THE GENERATOR TO THE BUILDING
WILL CROSS OVER THIS GROUND GRID. CARE MUST BE TAKEN NOT TO DAMAGE
THE GROUND GRID. IF ANY DAMAGE OCCURS IT MUST BE REPAIRED SO THAT
THE COMPLETE GRID SYSTEM REMAINS INTACT.

5) E.C. TO EXTEND #2 TINNED SOLID COPPER GROUND CONDUCTORS FROM (2) LOCATIONS ON GENERATOR FRAME (SEE MANUFACTURERS RECOMMENDATIONS) PROVIDE GROUND LUGS ON GENERATOR AS REQUIRED. EXTEND #1/0 STRANDED GROUND CONDUCTOR AND CONNECT TO COPPER CLAD GROUND RODS VIA HEAVY DUTY EXOTHERMIC TERMINATIONS AND THEN EXTENDED AND ATTACH TO BUILDING GROUND GRID VIA EXOTHERMIC TERMINATIONS

6) NEW GENERATOR FURNISHED BY LESSEE. INSTALLED AND WIRED BY E.C. DELIVERED AND SET BY CONTRACTOR.

7) EXISTING PANEL BOARD - E.C. TO PROVIDE (2) IP20A BREAKERS AND EXTEND CIRCUITS OUT TO GENERATOR LOCATIONS FOR WIRING OF 1800 WATT WATER JACKET HEATER, AND BATTERY CHARGER. PROVIDE RECEPTACLES OR TERMINATIONS AS REQUIRED. VERIFY EXACT LOCATIONS WITH GENERAC.

8) E.C. MUST MONITOR DC POWER WHEN ON BATTERY BACK-UP DURING PORTIONS OF CONSTRUCTION. IF LEVEL FALLS BELOW RECOMMENDED LEVEL 2256 DC, E.C. MUST TURN ON THE MAIN POWER. THE CELL SITE CANNOT GO OFF LINE AT ANYTIME.



NOTE:


CONTRACTOR TO VERIFY ROUTES WITH LOCAL UTILITY COMPANY PRIOR TO INSTALLATION.

NOTES:

1) SEE DETAILS ON EXISTING GROUND GRID AND GENERATOR GROUND GRID FOR REQUIRED GROUNDING SYSTEM.

2) PROVIDE NEW FEEDER CONDUCTORS FROM MAIN SERVICE SWITCH TO TRANSFER SWITCH FROM TRANSFER SWITCH TO EXISTING TAP BOX AND FROM TAP BOX TO EXISTING PANELBOARD.

3) CARE MUST BE TAKEN INTHE PLACEMENT OF NEW AUTOMATIC TRANSFER SWITCH SO THAT ENTRANCE OF THE FEEDER THRU THE BACK OF THE TRANSFER SWITCH DOES NOT INTERFERE WITH EQUIPMENT INSIDE TRANSFER SWITCH OR WITH TRANSFER SWITCH OPERATION.

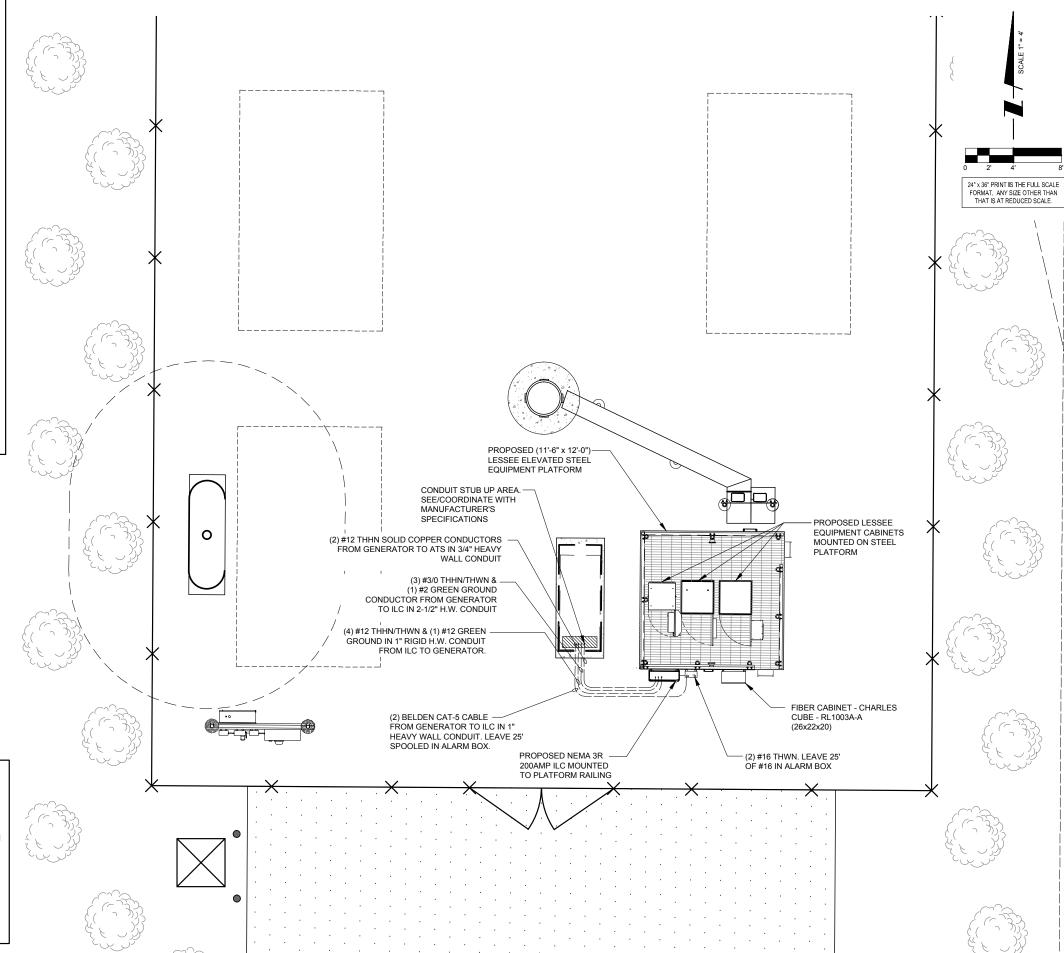





	ВУ	MTC	MT	SEA	MTC	MTC	BTE	BTE	
	DATE	12/28/15	01/18/16	10/23/15	02/08/16	03/22/16	04/04/16	04/14/16	
REVISIONS	DESCRIPTION	REVISED PER POWER COORDINATION	ISSUED FOR FIBER COORDINATION	UPDATED TO CABINET LAYOUT	UPDATE PER CLIENT COMMENTS	ISSUED FOR FINAL	REMOVED PLATFORM CANOPY	UPDATE PER LL COMMENTS	
	N O	-	2.	ю.	4.	5.	9	7.	

IL-00-5999 SHOPPES OF GRAND PRAIRIE


W AMERICAN PRAIRIE DR PEORIA, IL 61615


DRAWN BY:	PP
CHECKED BY:	TAZ
DATE:	07/17/15
PROJECT #:	50-168

GENERATOR
UTILITY ROUTING PLAN

SHEET NUMI


E-1A

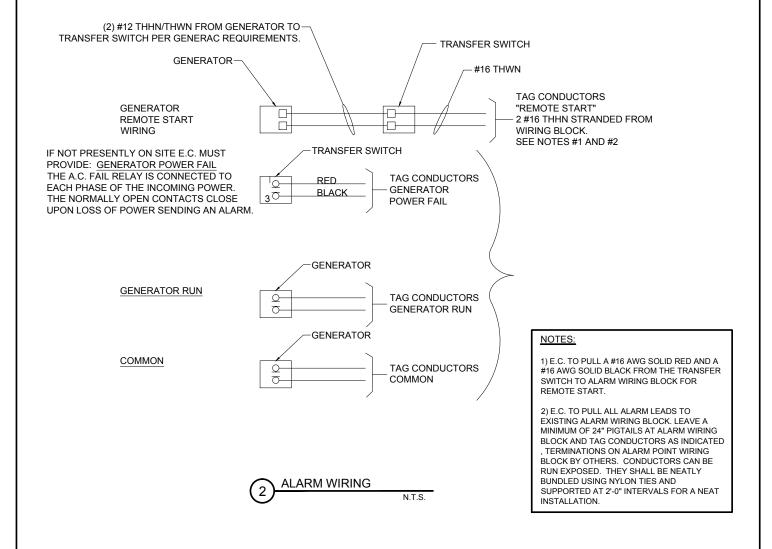

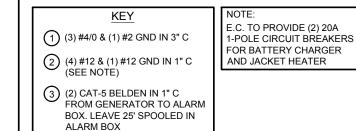

(2) #12 THWN IN 3/4" C

(2) #16 THWN. LEAVE 25' OF #16 IN ALARM BOX

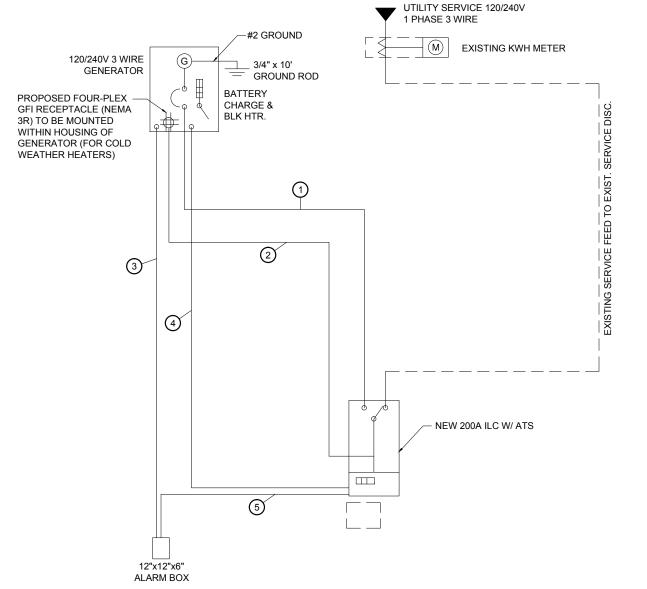

NEW SINGLE LINE DIAGRAM





S	NOITGISCISION	DATE	Ä
		1	i
1	ISSUED FOR REVIEW	07/17/15	ď
l	REVISED PER POWER COORDINATION	10/23/15	ΝĘ
l	ISSUED FOR FIBER COORDINATION	12/28/15	TM
Ι.	UPDATED TO CABINET LAYOUT	01/18/16	SEA
l	UPDATE PER CLIENT COMMENTS	02/08/16	MTC
5.	ISSUED FOR FINAL	03/22/16	MTC
69	REMOVED PLATFORM CANOPY	04/04/16	BTE

IL-00-5999 SHOPPES OF GRAND PRAIRIE


W AMERICAN PRAIRIE DR PEORIA, IL 61615

PP	DRAWN BY:	
TAZ	CHECKED BY:	
07/17/15	DATE:	
50-168	PROJECT #:	

GENERATOR SINGLE LINE DIAGRAM &


ALARM WIRING

E-1B

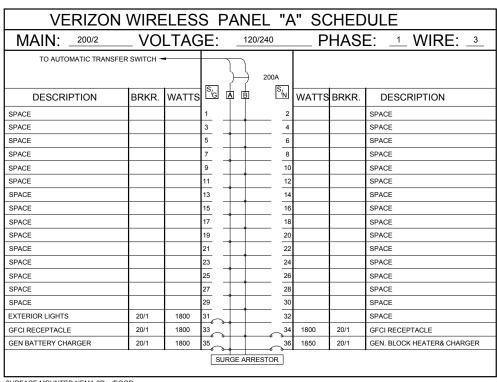


SURFACE MOUNTED NEMA 3R W/DOOR 22K AIC BREAKERS (CONTRACTOR SHALL VERIFY AIC RATINGS W/LOCAL POWER CO.)

> NOTE: VERIZON WIRELESS EQUIPMENT ENGINEERING TO SUPPLY BREAKER FOR RADIO AND POWER CABINETS

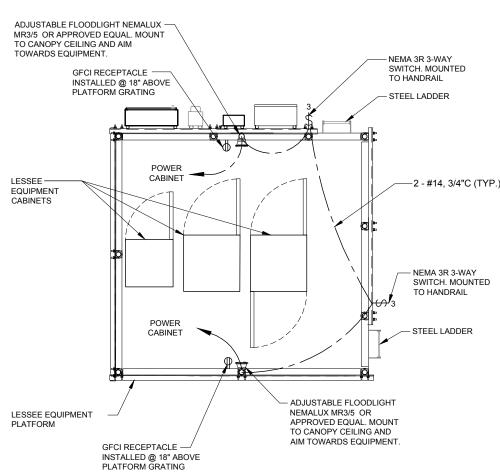

PLATFORM LIGHTING PLAN SCALE: N.T.S.

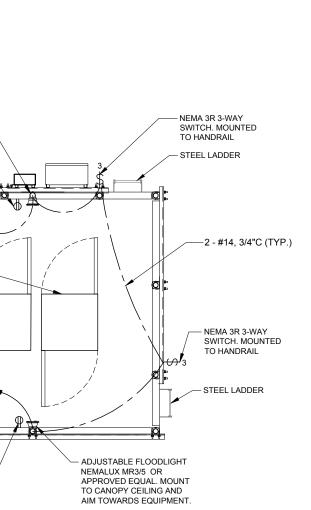



IL-00-5999 SHOPPES OF GRAND PRAIRIE


W AMERICAN PRAIRIE DR PEORIA, IL 61615

DRAWN BY:	PP
CHECKED BY:	TAZ
DATE:	07/17/15
PROJECT #:	50-168

PANEL SCHEDULE & LIGHTING PLAN

SHEET NUMBER

E-1C

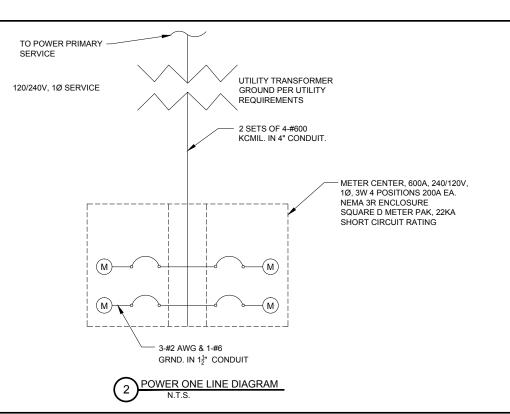

ELECTRICAL NOTES:

- 1. SUBCONTRACTOR SHALL PROVIDE 600AMP, SINGLE PHASE, 120/240 VAC, 60HZ SERVICE FOR SITE
- 2. SUBCONTRACTOR SHALL COORDINATE WITH UTILITY COMPANY BEFORE THE START OF CONSTRUCTION. POWER AND TELEPHONE CONDUIT SHALL BE PROVIDED AND INSTALLED PER UTILITY REQUIREMENTS.
- 3. FOR COMPLETE INTERNAL WIRING AND ARRANGEMENT REFER TO DRAWINGS PROVIDED BY PANEL MANUFACTURER.
- 4. SUBCONTRACTOR SHALL PROVIDE ELECTRICAL SERVICE EQUIPMENT WITH FAULT CURRENT RATINGS GREATER THAN THE AVAILABLE FAULT CURRENT FROM THE POWER UTILITY.
- 5. SUBCONTRACTOR SHALL VERIFY THAT MAIN BONDING JUMPER AND GROUNDING ELECTRODE CONDUCTOR IS INSTALLED PROPERLY WHEN PANEL IS SERVICE ENTRANCE **EQUIPMENT**


- 1. LEAN CONCRETE, RED-COLORED TOP, MAY BE USED IN PLACE OF COMPACTED SAND.
- 2. BURY CONDUITS 42" BELOW GRADE OR 6" BELOW FROST LINE, WHICHEVER IS


CONDUITS FOR

ELECTRICAL & ANTENNA SHARING

APPLICABLE

WHERE

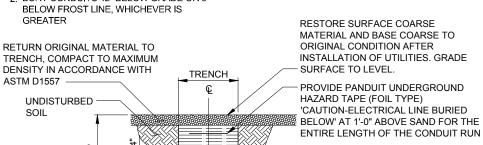

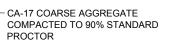

COMPACTED SAND (SEE NOTE 1) - COMPACTED SAND

BED (SEE NOTE 1)

3. CONDUIT SIZE, TYPE, QUANTITY AND

WITH LOCAL UTILITY COMPANY


REQUIREMENTS


SEPARATION DIMENSION TO BE VERIFIED

12" (MIN) SEPARATION

UTILITY TRENCH DETAIL




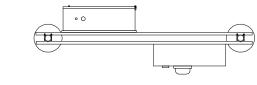

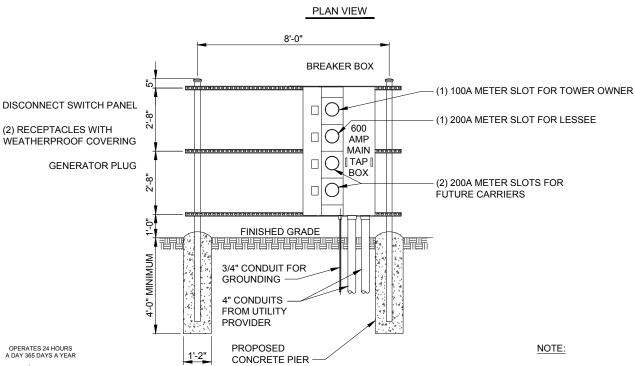


FRONT

- 1. ALL ELECTRICAL PLUMBING MUST BE VERIFIED PRIOR TO INSTALLATION BY CONTRACTOR AND MUST MEET GOVERNING CODES, NO EXCEPTIONS.
- 2. 1 36" x 36" x 12" NEMA 3R ENCLOSURE (HOFFMAN A-20R20BHCR OR SIMILAR)

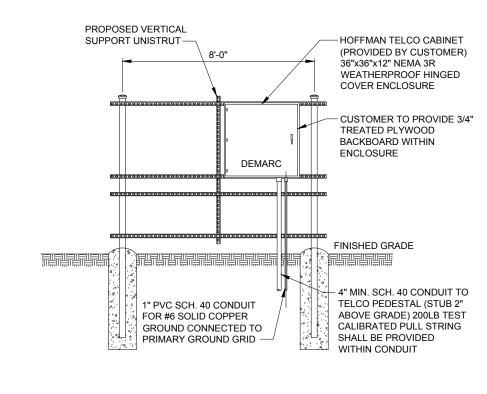

REAR

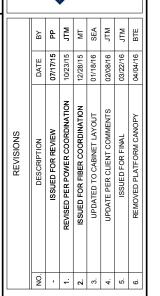

IL-00-5999 SHOPPES OF **GRAND PRAIRIE**


W AMERICAN PRAIRIE DR **PEORIA, IL 61615**

ı	DRAWN BY:	PP
ı	CHECKED BY:	TAZ
ı	DATE:	07/17/15
ı	PROJECT #:	50-168

SHEET TITLE

SINGLE LINE DIAGRAM AND DETAILS

SHEET NUMBER

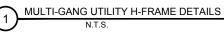

ELECTRICAL INSTALLATION NOTES

- 1. ALL ELECTRICAL WORK SHALL BE PERFORMED IN ACCORDANCE WITH THE PROJECT SPECIFICATIONS THE NATIONAL ELECTRICAL CODE (N.E.C.), AND ALL APPLICABLE LOCAL CODES.
- 2. WIRING RACEWAY AND SUPPORT METHODS AND MATERIALS SHALL COMPLY WITH THE REQUIREMENTS OF THE N.F.C.
- 3. ALL CIRCUITS SHALL BE SEGREGATED AND MAINTAIN MINIMUM CABLE SEPARATION AS REQUIRED BY THE
- 4. CABLES SHALL NOT BE ROUTED THROUGH LADDER CABLE TRAY RUNGS.
- EACH END OF EVERY POWER PHASE CONDUCTOR (I.E., HOTS), GROUNDING, AND T1 CONDUCTOR AND CABLE SHALL BE LABELED WITH COLOR-CODED INSULATION OR ELECTRICAL TAPE (3M BRAND, 1/2 INCH PLASTIC ELECTRICAL TAPE WITH UV PROTECTION, OR EQUAL). THE IDENTIFICATION METHOD SHALL CONFORM WITH N.E.C. & OSHA
- ALL ELECTRICAL COMPONENTS SHALL BE CLEARLY LABELED WITH PLASTIC TAPE PER COLOR SCHEDULE, ALL EQUIPMENT SHALL BE LABELED WITH THEIR VOLTAGE RATING, PHASE CONFIGURATION, WIRE CONFIGURATION, POWER OR AMPACITY RATING, AND BRANCH CIRCUIT ID NUMBERS (I.E. PANEL BOARD AND CIRCUIT ID'S).
- PANEL BOARDS (ID NUMBERS) AND INTERNAL CIRCUIT BREAKERS (CIRCUIT ID NUMBERS) SHALL BE CLEARLY LABELED WITH PLASTIC LABELS.
- 8. ALL TIE WRAPS SHALL BE CUT FLUSH WITH APPROVED CUTTING TOOL TO REMOVE SHARP EDGES.
- POWER, CONTROL, AND EQUIPMENT GROUND WIRING IN TUBING OR CONDUIT SHALL BE SINGLE CONDUCTOR (#14 AWG OR LARGER), 600 V, OIL RESISTANT THHN OR THWN-2, CLASS B STRANDED COPPER CABLE RATED FOR 90° C (WET AND DRY) OPERATION; LISTED OR LABELED FOR THE LOCATION AND RACEWAY SYSTEM USED, UNLESS OTHERWISE SPECIFIED.
- 10. SUPPLEMENTAL EQUIPMENT GROUND WIRING LOCATED INDOORS SHALL BE SINGLE CONDUCTOR (#6 AWG OR LARGER), 600 V, OIL RESISTANT THHN OR THWN-2 GREEN INSULATION, CLASS B STRANDED COPPER CABLE RATED FOR 90° C (WET AND DRY) OPERATION; LISTED OR LABELED FOR THE LOCATION AND RACEWAY SYSTEM USED, UNLESS OTHERWISE NOTED.
- 11. POWER AND CONTROL WIRING, NOT IN TUBING OR CONDUIT, SHALL BE MULTI-CONDUCTOR, TYPE TC CABLE (#14 AWG OR LARGER) 600 V, OIL RESISTANT THHN OR THHN-2, CLASS B STRANDED COPPER CABLE RATED FOR 90° C (WET AND DRY) OPERATION; WITH OUTER JACKET; LISTED OR LABELED FOR LOCATION USED, UNLESS OTHERWISE SPECIFIED.
- 12. ALL POWER AND GROUNDING CONNECTIONS SHALL BE CRIMP-STYLE, COMPRESSION WIRE LUGS AND WIRENUTS BY THOMAS AND BETTS (OR EQUAL). LUGS AND WIRENUTS SHALL BE RATED FOR OPERATION AT NO LESS THAN 75°C (90°C IF AVAILABLE)
- 13. RACEWAY AND CABLE TRAY SHALL BE LISTED OR LABELED FOR ELECTRICAL USE IN ACCORDANCE WITH NEMA, UL, ANSI/IEEE, AND N.E.C.
- 14. ELECTRICAL METALLIC TUBING (EMT) OR RIGID NONMETALLIC CONDUIT (I.E., RIGID PVC SCHEDULE 40, OR RIGID PVC SCHEDULE 80 FOR LOCATIONS SUBJECT TO PHYSICAL DAMAGE) SHALL BE USED FOR EXPOSED INDOOR LOCATIONS.
- 15. ELECTRICAL METALLIC TUBING (EMT), ELECTRICAL NONMETALLIC TUBING (ENT), OR RIGID NONMETALLIC CONDUIT (RIGID PVC, SCHEDULE 40) SHALL BE USED FOR CONCEALED INDOOR LOCATIONS
- GALVANIZED STEEL INTERMEDIATE METALLIC CONDUIT (IMC) SHALL BE USED FOR OUTDOOR LOCATIONS ABOVE GRADE.
- 17. RIGID NONMETALLIC CONDUIT(I.E., RIGID PVC SCHEDULE 40 OR RIGID PVC SCHEDULE 80) SHALL BE USED UNDERGROUND; DIRECT BURIED; IN AREAS OF OCCASIONAL LIGHT VEHICLE TRAFFIC OR ENCASED IN REINFORCED CONCRETE IN AREAS OF HEAVY VEHICLE TRAFFIC.
- 18. LIQUID-TIGHT FLEXIBLE METALLIC CONDUIT (LIQUID-TITE FLEX) SHALL BE USED INDOORS AND OUTDOORS, WHERE VIBRATION OCCURS OR FLEXIBILITY IS NEEDED.
- 19. CONDUIT AND TUBING FITTINGS SHALL BE THREADED OR COMPRESSION-TYPE AND APPROVED FOR THE LOCATION USED. SETSCREWS FITTINGS ARE NOT ACCEPTABLE.
- 20. CABINETS, BOXES AND WIREWAYS SHALL BE LISTED OR LABELED FOR ELECTRICAL USE IN ACCORDANCE WITH NEMA, UL. ANSI/IEEE, AND N.E.C.
- 21. WIREWAYS SHALL BE EPOXY-COATED (GRAY) AND INCLUDE A HINGED COVER, DESIGNED TO SWING OPEN DOWNWARD; SHALL BE PANDUIT TYPE E (OR EQUAL) AND RATED NEMA 1 (OR BETTER).
- 22. EQUIPMENT CABINETS, TERMINAL BOXES, JUNCTION BOXES, AND PULL BOXES SHALL BE GALVANIZED OR EPOXY-COATED SHEET STEEL, SHALL MEET OR EXCEED UL 50, AND RATED NEMA 1(OR BETTER) INDOORS, OR NEMA 3R (OR BETTER) OUTDOORS

- 23. METAL RECEPTACLE, SWITCH, AND DEVICE BOXES SHALL BE GALVANIZED, EPOXY-COATED; OR NON-CORRODING; SHALL MEET OR EXCEED UL 514A AND NEMA OS 1; AND RATED NEMA 1 (OR BETTER) INDOORS, OR WEATHER PROTECTED (WP OR BETTER) OUTDOORS.
- 24. NONMETALLIC RECEPTACLE, SWITCH, AND DEVICE BOXES SHALL MEET OR EXCEED NEMA OS 2; AND RATED NEMA 1 (OR BETTER) INDOORS, OR WEATHER PROTECTED (WP OR BETTER) OUTDOORS.
- 25. THE SUBCONTRACTOR SHALL NOTIFY AND OBTAIN NECESSARY AUTHORIZATION FROM THE CONTRACTOR BEFORE COMMENCING WORK ON THE AC POWER DISTRIBUTION PANELS.
- 26. THE SUBCONTRACTOR SHALL PROVIDE NECESSARY TAGGING ON THE BREAKERS, CABLES AND DISTRIBUTION PANELS IN ACCORDANCE WITH THE APPLICABLE CODES AND STANDARDS TO SAFEGUARD AGAINST LIFE AND PROPERTY

GROUNDING NOTES

- ALL GROUND ELECTRODE SYSTEMS (INCLUDING TELECOMMUNICATION, RADIO, LIGHTNING PROTECTION, AND AC POWER GES'S) SHALL BE BONDED TOGETHER BELOW GRADE, BY TWO OR MORE COPPER BONDING CONDUCTORS IN ACCORDANCE WITH THE N.E.C.
- 2. THE SUBCONTRACTOR SHALL PERFORM IEEE FALL-OF-POTENTIAL RESISTANCE TO EARTH TESTING (PER IEEE 1100 AND 81) FOR GROUND ELECTRODE SYSTEMS. THE SUBCONTRACTOR SHALL FURNISH AND INSTALL SUPPLEMENTAL GROUND ELECTRODES AS NEEDED TO ACHIEVE A TEST RESULT OF 5 OHMS OR IESS.
- THE SUBCONTRACTOR IS RESPONSIBLE FOR PROPERLY SEQUENCING GROUNDING AND UNDERGROUND CONDUIT INSTALLATION AS TO PREVENT ANY LOSS OF CONTINUITY IN THE GROUNDING SYSTEM OR DAMAGE TO THE CONDUIT & PROVIDE TESTING RESULTS.
- METAL CONDUIT AND TRAY SHALL BE GROUNDED AND MADE ELECTRICALLY CONTINUOUS WITH LISTED BONDING FITTINGS OR BY BONDING ACROSS THE DISCONTINUITY WITH #6 AWG COPPER WIRE UL APPROVED GROUNDING TYPE CONDUIT CLAMPS.
- 5. METAL RACEWAY SHALL NOT BE USED AS THE N.E.C. REQUIRED EQUIPMENT GROUND CONDUCTOR. STRANDED COPPER CONDUCTORS WITH GREEN INSULATION, SIZED IN ACCORDANCE WITH THE N.E.C., SHALL BE FURNISHED AND INSTALLED WITH THE POWER CIRCUITS TO BTS EQUIPMENT.
- CONNECTIONS TO THE GROUND BUS SHALL NOT BE DOUBLED UP OR STACKED. BACK TO BACK CONNECTIONS ON OPPOSITE SIDES OF THE GROUND BUS ARE PERMITTED.
- 7. ALL EXTERIOR GROUND CONDUCTORS BETWEEN EQUIPMENT/GROUND BARS AND THE GROUND RING SHALL BE #2 AWG SOLID TINNED COPPER UNLESS OTHERWISE INDICATED.
- 8. ALUMINUM CONDUCTOR OR COPPER CLAD STEEL CONDUCTOR SHALL NOT BE USED FOR GROUNDING CONNECTIONS
- 9. USE OF 90° BENDS IN THE PROTECTION GROUNDING CONDUCTORS SHALL BE AVOIDED WHEN 45° BENDS CAN BE ADEQUATELY SUPPORTED.
- 10. EXOTHERMIC WELDS SHALL BE USED FOR ALL GROUNDING CONNECTIONS BELOW GRADE.
- 11. ALL GROUND CONNECTIONS ABOVE GRADE (INTERIOR & EXTERIOR) SHALL BE FORMED USING HIGH PRESS CRIMPS.
- 12. COMPRESSION GROUND CONNECTIONS MAY BE REPLACED BY EXOTHERMIC WELD CONNECTIONS.
- 13. ICE BRIDGE BONDING CONDUCTORS SHALL BE EXOTHERMICALLY BONDED OR BOLTED TO THE BRIDGE AND THE TOWER GROUND BAR.
- 14. APPROVED ANTIOXIDANT COATINGS (I.E., CONDUCTIVE GEL OR PASTE) SHALL BE USED ON ALL COMPRESSION AND BOLTED GROUND CONNECTIONS.
- 15. ALL EXTERIOR GROUND CONNECTIONS SHALL BE COATED WITH A CORROSION RESISTANT MATERIAL.
- 16. MISCELLANEOUS ELECTRICAL AND NON-ELECTRICAL METAL BOXES, FRAMES AND SUPPORTS SHALL BE BONDED TOT HE GROUND RING, IN ACCORDANCE WITH THE N.E.C.
- 17. BOND ALL METALLIC OBJECTS WITHIN 6 FT. OF MAIN GROUND WIRES WITH (1) #2 AWG TIN-PLATED COPPER GROUND CONDUCTOR.
- 18. GROUND CONDUCTORS USED IN THE FACILITY GROUND AND LIGHTNING PROTECTION SYSTEMS SHALL NOT BE ROUTED THROUGH METALLIC OBJECTS THAT FORM A RING AROUND THE CONDUCTOR, SUCH AS METALLIC CONDUITS, METAL SUPPORT CLIPS OR SLEEVES THROUGH WALLS OR FLOORS. WHEN IT IS REQUIRED TO BE HOUSED IN CONDUIT TO MEET CODE REQUIREMENTS OR LOCAL CONDITIONS, NON-METALLIC MATERIAL SUCH AS PVC PLASTIC CONDUIT SHALL BE SUED. WHERE USE OF METAL CONDUIT IS UNAVOIDABLE (E.G., NON-METALLIC CONDUIT PROHIBITED BY LOCAL CODE) THE GROUND CONDUCTOR SHALL BE BONDED TO EACH END OF THE METAL CONDUIT.





	REVISIONS		
Ŏ.	DESCRIPTION	DATE	ВУ
	ISSUED FOR REVIEW	07/17/15	윤
+	REVISED PER POWER COORDINATION	10/23/15	MTC
2	ISSUED FOR FIBER COORDINATION	12/28/15	MT
εć	UPDATED TO CABINET LAYOUT	01/18/16	SEA
4.	UPDATE PER CLIENT COMMENTS	02/08/16	MTC
5.	ISSUED FOR FINAL	03/22/16	JTM
9	REMOVED PLATFORM CANOPY	04/04/16	BTE

IL-00-5999 SHOPPES OF GRAND PRAIRIE

W AMERICAN PRAIRIE DR PEORIA, IL 61615


DRAWN BY:	PP
CHECKED BY:	TAZ
DATE:	07/17/15
PROJECT #:	50-168
	CHECKED BY: DATE:

SHEET TITLE

ELECTRICAL AND GROUNDING NOTES

SHEET NUMBER

E-3

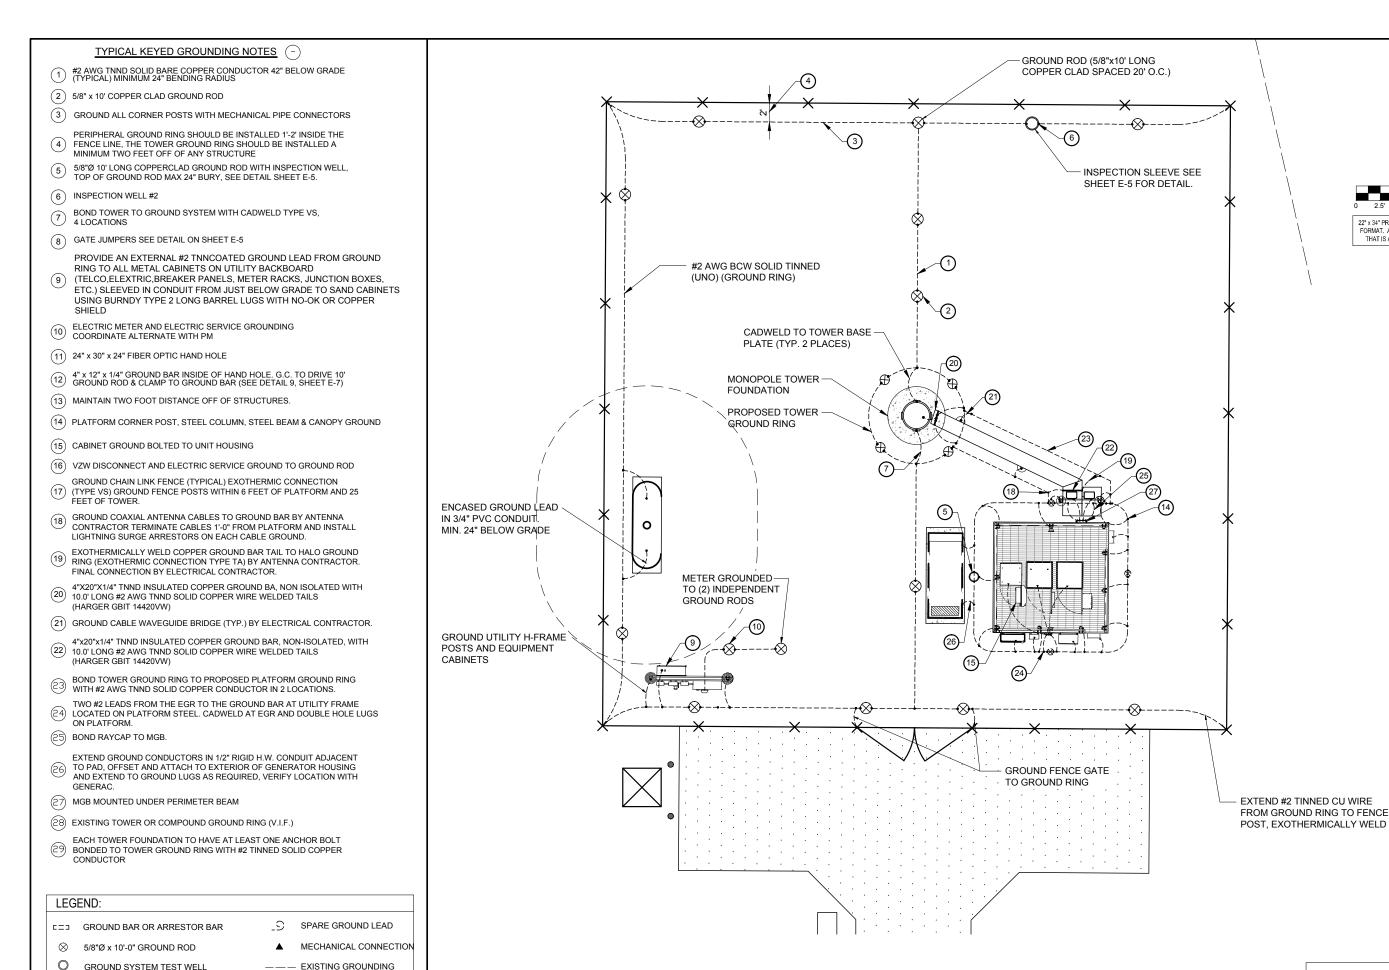


CADWELD OR APPROVED CONNECTION ——— NEW GROUNDING

SITE GROUNDING PLAN









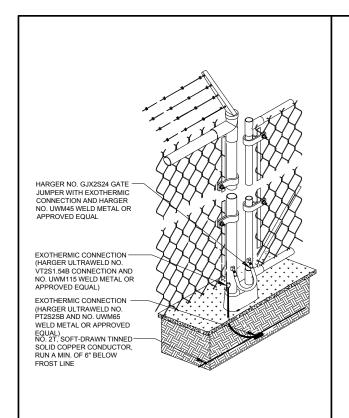

FENCE GROUNDING DETAIL

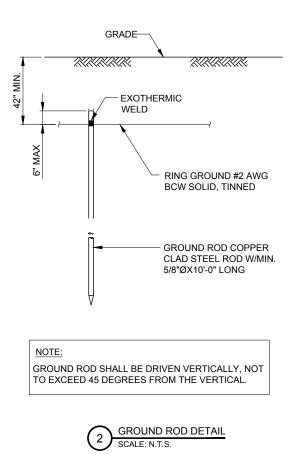

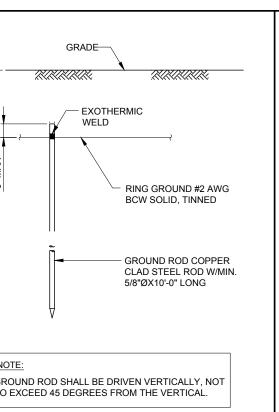





TEE OF HORIZONTAL RUN AND TAP CABLES.



HORIZONTAL CABLE TAP TO OR PIPE, CABLE OFF SURFACE



THROUGH VERTICAL CABLE TO VERTICAL STEEL SURFACE OR TO THE SIDE OF EITHER HORIZONTAL OR VERTICAL



CROSS OF HORIZONTAL CABLES. LAPPED AND NOT

EXOTHERMIC WELD DETAILS

EXOTHERMIC AND HARGER ULTRAWELD OR APPROVED EQUAL



HORIZONTAL CABLE TAP TO VERTICAL STEEL SURFACE OR THE SIDE OF HORIZONTAL PIPE



CABLE TAP DOWN AT 45° TO VERTICAL STEEL SURFACE OR SIDE OF HORIZONTAL OR VERTICAL PIPE.



THROUGH CABLE TO SIDE OF GROUND ROD



CABLE TAP TO TOP OF GROUND



THROUGH AND TAP CABLES







NOTES:

OR APPROVED EQUAL

1. PROPOSED HARGER 2x14.5" GROUND BAR

(PN/ TGBR14214.5VER) MOUNT DIRECTLY TO

2. INSULATORS TO BE NEWTON CAT. NO. 3015-8

3. 5/8" LOCK WASHERS; NEWTON CAT. NO. A-6056 OR APPROVED EQUAL

#2 AWG INSULATED STRANDED

GROUND WIRE TO BOTTOM

GROUND BAR

4. 5/8" - 11 X 1" M.M.C.S. BOLTS; NEWTON CAT.

NO. 3012-1 OR APPROVED EQUAL

5. COAT ALL SURFACES WITH 'KOPER SHIELD' BEFORE MATING

TWO HOLE LUG W/ 4/0 AWG GREEN STRANDED GROUND WIRE GROUND TO

TOWER STEEL

GROUND COLLECTOR BAR

6. ALL HARDWARE TO BE STAINLESS STEEL UNLESS OTHERWISE NOTED

7. NUTS TO FACE OUT





	В	8	MTC	MT	SEA	JTM	JTM	BTE	
	DATE	07/17/15	10/23/15	12/28/15	01/18/16	02/08/16	03/22/16	04/04/16	
REVISIONS	DESCRIPTION	ISSUED FOR REVIEW	REVISED PER POWER COORDINATION	ISSUED FOR FIBER COORDINATION	UPDATED TO CABINET LAYOUT	UPDATE PER CLIENT COMMENTS	ISSUED FOR FINAL	REMOVED PLATFORM CANOPY	
	NO.		1.	2.	ю.	4	5.	.9	
		_	_	_					١



W AMERICAN PRAIRIE DR PEORIA, IL 61615


DRAWN BY:	PP
CHECKED BY:	TAZ
DATE:	07/17/15
PROJECT #:	50-168


GROUNDING DETAILS


SHEET NUMBER


1. ALL HARDWARE 18-8 STAINLESS STEEL INCLUDING BELLEVILLES. COAT ALL SURFACES WITH KOPR-SHIELD BEFORE MATING. 2. FOR GROUND BOND TO STEEL ONLY: INSERT A DRAGON TOOTH WASHER BETWEEN LUG AND STEEL, COAT ALL SURFACES WITH KOPR-SHIELD. 3. GROUND BARS, INSTALL BOLT HEAD TOWARD WALL

4. ENCLOSURES, INSTALL BOLT HEAD ON OUTSIDE OF ENCLOSURE

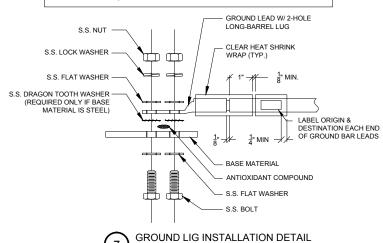

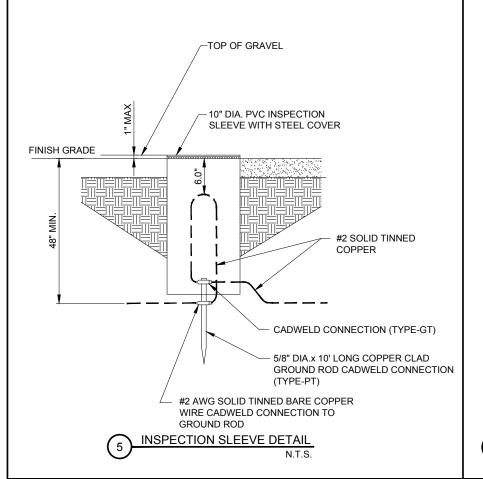


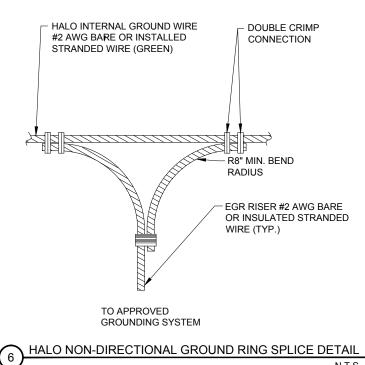


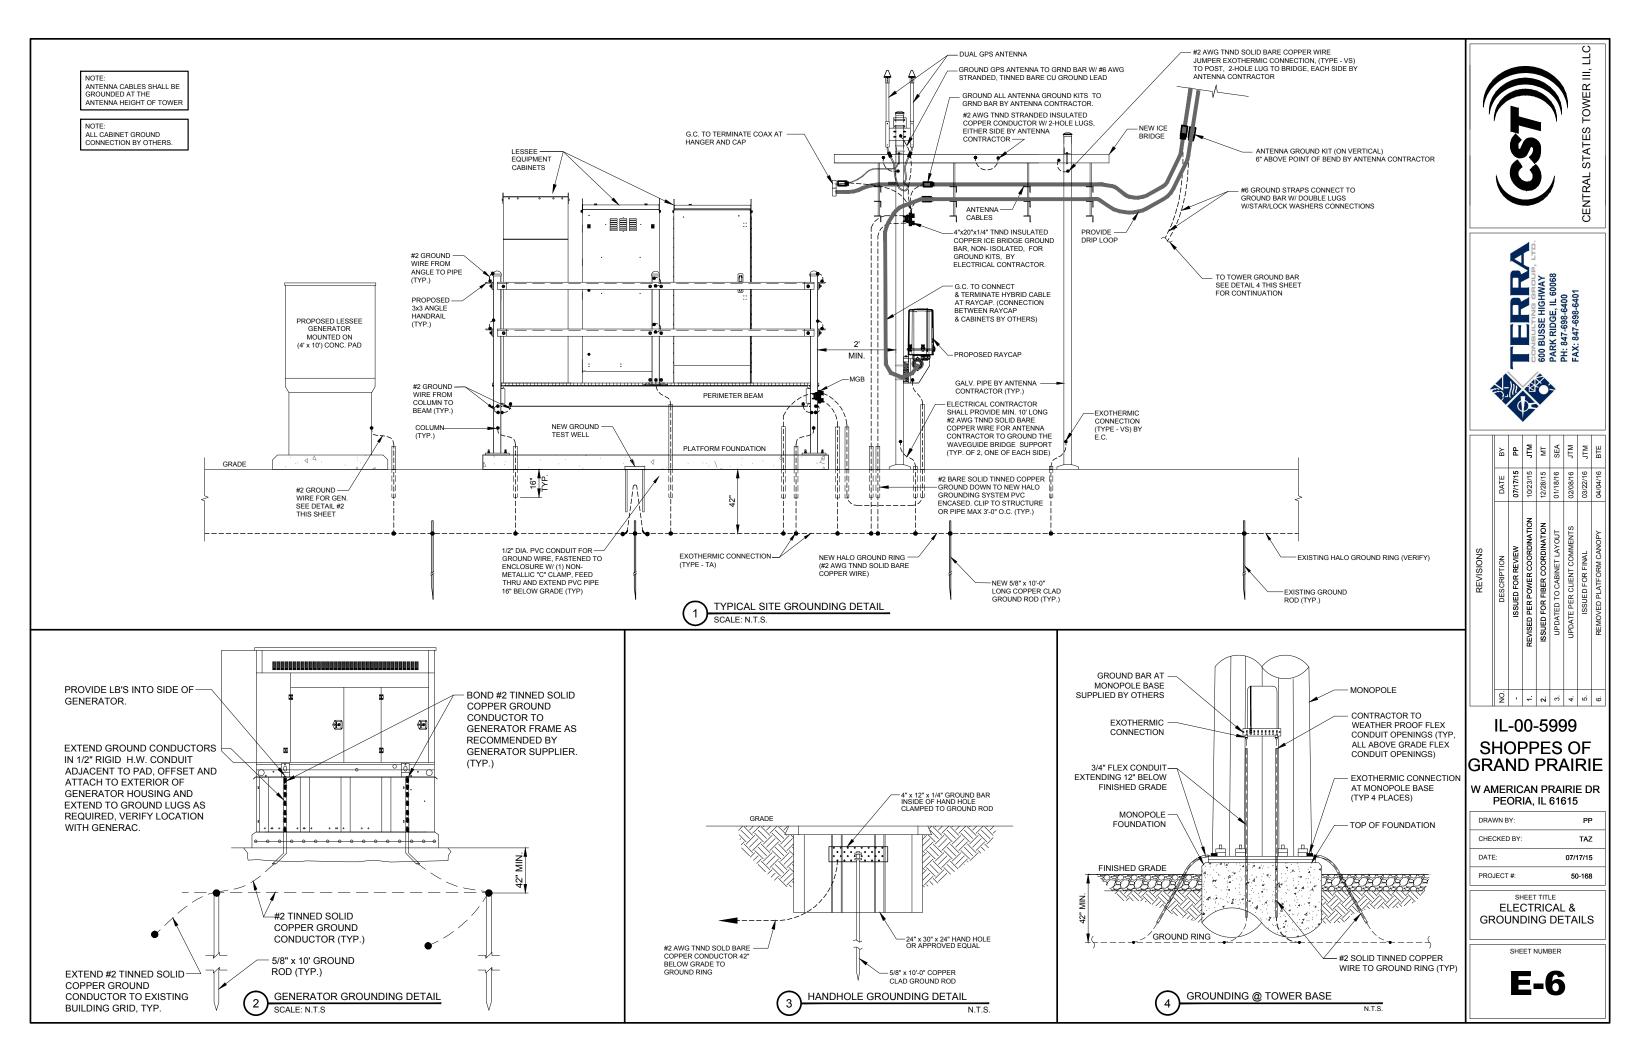


- 1 NOT USED.
- 2 NOT USED.
- (3) 200A ILC W/ ATS MOUNTED TO PLATFORM RAILING. ILC TO BE PROVIDED BY VERIZON WIRELESS AND INSTALLED BE GC.
- (4) EQUIPMENT GROUND BAR
- (5) FIBER CABINET -CHARLES CUBE RL1003A-A (26x22x20)
- (6) 2" Ø POWER CONDUIT TO EQUIPMENT CABINET (BY OTHERS)
- 7 PROPOSED (3) #4/0 UNDERGROUND + (1) #2 GD. SECONDARY ELECTRIC SERVICE IN 3" DIAMETER SCHEDULE 40 PVC

- 8 NOT USED
- (2) 4" FIBER CONDUITS WITH (2) 1-1/4" INNERDUCTS IN EACH CONDUIT FROM FIBER SOURCE TO FIBER ENCLOSURE AT EQUIPMENT AREA
- (1) 2" Ø FIBER CONDUITS TO EQUIPMENT CABINET (BY OTHERS)
- (11) HORIZONTAL SUPPORT MEMBER (UNISTRUT P1000, OR APPROVED EQUAL)
- (12) UNDERGROUND CONDUITS FOR GENERATOR SEE SHEET E-1A
- 12"x12"x6" NEMA-3 DRY CONTACT ALARMS FOR ILC AND GENERATOR.
 LEAVE (2) 25' OF CAT 5 COILED IN BOX FOR EQUIPMENT ENGINEER
 (4 GEN ALARMS AND COMM PWR, SURGE ARRESTOR.)
- 14) 10"x10"x24" LONG NEMA TYPE 3R WIRE THROUGH

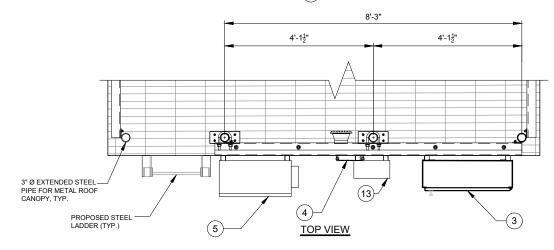

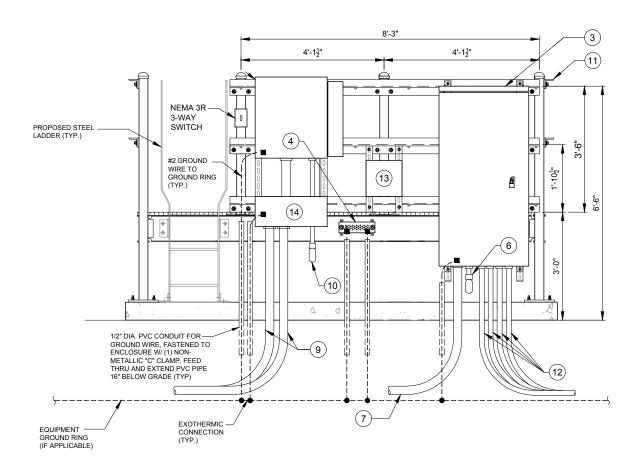



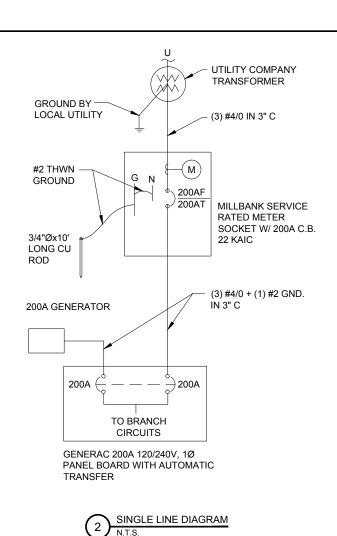





	ВУ	MTC	MT	SEA	MTC	JTM	BTE	BTE
	DATE	12/28/15	01/18/16	10/23/15	02/08/16	03/22/16	04/04/16	04/14/16
REVISIONS	DESCRIPTION	REVISED PER POWER COORDINATION	ISSUED FOR FIBER COORDINATION	UPDATED TO CABINET LAYOUT	UPDATE PER CLIENT COMMENTS	ISSUED FOR FINAL	REMOVED PLATFORM CANOPY	UPDATE PER LL COMMENTS
	Ŏ.	-	2.	_. ن	4.	5.	9.	7.

IL-00-5999 SHOPPES OF GRAND PRAIRIE

W AMERICAN PRAIRIE DR PEORIA, IL 61615


DRAWN BY:	PF
CHECKED BY:	TAZ
DATE:	07/17/1
PROJECT #:	50-168
	CHECKED BY: DATE:

SHEET TITLE

ELECTRICAL DETAILS

SHEET NUMBER

E-7

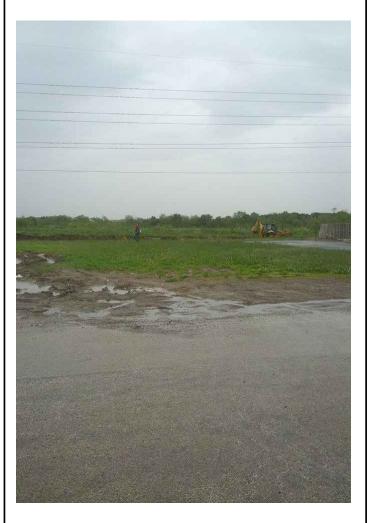





EXISTING OVERALL SITE SCALE: N.T.S.



3 EXISTING TRANSFORMER SCALE: N.T.S.





	ΒΥ	8	MTC	TM	SEA	MTC	MTC	BTE
	м_							
	DATE	07/17/15	10/23/15	12/28/15	01/18/16	02/08/16	03/22/16	04/04/16
		•	1	7	0	0	0	0
REVISIONS	DESCRIPTION	ISSUED FOR REVIEW	REVISED PER POWER COORDINATION	ISSUED FOR FIBER COORDINATION	UPDATED TO CABINET LAYOUT	UPDATE PER CLIENT COMMENTS	ISSUED FOR FINAL	REMOVED PLATFORM CANOPY
	NO.	١.	-	2	က်	4.	2.	9

IL-00-5999 SHOPPES OF GRAND PRAIRIE

W AMERICAN PRAIRIE DR PEORIA, IL 61615

DRAWN BY:	PP
CHECKED BY:	TAZ
DATE:	07/17/15
PROJECT #:	50-168
	CHECKED BY: DATE:

SHEET TITLE

EXISTING SITE PHOTOS

SHEET NUMBER

P-1


GENERAL LANDSCAPE NOTES

- PRUNE NEWLY INSTALLED SHRUBS. WORK SHALL BE DONE BY EXPERIENCED PERSONNEL TO THE ACCEPTED HORTICULTURAL AND ARBORICULTURAL STANDARDS. PRUNING SHALL RESULT IN A LOOSE OUTLINE CONFORMING TO THE GENERAL SHAPE OF THE SHRUB TYPE. DO NOT USE HEDGE SHEARS.
- 2. ALL PLANTING STOCK SHALL BE NURSERY-GROWN IN ACCORDANCE WITH GOOD HORTICULTURAL PRACTICE. PLANTS SHALL BE FREE OF DISEASE, INSECTS EGGS, LARVAE AND DEFECTS SUCH AS KNOTS, SUN-SCALD, INJURIES, ABRASIONS OR DISFIGUREMENT. THEY SHALL HAVE SOUND, HEALTHY VIGOROUS AND UNIFORM GROWTH TYPICAL OF THE SPECIES AND VARIETY, WELL-FORMED, FREE FROM IRREGULARITIES, WITH THE MINIMUM QUALITY AND SIZE CONFORMING TO AMERICAN STANDARD FOR NURSERY STOCK.
- GUARENTEE: WARRANT ALL PLANT MATERIAL TO BE TRUE TO BOTANICAL NAME AND SPECIFIED SIZE. AFTER COMPLETION OF PLANTING, ALL PLANT 3. MATERIALS SHALL BE WARRANTED AGAINST DEFECTS, INCLUDING DEATH AND UNSATISFACTORY GROWTH FOR A WARRANTY PERIOD OF ONE YEAR. THE CONTRACTOR WILL NOT BE RESPONSIBLE FOR DEFECTS RESULTING FROM NEGLECT ABUSE, DAMAGE BY OTHERS, OR UNUSUAL PHENOMENA OR INCIDENTS BEYOND THE CONTRACTORS CONTROL WHICH RESULT FROM NATURAL CAUSES SUCH AS FLOODS STORMS, FIRES OR VANDALISM.

REPLACEMENTS: DURING THE WARANTY PERIOD, REPLACE ONE TIME, AT NO ADDITIONAL COST TO THE OWNER, PLANT MATERIALS THAT ARE DEAD, OR IN THE OPINION OF THE LANDSCAPE ARCHITECT, IN AN UNHEALTHY OR UNSIGHTLY CONDITION. REJECTED PLANT MATERIALS SHALL BE REMOVED FROM THE SITE AT CONTRACTOR'S EXPENSE. REPLACEMENTS ARE TO BE MADE NO LATER THAN THE SUBSEQUENT PLANTING SEASON. RESTORE AREAS DISTURBED BY REPLACEMENT OPERATIONS.

- MULCHING SHALL BE DONE WITHIN 48 HOURS AFTER PLANTING. MULCH SHRUB BEDS TO A UNIFORM DEPTH OF THREE INCHES. MULCH SHALL BE CLEAN COMPOSTED PINE BARK MULCH FREE OF FOREIGN MATERIAL AND LARGE PIECES OVER THREE INCHES LONG. DO NOT MULCH TREE AND SHRUB PLANTING PITS.
- TOPSOIL SHALL CONSIST OF FERTILE FRIABLE NATURAL LOAM, CONTAINING A LIBERAL AMOUNT OF HUMUS AND SHALL BE SUBJECT TO INSPECTION AND APPROVAL. IT SHALL BE FREE OF ADMIXTURES OF SUBSOIL AND FREE OF CRAB GRASS, ROOTS, STICKS AND OTHER EXTRANEOUS MATTER, AND SHALL NOT BE USED FOR PLANTING OPERATIONS WHILE IN A FROZEN OR MUDDY
- REPAIR ALL TURF AREAS BY SEEDING. SEEDING INSTALLATION SHALL BE EXECUTED ONLY AFTER ALL FINISH GRADING HAS BEEN COMPLETED. NO SEEDING WORK SHALL BE DONE PAST SEPTEMBER 15, UNLESS APPROVED BY THE OWNER'S REPRESENTATIVE.


SEED: SEED MIX SHALL MATCH EXISTING TURF, OR BE A 50/50 MIX OF CERTIFIED IMPROVED BLEND OF BLUEGRASS AND CERTIFIED IMPROVED PERENNIAL RYE. MIX SHALL BE APPROVED BY THE OWNER'S REPRESENTATIVE PRIOR TO PLANTING. SEEDING SHALL BE APPLIED AT A MINIMUM RATE OF 120 POUNDS PER ACRE. FUTERRA BLANKET, OR EQUAL, SHALL BE USED FOR EROSION CONTROL MULCH WHERE NECESSARY IN LIEU OF HYDRO MULCH.

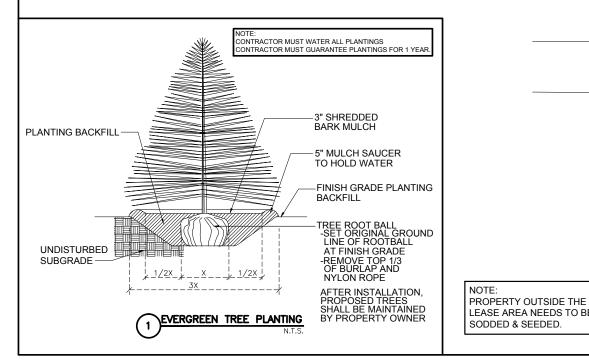

NOTE:

LEASE AREA NEEDS TO BE

SODDED & SEEDED.

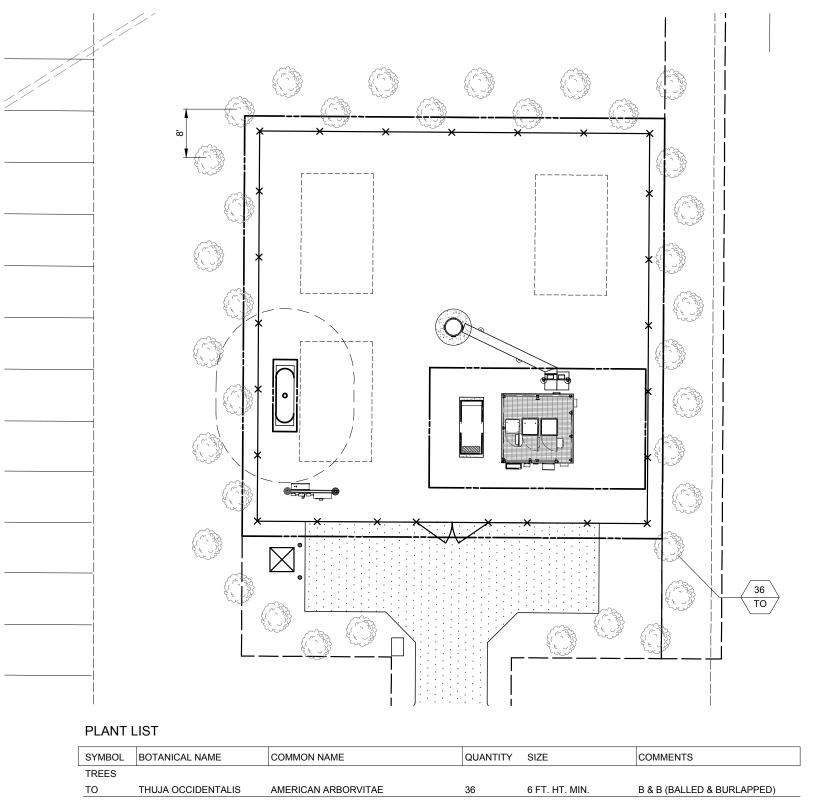

(IF NOT ARBORVITAE ((MOST COMMON)) REFER TO "DIRR'S HARDY" LANDSCAPE BOOK AND/OR INTERNET SEARCH ENGINE FOR SYMBOL, BOTANICAL/COMMON NAME. REMOVE THIS NOTE WHEN DONE.







REVISIONS	DESCRIPTION DATE BY	REVISED PER POWER COORDINATION 12/28/15 JTM	ISSUED FOR FIBER COORDINATION 01/18/16	UPDATED TO CABINET LAYOUT 10/23/15 SEA	UPDATE PER CLIENT COMMENTS 02/08/16 JTM	ISSUED FOR FINAL 03/22/16 JTM	REMOVED PLATFORM CANOPY 04/04/16 BTE	UPDATE PER LL COMMENTS 04/14/16 BTE
RE	NO. DESCF	1. REVISED PER POW	2. ISSUED FOR FIBEF	3. UPDATED TO CA	4. UPDATE PER CLII	5. ISSUED FG	6. REMOVED PLATI	7. UPDATE PER L

IL-00-5999 SHOPPES OF **GRAND PRAIRIE**

W AMERICAN PRAIRIE DR **PEORIA, IL 61615**

DRAWN BY:	PP
CHECKED BY:	TAZ
DATE:	07/17/15
PROJECT #:	50-168

SHEET TITLE LANDSCAPE PLAN

SHEET NUMBER

SURVEYOR'S NOTE

THE PARENT PARCEL BOUNDARY OF THIS DRAWING IS ILLUSTRATED FROM RECORD INFORMATION AND IS APPROXIMATE

THE TOPOGRAPHICAL SURVEY FOR THIS MAP WAS PERFORMED ON MAY 28, 2015.

NOT TO BE USED AS CONSTRUCTION DRAWINGS.

ELEVATION DATUM

ALL FLEVATIONS ARE BASED ON NAVO 88 DATUM CONTOURS ARE ILLUSTRATED AT 1.0' INTERVALS.

BM#1) ELEV. 688.96
BOX CUT ON TOP OF CONCRETE CURB NORTHWEST CORNER OF STRIP MALL.

FLOOD PLAIN INFORMATION

WE HAVE CONSULTED THE FEDERAL EMERGENCY MANAGEMENT AGENCY NATIONAL FLOOD INSURANCE MAP AS PREPARED FOR PEORIA COUNTY. ILLINOIS (UNICORPORATED AREAS), COMMUNITY PANEL NUMBER 170533 0125 B DATED JUNE 1, 1983, AND FIND THAT THE PROJECT SITE IS ZONED C (UNSHADED). AREA OF MINIMAL FLOOD HAZARD, USUALLY DEPICTED ON FIRMS AS ABOVE THE 500-YEAR FLOOD LEVEL.

BASIS OF BEARINGS

LATITUDE AND LONGITUDE OF SITE REFERENCE POINT ARE BASED ON THE HARN (HIGH ACCURACY REFERENCE NETWORK) NADB3 (CORS 96) BEARINGS ARE BASED ON TRUE NORTH AS DETERMINED BY HARN (HIGH ACCURACY REFERENCE NETWORK) NAD83 (CORS 96)

EASEMENTS, COVENANTS, CONDITIONS, AND RESTRICTIONS

THE TITLE COMMITMENT ISSUED BY CHICAGO TITLE INSURANCE COMPANY AS FILE 5245—21501402, DATED JUNE 12, 2015 LISTS THE FOLLOWING EASEMENTS, COVENANTS, CONDITIONS, AND RESTRICTIONS, THAT ARE MATTERS OF SURVEY, AFFECTING THE PARENT PARCEL UNDER "SCHEDULE B":

Reciprocal Construction, Operation and Easement Agreement with Covenants, conditions and restrictions but omitting any covenants or restrictions, if any, including but not limited to those based upon race, color, religion, sex, sexual orientation, familial status, marital status, disability, handicap, national origin, ancestry, source of income, gender, gender identity, gender expression, medical condition or genetic information, as set forth in applicable state or federal laws, except to the extent that said covenant or restriction is permitted by applicable law as set, forth in the document

Recording Date: September 14, 1995 Recording No: 95-22404
First Amendment thereto. Recording Date: March 22, 1999 Recording No: 99-09698. AFFECTS THE PARENT PARCEL DOES NOT AFFECT THE PROJECT SITE.

- Reciprocal Easement and Agreement and Deciaration of Covenants, conditions and restrictions but omitting any covenants or restrictions, if any, including but not limited to those based upon race, color, religion, sex, sexual orientation, familial status, marital status, disability, handicap, national origin, oncestry, source of income, gender, gender identity, gender expression, medical condition or genetic information, as set forth in applicable state or federal laws, except to the extent that said covenant or restriction is permitted by applicable law, as set forth in the document Recording Date: August 4, 2003 Recording No: 03-37492. AFFECTS THE PARENT PARCEL AS SHOWN. APPROXIMATE LOCATION SHOWN PLAT NOT PROVIDED.
- Easement Agreement with Declaration of Covenants, conditions and restrictions but omitting any covenants or restrictions, if any, including but not limited to those based upon race, color, religion, sex, sexual orientation, familial status, marital status, disability, handicap, national origin, ancestry, source of income, gender, gender identity, gender expression, medical condition or genetic information, as set forth in applicable state or federal laws, except to the extent that said covenant or restriction is permitted by applicable law, as set forth in the document Recording No: 04–20851.
- Easement(s) for the purpose(s) shown below and rights incidental thereto as set forth in a document: set forth in a document:
 In favor of: Central lilinois Light Company, its successors and/or assigns
 Purpose: Electric and Gas Underground
 Recording Date: December 1, 2003
 Recording No: 03-58722 DOES NOT AFFECT THE PARENT PARCEL AFFECTS THE
 PROPOSED INGRESS/EGRESS & UTILITY EASEMENT
- Eosement(s) for the purpose(s) shown below and rights incidental thereto as delineated or as offered for dedication, on the map of soid tract/plat; Purpose: Ingress and Egress; Sanitary Sewer, Utility Recording No: 04-20848. AFFECT THE PARENT PARCEL AFFECT THE PROPOSED INGRESS/EGRESS & UTILITY FASEMENT.

 LEASE SITE DETAIL

SCALE 1"=20" PROPOSED 10.00' WIDE UTILITY EASEMEN S89 38 20 E 70.00 LOT 19 ROPOSED TOWER VACANT LOT P.O.B. 70'X70'-NB9"38'20"W 70.00' N89'38'20"W 35.00' N89'38'20"W 35.00'V INGRESS /FGRESS & UTILITY EASEMENT PROPOSED 20.00' WIDE-P.O.B. 10.00' WIDE UTILITY EASEMENT INGRESS/EGRESS &

ZONING DATA


REAR: 7

ACCORDING TO THE SITE CANDIDATE
INFORMATION PACKAGE THIS SITE IS ZONED: 2020 W WAR MEMORIAL DR. #103
PEORIA, IL 61614

PROPRIETOR

NORTHWEST PEORIA RETAIL DEVELOPMENT, LP

SHOPPES OF **GRAND PRAIRIE** IL-00-5999

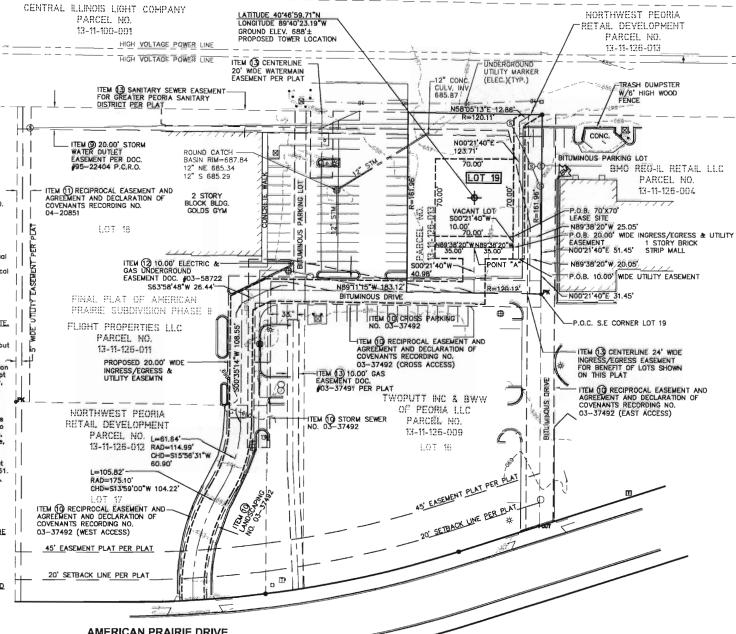

AMERICAN PRAIRIE DRIVE

LEGAL DESCRIPTION

PARENT PARCEL
Lot 19 of AMERICAN PRAIRIE SUBDIVISION, PHASE II, a resubdivision of Lots Lot 19 of AMENICAN PHAINIE SUBJIVISION, PHASE II, a resubdivision of Lots 14 & 15 in American Prairie Subdivision, (being recorded as document no. 03-37491 at the Peorla County Recorders Office), being a subdivision of the Northwest Quarter of Section 11, Township 9 North, Range 7 East of the Fourth Principal Meridian, recorded June 3, 2004 as document no. 04-20848 in Plat Book 9, page 26.

Together with a non-exclusive easement for ingress and egress for the benefit of the above described tract, as created by Easement Agreement dated _____ as document no. ____

LEGAL DESCRIPTION

PROPOSED 70'X70' LEASE STIE
All that part of Lot 19 in the final plat of American Prairie Subdivision, Phase II a All that part of Lot 19 in the final plat of American Prairie Subdivision, Phase II a resubdivision of Lots 14 & 15 in American Prairie Subdivision, (being recorded as document number 03-37491 at the Peorla County Recorders Office), being a Subdivision of part of the Northwest 1/4 of Section 11, Township 9 North, Range 7 East of the Fourth Principal Meridian, City of Peorla, Peorla County, Illinois, as recorded in document number 04-20848 in Plat Book 9, page 26, Peorla County Recorder's Office, described as: Commencing at a found pt noil the Southeast corner of sold Lat 19; thence North 021140° East 51.45 feet along the East line of sold Lot; thence North 89'38'20° West 25.05 feet TO THE PLACE OF BEGINNING OF THIS DESCRIPTION; thence North 89'38'20° West 70.00 feet; thence North 00'21'40° Cool feet; thence South 89'38'320° East 70.00 feet; thence South 00'21'40° West 70.00 feet; thence South 89'38'20° this description.

LEGAL DESCRIPTION


PROPOSED 20.00' WIDE INGRESS/EGRESS & UTILITY EASEMENT

PROPOSED 20.00" WIDE INGRESS/EGRESS & UTILITY EASEMENT
A 20.00 foot wide easement for ingress/egress & utilities in that part
of Lats 16, 17, 18, and 19 in the final plat of American Prairie
Subdivision, Phase II a resubdivision of Lats 14 & 15 in American Prairie
Subdivision, (being recorded as document number 03—37491 at the
Peoria County Recorders Office), being a Subdivision of part of the
Northwest 1/4 of Section 11, Township 9 North, Range 7 East of the
Fourth Principal Meridian, City of Peoria, Peoria County, Illinois, as
recorded in document number 04—20848 in Plat Book 9, page 26,
Peoria County Recorder's Office, the centerline of which is described as:
Commencing at a found pk noil the Southeast corner of said Lot 19;
thence North 00'21'40" East 51.45 feet along the East line of said Lot;
thence North 00'21'40" East 51.45 feet along the East line of said Lot;
thence North 89'30'20" West 25.05 feet; thence South 00'21'40" West
10.00 feet TO THE PLACE OF BEGINNING OF THIS CENTERLINE
DESCRIPTION; thence North 89'38'20" West 25.00 feet to point "A";
thence South 00'21'40" West 40.98 feet; thence North 89'11'15" West
183.12 feet; thence South 63'56'48" West 26.44 feet; thence South
60'35'14" West 108.55 feet; thence South 50'56'48" West 26.44 feet; dong a 114.99
foot curve to the right, the chord of which bears South 15'56'31" West
60.99 feet; thence Southerly 105.82 feet along a 175.10 foot radius curve
to the left the chord of which bears South 13'59'00" Vest 104.22 feet
to the northerly right of way line of American Prake Prake Provision. to the northerly right of way line of American Prairie Drive (86" wide) for the place of ending of this centerline description; thence recommencing at the oforedescribed point "A" FOR THE PLACE OF BEGINNING OF THIS CENTERLINE DESCRIPTION; thence North 89"38"20" West 35.00 feet to the place of ending of this centerline description. Sidelines should be lengthened or shortnesd to intersect at the northerly right of way line of American Prairie Drive (66" wide).

LEGAL DESCRIPTION PROPOSED 10.00' WIDE UTILITY EASEMENT

PROPOSED 10.00" MIDE UTILITY EASEMENT
A 10.00 foot wide easement for utilities in that part of Lot 19 in the final plat of American Prairie Subdivision, Phase III a resubdivision of Lots 14 & 15 in American Prairie Subdivision of Lots 14 & 15 in American Prairie Subdivision of Lots 14 & 15 in American Prairie Subdivision of Lots 14 & 15 in American Prairie Subdivision of Lots 14 & 15 in American Prairie Subdivision of Lots 14 & 15 in American Prairie Subdivision of Lots 17 & 15 in American Prairie Subdivision of Dart of the Northwest 1/4 of Section 11, Township 9 North, Range 7 East of the Fourth Principal Meridian, City of Peoria, Peoria County, Illinois, as recorded in document number 04–20848 in Plat Book 9, page 28, Peoria County Recorder's Office, the centerline of which is described as:
Commencing at a found pk nail the Southeast comer of sald Lot 19; thence North 002140° East 123.71 feet; thence North 58/0513° East 12.85 feet to THE PLACE OF BEGINNING OF THIS CENTERLINE DESCRIPTION; thence North 002140° East 123.71 feet; thence North 58/0513° East 12.85 feet to the north line of sald Lot 19 for the place of ending of this centerline description. Sidelines should be lengthened or shortened to intersect at the north line of Lot 19.

Note: This certification only applies to improvements within the lease site and easements as monumented shown

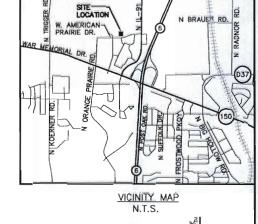



NOTE: THE ORIGINAL SCALE (1"=40") OF THIS DRAWING WAS PREPARED AS A 24"X36" DRAWING ANY OTHER SIZE DRAWING IS AT A REDUCED SCALE

<u>LEGENI</u>	<u>D</u>
TRAVERSE POINT	AG - AC UNIT
A - WELL	0 - U.G. UTILITY MARKER
- HIGHWAY	A - FIRE HYDRANT
- MONUMENT	- POST INDICATOR VALVE
MONUMENT BOX	· WATER VALVE
■ RIGHT OF WAY MARKER	
□ - SET WOODSTAKE	O - UST FILL PORT GAS PUMP
+cut - xcut	G GAS METER
oPK PK NAIL	W WATER METER
O - FOUND IRON STAKE	TELEPHONE RISER
 SET IRON STAKE 	E - ELECTRIC METER
- SICN	TV - CABLE TV RISER
ER = RR SIGN	= CATCH BASIN
	# - ROUND CATCH BASIN
	O - UTILITY MANHOLE
	O - STORM MANHOLE
# - LIGHT POLE	S - SANITARY MANHOLE
	E - ELECTRIC MANHOLE
 POST 	TELEPHONE MANHOLE
	W - WATER MANHOLE
SB#XX	- HANDICAP PARKING SI
WE - MAILBOX	- SHRUB
) - SATELLITE DISH	- SHRUB
D - HAND HOLE	- PINE TREE
·	- EXISTING CONTOURS
	- TELEPHONE UTILITY LINE
_ · _ · _ · _ · _ ·	- ELECTRIC UTILITY LINE
	- WATER UTILITY LINE
	- GAS UTILITY LINE
	- STEAM UTILITY LINE - STORM UTILITY LINE
	- SIDRM UTILITY LINE
	- FIBER OPTIC UTILITY LINE
	- OVERHEAD UTILITY LINE
J	EDIOC LINE

- GUARD RAIL

M dimensions shown are in feet and decimal parts thereof

Note: This certification only applies to improvements within the lease site and easements as monumented shown

ILLINOIS REGISTERED DESIGN FIRM LICENSE NUMBER 184,007034 LICENSE EXPIRES: APRIL 30, 2017



SHOPPES OF **GRAND PRAIRIE** IL-00-5999



REVISIONS NO. DESCRIPTION DATE xx/xx/xx

williams&works ONAL LAND RANDY J.



UPDATE: WBM031416 CHKD BY: R.J.K.

PROJECT NO.: 213061.061 SITE NAME

SHOPPES OF **GRAND PRAIRE**

SITE NUMBER

L-00-5999

SITE ADDRESS

W AMERICAN PRAIRIE DR. (NEAR 5121 W AMERICAN PRAIRE DR PEORIA, IL 61615

SHEET TITLE