

# ILLINOIS

# AMERICAN WATER CO. ORANGE PRAIRIE ROAD WATER MAIN EXTENSION PEORIA, ILLINOIS

# INDEX OF SHEETS

COVER SHEET & SUMMARY OF QUANTITIES LEGEND, GENERAL NOTES & CONTROL POINTS

WATER MAIN PLAN & PROFILE SHEETS 15-16 WATER MAIN CONSTRUCTION DETAILS

# LIST OF UTILITY COMPANIES

ATT (DISTRIBUTION) (309 - 686 - 3316)KENT KOWALSKE AMEREN GAS & ELECTRIC (309-693-4839)COMCAST (CABLE & TELEPHONE) KIRK KROMPHARDT

(309-686-2616)GREATER PEORIA SANITARY DISTRICT MARIA ZAVALA

DARRELL SENIOR FRONTIER COMMUNICATIONS (309 - 827 - 1253)

I.A.W.C. JIM RAY (309 - 566 - 4108)I.A.W.C. MATT WHITE

MEDIACOM DENNIS JARDING (309-743-4750)

WINDSTREAM/PAETEC (FIBER) MARK MILLS (217-876-7194) ×240

> DAVID FEREIRA (309-253-0930)


JOHN O'FLAHERTY

(309-272-4844)


(309-208-8366)

CITY OF PEORIA KEN ANDREJASICH (309-494-8815)

THE LIST PROVIDED IS FOR INFORMATION ONLY. THE CONTRACTOR SHALL BE RESPONSIBLE FOR CONTACTING J.U.L.I.E FOR UTILITY LOCATIONS PRIOR TO BEGINNING ANY WORK.

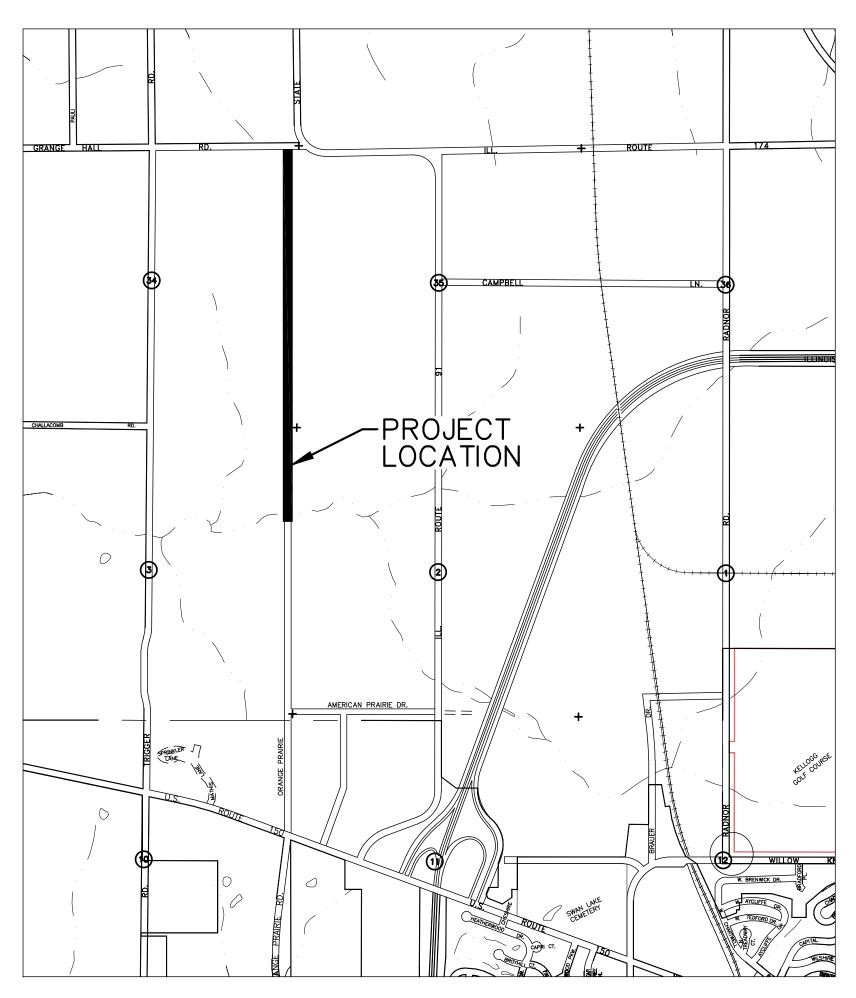

LOCATION MAP

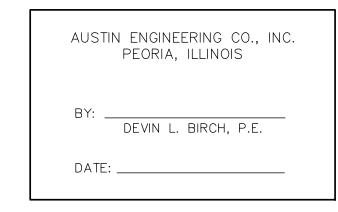



J.U.L.I.E. 1-800-892-0123

# SUMMARY OF QUANTITIES

<u>ITEM</u>	QUAN	<u> TITY</u>
WATER MAINS, D.I., PRESS. CL. 350, 6" (HYDRANT LATERALS)	45	FT
WATER MAINS, D.I., PR. CL. 350, 12" (W/ POLYWRAP, TRACER WIRE & BURY TAPE)	6,258	FT
WATER MAIN ENCASEMENT, PVC, CL. 150, 24"	60	FT
MJ GATE VALVE & BOX, 6"	11	EΑ
MJ GATE VALVE & BOX, 12"	13	EΑ
MJ TEE, 12" x 6"	11	EΑ
MJ 11.25° ELBOW, 12"	4	EΑ
MJ 22.5° ELBOW, 12"	2	EΑ
MJ 45° ELBOW, 12"	2	EΑ
MJ 90° ELBOW, 6"	11	EA
MJ REDUCER, 8" x 6"	1	EΑ
MUELLER 3-WAY HYDRANTS, 6"	12	EA
SERVICE INSTALL (BACTI SAMPLE LOCATIONS)	7	EΑ

A	★ ILLINOIS MERICAN WATER CO.	ORANGE PRAIRIE ROAD  WATER MAIN EXTENSION PEORIA, ILLINOIS		
DATE	REMARKS	ENGINEERING DEPARTMENT PEORIA WATER DISTRICT 7500 N. HARKER DR., PEORIA, IL 61615		
		AUSTIN	ENGINEERING CO., I	NC.
		PEORIA	LICENSE No. 184-001143 ILI	LINOIS
		COVER SHEET		
		DATE: 1/29/13	PROJECT NUMBER	

SHEET NO. 1 OF 16

#### I.A.W.C. WATER MAIN NOTES:

ALL WATER MAIN (PUBLIC OR PRIVATE) INSTALLATION SHALL BE CONSTRUCTED IN ACCORDANCE WITH "THE STANDARD SPECIFICATIONS FOR WATER AND SEWER MAIN CONSTRUCTION IN ILLINOIS". CURRENT EDITION: THE STANDARDS AND SPECIFICATIONS OF ILLINOIS AMERICAN WATER COMPANY; AND THE ILLINOIS ENVIRONMENTAL PROTECTION AGENCY REGULATIONS 35 IAC, SUBTITLE F. IN CASE OF CONFLICT, THE MORE STRINGENT SPECIFICATIONS SHALL APPLY.

MAINTAIN 10 FEET HORIZONTAL CLEARANCE BETWEEN WATER MAIN AND SANITARY SEWER, STORM SEWER, AND/OR SANITARY SERVICES. AT LOCATIONS WHERE THIS IS NOT POSSIBLE, THE BOTTOM OF THE WATER MAIN SHALL TO BE AT LEAST 18 INCHES ABOVE THE TOP OF STORM OR SANITARY SEWERS.

WHERE NEW WATER MAIN IS TO BE INSTALLED UNDER EXISTING OR PROPOSED STORM OR SANITARY SEWERS, OR WITHIN 18 INCHES ABOVE AN EXISTING OR PROPOSED STORM OR SANITARY SEWER, THE NEW WATER MAIN SHALL BE ENCASED IN WATER MAIN QUALITY CONDUIT MEETING THE REQUIREMENTS OF IL ADMIN CODE TITLE 35, SUBTITLE F SECTION 653.111.A, USING CASING SPACERS FOR A DISTANCE OF TEN (10) FEET ON EACH SIDE OF SAID STORM OR SANITARY SEWER CROSSING AND THE ENDS OF THE CASING SHALL BE SEALED WITH CEMENT MORTAR OR APPROVED EQUAL. STEEL CASING PIPE SHALL MEET OR EXCEED ASTM A-139, GRADE B. MINIMUM ALL THICKNESS SHALL BE IN ACCORDANCE WITH THE STANDARD SPECIFICATIONS FOR WATER AND SEWER MAIN CONSTRUCTION IN ILLINOIS. ALL WATER MAIN SEPARATION WORK IS INCIDENTAL TO THE CONTRACT.

THE CONTRACTOR SHALL COORDINATE WITH ILLINOIS AMERICAN WATER COMPANY FOR ALL TAPS, CONNECTIONS AND TEMPORARY SHUTDOWNS.

THE WATER MAIN SHALL BE DUCTILE IRON, PRESSURE CLASS 350, CEMENT LINED W/ 8-MIL POLYWRAP AND MEET THE REQUIREMENTS OF ANSI/AWWA A21.51/C151.

WATER MAIN JOINTS SHALL BE SLIP JOINTS AND SHALL MEET THE REQUIREMENTS OF ANSI/AWWA A21.11/C111, UNLESS OTHERWISE NOTED. WATER MAIN, UNLESS OTHERWISE NOTED IN THE PLANS SHALL BE NO LESS THAN 42" DEEP AND NO DEEPER THAN 54" WITHOUT I.A.W.C. APPROVAL.

WATER LINE FROM MAIN TO FIRE HYDRANTS SHALL BE D.I., PRESS. CL. 350, 6".

FIRE HYDRANTS SHALL BE 3-WAY, 4 1/4" VALVE OPENING, 6" INLET, AND CONFORM TO ILLINOIS AMERICAN, AND CITY OF PEORIA FIRE DISTRICT STANDARDS.

WATER MAIN FITTINGS SHALL MEET THE REQUIREMENTS OF ANSI/AWWA A21.53/C153 AND BE WRAPPED WITH VISQUEEN PRIOR TO THRUST BLOCKING WITH POURED-IN-PLACE CONCRETE. SOLID MASONRY UNITS MAY BE USED FOR THRUST BLOCKING PURPOSES. CONCRETE THRUST BLOCKS SHALL BE PROVIDED AT ALL WATER MAIN TEES, CAPS, VALVES, HYDRANTS AND BENDS 11-1/4" DEGREES OR GREATER.

CONTRACTOR SHALL PROVIDE PERMANENT AND TEMPORARY RESTRAINTS AND THRUST BLOCKS AS NEEDED FOR PRESSURE TESTING OF WATER MAINS AND LATERALS. CONTRACTOR SHALL FILL THE PIPES AS SLOWLY SO AS NOT TO GENERATE MOMENTUM CHANCES AT FITTINGS. THE AIR IS TO BE EXPELLED UPON FILLING AND/ALL AIR IS TO BE EXPELLED PRIOR TO PRESSURE TESTING.

DISINFECTION AND TESTING OF WATER MAIN SHALL PRECEDE INSTALLATION OF SERVICES. WHEN APPLICABLE. THE CONTRACTOR SHALL COORDINATE ALL TESTING OF THE WATER MAIN WITH THE ENGINEER, AND A I.A.W.C. REPRESENTATIVE PRIOR TO PERFORMING ANY TESTS. ALL TESTING SHALL BE PERFORMED IN THE PRESENCE OF AN I.A.W.C. REPRESENTATIVE AND MEET I.A.W.C. STANDARDS.

PRIOR TO PLACING THE WATER MAIN AND EQUIPMENT INTO SERVICE, SATISFACTORY LABORATORY BACTERIOLOGICAL ANALYSIS MUST BE OBTAINED FROM THE LOCATION IDENTIFIED AND NOTED ON PLANS, IN ACCORDANCE WITH "STANDARD SPECIFICATIONS FOR WATER AND SEWER MAIN CONSTRUCTION IN ILLINOIS", CURRENT EDITION AND THE TESTS SHALL BE WITNESSED AND HAND DELIVERED BY AN I.A.W.C. REPRESENTATIVE TO THE I.A.W.C. LAB. THE CONTRACTOR SHALL INSTALL A 1" CORPORATION, AND 1" POLY LINE FOR TESTING. THE LOCATION OF THE TAPS WILL BE DETERMINED BY I.A.W.C., AND SHALL REMAIN CLOSED AFTER TESTING AND SAMPLES HAVE PASSED. THE CONTRACTOR SHALL REMOVE THE 1" PIECE OF POLY PIPE, AND STUB OUT AND CRIMP A 1" PIECE OF COPPER. THIS WORK INCLUDING ALL LABOR, EQUIPMENT, AND MATERIAL SHALL BE CONSIDERED INCIDENTAL TO THE MAIN SAMPLING. THE LOCATIONS OF THE CORPORATIONS SHALL BE NOTED ON THE AS-BUILT PLANS, AND MAY BE USED AS FUTURE SERVICES IF APPROVED BY I.A.W.C.

DISINFECTION REQUIREMENTS:

CHEMICAL USED: CHLORINE INITIAL DISINFECTION CONCENTRATION: CONFORM TO SPECIFICATION 15020

FINAL DISINFECTION CONCENTRATION: 10 PPM (MINIMUM) RETENTION TIME: 24 HOURS


WHERE THE WATER MAIN TRENCH CROSSES OR IS WITHIN TWO (2) FEET OF THE EDGE OF PAVEMENT, CURB, GUTTERS, CURB AND GUTTER, PATHS, OR SIDEWALKS, THE TRENCH SHALL BE BACKFILLED WITH AN APPROVED BACKFILL MATERIAL OR CONTROLLED LOW STRENGTH MATERIAL (FLOWABLE FILL) IN ACCORDANCE WITH THE CITY OF PEORIA STANDARDS AND NOTED IN THE CONSTRUCTION PLANS. PRIOR TO PLACING THE FLOWABLE FILL, THE CONTRACTOR SHALL PLACE 1'-0" OF SAND MATERIAL OVER THE WATER MAIN IN ACCORDANCE WITH I.A.W.C. STANDARDS. ALL WORK WITHIN THE CITY OF PEORIA RIGHT-OF-WAY SHALL BE INSPECTED BY A CITY OF PEORIA REPRESENTATIVE PRIOR TO PLACING ANY MATERIALS.

CONTRACTOR SHALL COORDINATE ANY INTERUPTION IN SERVICE WITH THE OWNER. CONTACT JAMES RAY WITH ILLINOIS AMERICAN WATER AT 309-566-4108. A MINIMUM OF ONE WEEK NOTICE IS REQUIRED.

THE WATER MAIN CONTRACTOR SHALL BE ON ILLINOIS AMERICAN WATER COMPANY PREQUALIFICATION LIST PRIOR TO BIDDING, INCLUDING ANY SUB-CONTRACTORS.


THE CONTRACTOR SHALL INSTALL WHEN APPLICABLE ANY EROSION CONTROL MATERIALS NECESSARY TO CONTAIN OR PREVENT EROSION OF DISTURBED AREAS AS PER EPA MINIMUM REQUIREMENTS.

# ₽ & C ORANGE PRAIRIE ROAD

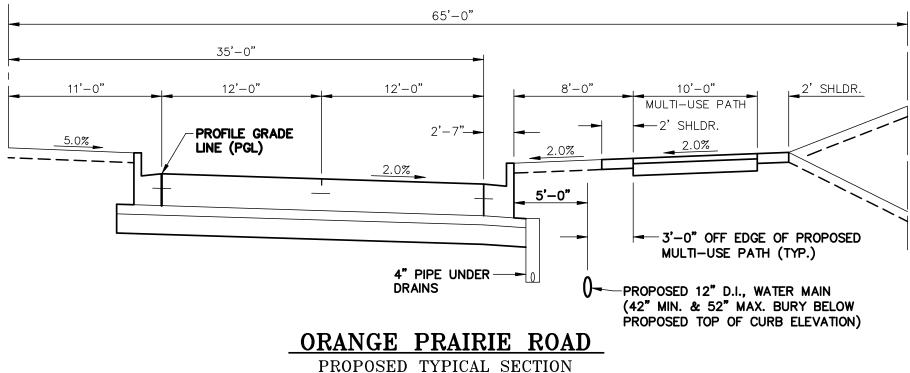

(STA. 58+25.0 TO STA. 90+50.0)

# ₽ & C ORANGE PRAIRIE ROAD

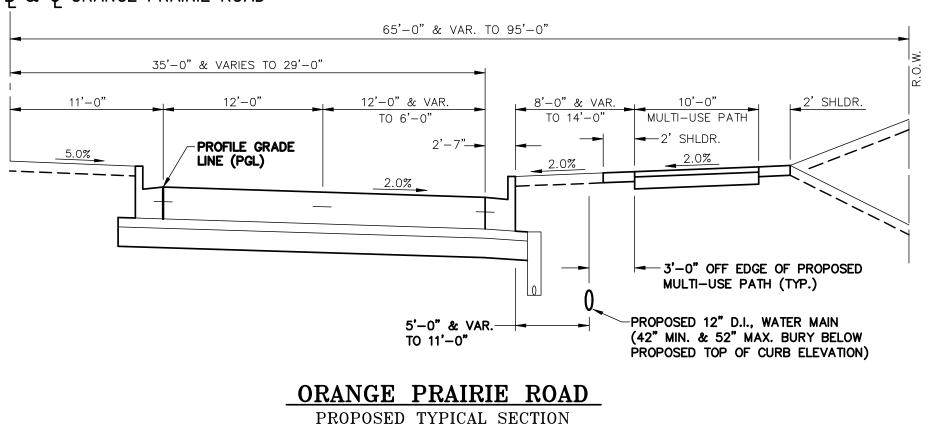

(STA. 90+50.0 TO STA. 95+96.0)

# **GENERAL NOTES:**

THIS PROJECT IS BEING DESIGNED FOR ILLINOIS AMERICAN WATER COMPANIES WATER MAIN EXTENSION ALONG ORANGE PRAIRIE ROAD AS SHOWN IN THE PLANS. THE CONTRACTOR SHALL COORDINATE ALL WORK WITH ILLINOIS AMERICAN WATER COMPANIES REPRESENTATIVE. CONTRACTOR SHALL REFER TO THE SPECIFICATIONS AND CONSTRUCTION NOTES FOR ADDITIONAL INFORMATION.

THE CONTRACTOR SHALL BE RESPONSIBLE FOR LOCATING AND PROTECTING ALL UNDERGROUND UTILITIES DURING CONSTRUCTION IN ACCORDANCE WITH THE SPECIFICATIONS AND CONSTRUCTION CONTRACT DOCUMENTS.

ILLINOIS AMERICAN WATER COMPANIES REPRESENTATIVE IS JAMES RAY (309)-566-4108.

THE CONTRACTOR SHALL CONTINUOUSLY INSPECT ALL LINES AND GRADES AS SHOWN IN THE PLANS WITH THE ACTUAL LINES AND GRADES PLACED ON SITE. ANY DISCREPANCIES THAT MAY AFFECT THE PERFORMANCE OF THE WORK IN ACCORDANCE WITH THE INTENT OF THE CONTRACT SHALL BE IMMEDIATELY REPORTED TO THE ENGINEER IN WRITING BEFORE PROCEEDING WITH THE WORK. THE CONTRACTOR SHALL TAKE FULL RESPONSIBILITY FOR ANY WORK COMPLETED PRIOR TO REPORTING ANY DISCREPANCIES TO THE OWNER OR ENGINEER WITH NO ADDITIONAL COMPENSATION ALLOWED FOR CORRECTION OF THE WORK.

THE CONTRACTOR, WITH I.A.W.C., CITY OF PEORIA, AND THE ENGINEER WILL HAVE A PRE-CONSTRUCTION MEETING PRIOR TO STARTING THE PROJECT AND SHALL FOLLOW THE PLANS AS DISCUSSED IN THE PRE-CONSTRUCTION MEETING. DURING THE PRE-CONSTRUCTION MEETING THE CONTRACTOR WILL SIGNOFF ON HIS RESPONSIBILITIES AS OUTLINED IN THE PLANS AND WILL BE RESPONSIBLE FOR OBTAINING ALL NECESSARY PERMITS, AND PAYMENTS OF ASSOCIATED FEES PRIOR TO BEGINNING ANY CONSTRUCTION. ANY CHANGES TO THE PLANS DURING CONSTRUCTION WILL NOT BE PERMITTED WITH OUT APPROVAL FROM I.A.W.C., OR THE ENGINEER.

CONTRACTOR SHALL BE RESPONSIBLE FOR PREPARING AND SUBMITTING FINAL AS-BUILT DRAWINGS ON THE STANDARD FORM DAILY CONSTRUCTION SHEETS NO LESS THAN EVERY OTHER DAY TO I.A.W.C., AND ENGINEER.

CONSTRUCTION STAKING, LAYOUT, GRADING AND MATERIAL TESTING SHALL BE THE RESPONSIBILTY OF THE CONTRACTOR.

WHEN WORKING AROUND PROPERTY MARKERS AND SUBDIVISION MONUMENTS, THE CONTRACTOR SHALL TAKE THE NECESSARY CARE IN ORDER TO PRESERVE THE INTEGRITY OF THE MARKERS AND MONUMENTS. IF ANY MARKERS OR MONUMENTS ARE ENCOUNTERED, THE OWNERS REPRESENTATIVE SHALL BE NOTIFIED BEFORE SUCH MARKERS AND MONUMENTS ARE REMOVED OR UNTIL AN AUTHORIZED SURVEYOR HAS WITNESSED OR REFERENCED THEIR LOCATIONS.

THE CONTRACTOR SHALL BE RESPONSIBLE DURING CONSTRUCTION FOR THE PROTECTION AND CLEANING FOR ALL WORK WITHIN THE CORPORATE LIMITS OF THE CITY OF PEORIA UNDER THE CONTRACT, UNTIL FINAL COMPLETION AND ACCEPTANCE THEREFOR. THE CONTRACTOR SHALL KEEP THE ROADWAY CLEAR OF MUD, DIRT AND DEBRIS DURING CONSTRUCTION. CLEANING SHALL BE DONE IN AN ACCEPTABLE MANNER, WITH EQUIPMENT THAT DOES NOT DAMAGE THE EXISTING PAVEMENT. THIS WORK SHALL BE CONSIDERED INCIDENTAL TO THE PAY ITEM "WATER MAINS, D.I., PRESS. CL 350, 12", WHICH SHALL INCLUDE ALL LABOR, REMOVAL, DISPOSAL AND EQUIPMENT NECESSARY TO COMPLETE THE

#### WORK OPERATION NOTES:

#### WORK BY OTHERS:

THE CONTRACTOR SHALL COORDINATE AND NOTIFY ALL LOCAL MUNICIPALITIES & UTILITY COMPANIES AS TO WHEN WORK MAY BEGIN. I.A.W.C. SHALL BE NOTIFIED NO LESS THAN 48 HOURS FOR ANY MAIN SHUTDOWNS, TAPS, VALVE WORK OR HYDRANT FLUSHING. THE CONTRACTOR WILL **NOT** BE ALLOWED TO EXERCISE OR REMOVE ANY EXISTING VALVES, WATER SERVICES OR HYDRANTS. I.A.W.C. CONTACT WILL BE MATT WHITE AT 309-208-8366. PRIOR TO CONSTRUCTING THE WATER MAIN. ANY UTILITY ADJUSTMENTS OR RELOCATIONS IF NEEDED, MAY BE DONE BY THE FOLLOWING: AMEREN GAS & ELECTRIC, ALL LOCAL AND LONG DISTANCE CARRIERS, ALL CABLE & FIBER OPTIC

#### **SEQUENCE OF OPERATIONS:**

SYSTEMS, AND THE GREATER PEORIA SANITARY DISTRICT.

ONCE THE CONTRACTOR HAS RECEIVED ALL NECESSARY PERMITS, THE CONTRACTOR CAN BEGIN CONSTRUCTING THE WATER MAIN AT DEPTHS AND LOCATIONS AS NOTED ON THE PLANS, AND FOLLOW THE REQUIREMENTS FOR TRENCH BACKFILL WHERE NOTED ON THE PLANS WHEN APPLICABLE, INCLUDING ANY TESTING. THIS WORK ALSO INCLUDES, BUT IS NOT LIMITED TO THE INSTALLATION OF SELECT VALVES AND BOXES, MISCELLANEOUS FITTINGS AND APPURTENANCES, EXCAVATION FOR CONNECTIONS TO EXISTING WATER MAINS, SITE RESTORATIONS AS DETAILED AND NOTED ON THE PLANS.

**LEGEND ABBREVIATIONS** - - - 720 - EXISTING CONTOUR AGGREGATE — — → — EXISTING SANITARY SEWER BACK OF CURB — — → EXISTING STORM SEWER BITUMINOUS — — — W − — — EXISTING WATER MAIN - BASE LINE EXISTING SANITARY MANHOLE BY OTHERS EXISTING STORM MANHOLE - CENTERLINE  $\square$ EXISTING STORM INLET CONC. - CONCRETE CONSTRUCTION LIMITS - - OT- - EXISTING OVERHEAD CABLE TV CONTROL POINT - - G - - EXISTING GAS LINE D.I. DUCTILE IRON - - - CTV - EXISTING CABLE TV DIAMETER — — FIBER — — EXISTING FIBER LINE EDGE OF PAVEMENT - ELEVATION -x - -x - -x - EXISTING FENCE EXISTING EX. - — — — EXISTING SITE FEATURES FEET FT. EXISTING POWER POLE W/ LIGHT Ø---\* HIGH POINT  $\bigcirc$ EXISTING STREET SIGNAL INVERT EXISTING ELECTRIC TRANFORMER LINEAL FEET N.T.S. - NOT TO SCALE EXISTING TELEPHONE PEDISTAL PORTLAND CEMENT EXISTING POWER POLE CONCRETE o WS EXISTING WATER SERVICE PROFILE GRADE LINE o GS EXISTING GAS SERVICE - PROPOSED PROP. EXISTING YARD LIGHT - SANITARY SEWER EXISTING STREET SIGN S.S. STORM SEWER EXISTING FIRE HYDRANT TOP OF CURB EXISTING WATER VALVE

TYPICAL

WATER MAIN

### BENCHMARKS

- #1 T-POST IN FIRST GRASS STRIP NORTH OF CREEK, NORTH LINE OF VILLAS, STA. 84+42.0, 139' RT., ELEVATION = 678.23
- #2 T-POST IN FIRST FENCE HUMP RUNNING WEST OF SECTION LINE NORTH OF VILLAS,  $\pm 300^{\circ}$  WEST, STA. 97+93.0, 279 LT., ELEVATION = 711.10
- #3 CAPPED IRON ROD WEST SIDE OF RTE. 91, STA. 142+42.0, 32' LT., ELEVATION = 735.67
- #4 CUT "SO" IN TOP OF WEST SIDE OF LIGHT POLE BASE ON POLE #5, EAST SIDE OF RTE. 91, STA. 139+72.0, 73' RT., ELEVATION = 736.92
- #5 CUT "SO" IN TOP OF SOUTH SIDE OF LIGHT POLE BASE ON POLE #3, NORTH SIDE OF RTE. 91, STA. 303+37.0, 8' RT., ELEVATION = 734.34

# TRAFFIC CONTROL PLAN

⟨<a>⟩</a>

FLASHING LIGHTS SHALL BE USED IN ADVANCE OF THE WORK AREA DURING HOURS OF DARKNESS AND PLACED ON EACH PERMANENT SIGN.

EXISTING TREES & SHRUBS

PROPOSED WATER MAIN

PROPOSED WATER VALVE

IDENTIFICATION NUMBER

PROPOSED WATER STRUCTURE


PROPOSED HYDRANT

EXISTING TREE LINE

THE CONTRACTOR WILL ACCESS THE PROJECT VIA ORANGE PRAIRIE ROAD, AND GRANGE HALL RD., ONLY WITH ACCESS ON TO ALTERNATE ROADWAYS NOT PERMITTED. CITY CORPORATE LIMITS WILL BE DISCUSSED DURING THE PRE-CONSTRUCTION MEETING AS WELL AS CONSTRUCTION LIMITS.

TRAFFIC CONTROL USED SHALL BE IN ACCORDANCE WITH THE APPLICABLE SECTIONS OF THE "STANDARD SPECIFICATIONS FOR ROAD AND BRIDGE CONSTRUCTION" OR THE APPLICABLE GUIDELINES CONTAINED IN THE "ILLINOIS MANUAL ON UNIFORM TRAFFIC CONTROL DEVICES FOR STREETS AND HIGHWAYS", CURRENT EDITIONS. ALL TRAFFIC CONTROL USED SHALL BE MAINTAINED THROUGHOUT THE DURATION OF THE PROJECT. IF TRAFFIC CONTROL IS NOT MAINTAINED TO THE SATISFACTION OF THE ENGINEER WHEN REQUIRED, CONSTRUCTION SHALL BE STOPPED UNTIL TRAFFIC CONTROL IS RESET TO THE SATISFACTION OF THE ENGINEER.

# B & C ORANGE PRAIRIE ROAD

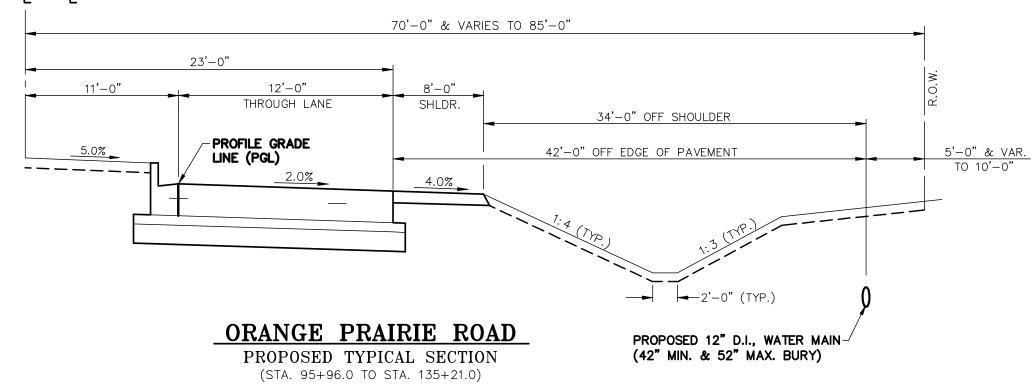



# B & C ORANGE PRAIRIE ROAD 23'-0" & VARIES TO 44'-7" 12'-0" & VAR. AT INTERSECTION THROUGH LANE 12'-0" AUXILIARY 34'-0" OFF SHOULDER LANE SHLDR. TURN LANE PROFILE GRADE LINE (PGL) 42'-0" OFF EDGE OF PAVEMENT ORANGE PRAIRIE ROAD PROPOSED 12" D.I., WATER MAIN-(42" MIN. & 52" MAX. BURY) PROPOSED TYPICAL SECTION


(STA. 135+21.0 TO STA. 137+23.0)


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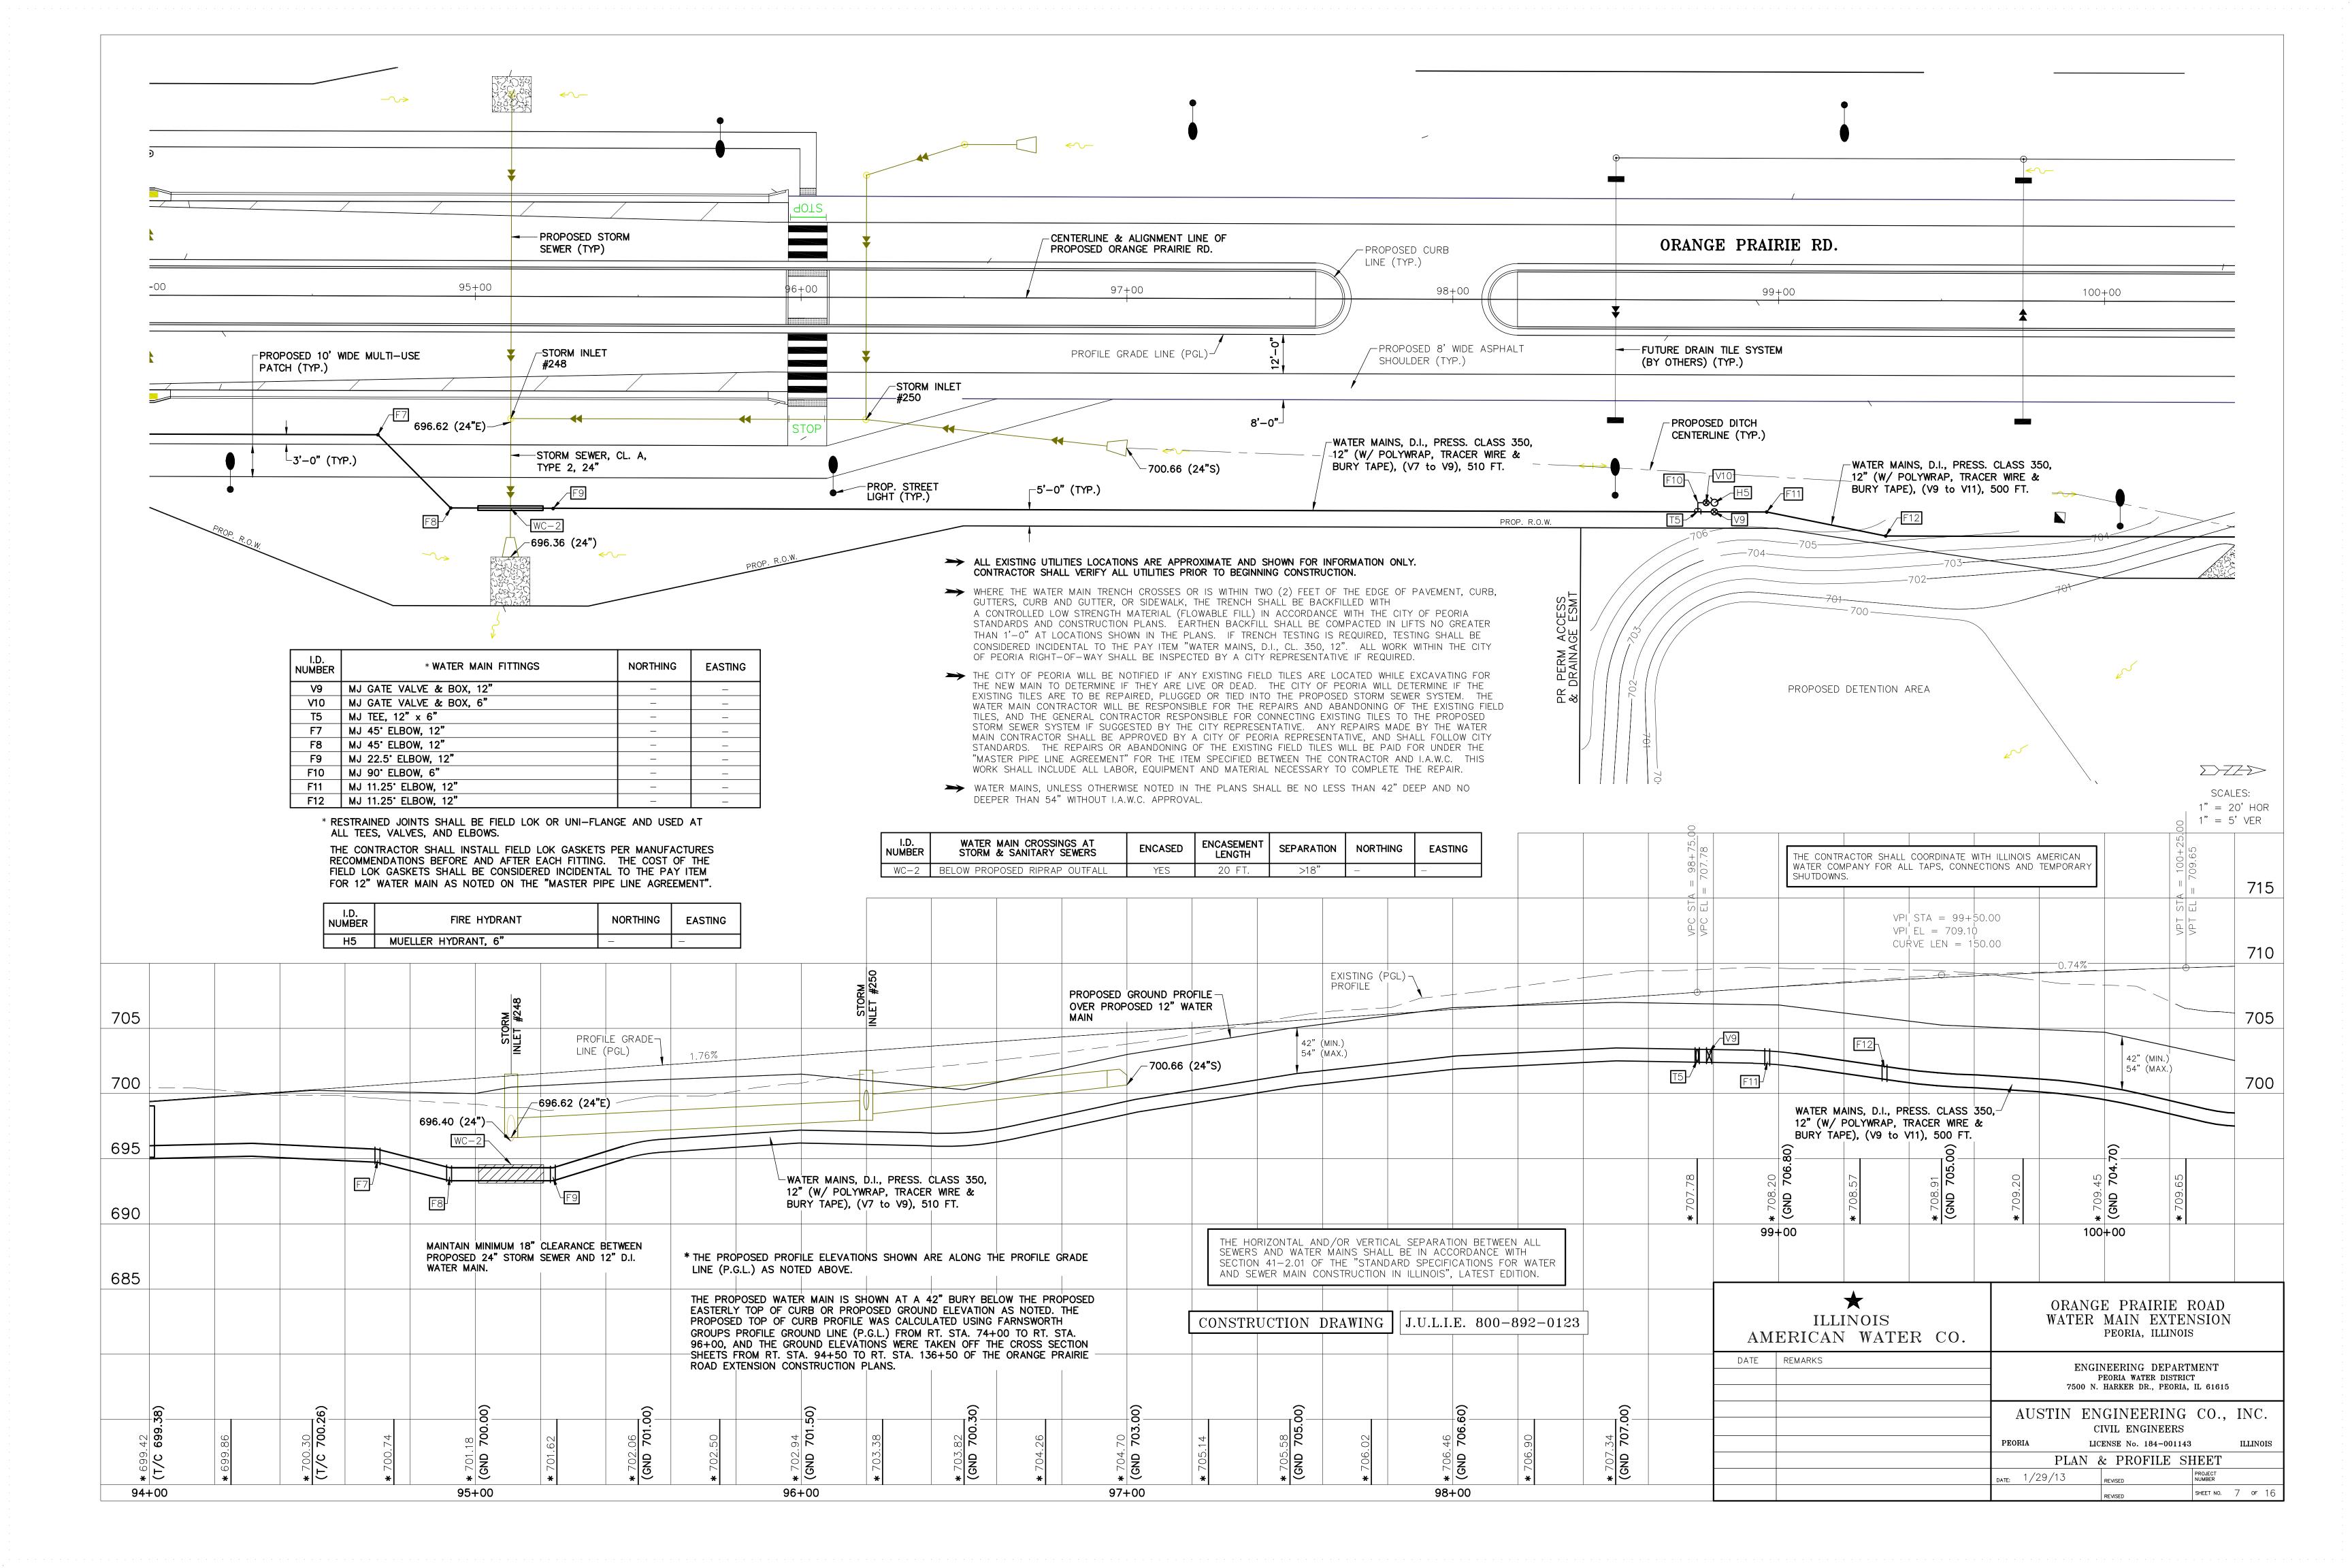
★ ILLINOIS AMERICAN WATER CO.			GE PRAIRIE TER MAIN EXTENS PEORIA, ILLINOIS	SION	
DATE	REMARKS	ENGINEERING DEPARTMENT PEORIA WATER DISTRICT 7500 N. HARKER DR., PEORIA, IL. 61615			
			NGINEERING CIVIL ENGINEERS ICENSE No. 184–00114		
		LEGENI	& CONTROL	SHEET	
		DATE: 1/29/13	REVISED	PROJECT NUMBER	
		SCALE:	REVISED	SHEET NO. 2 OF 16	




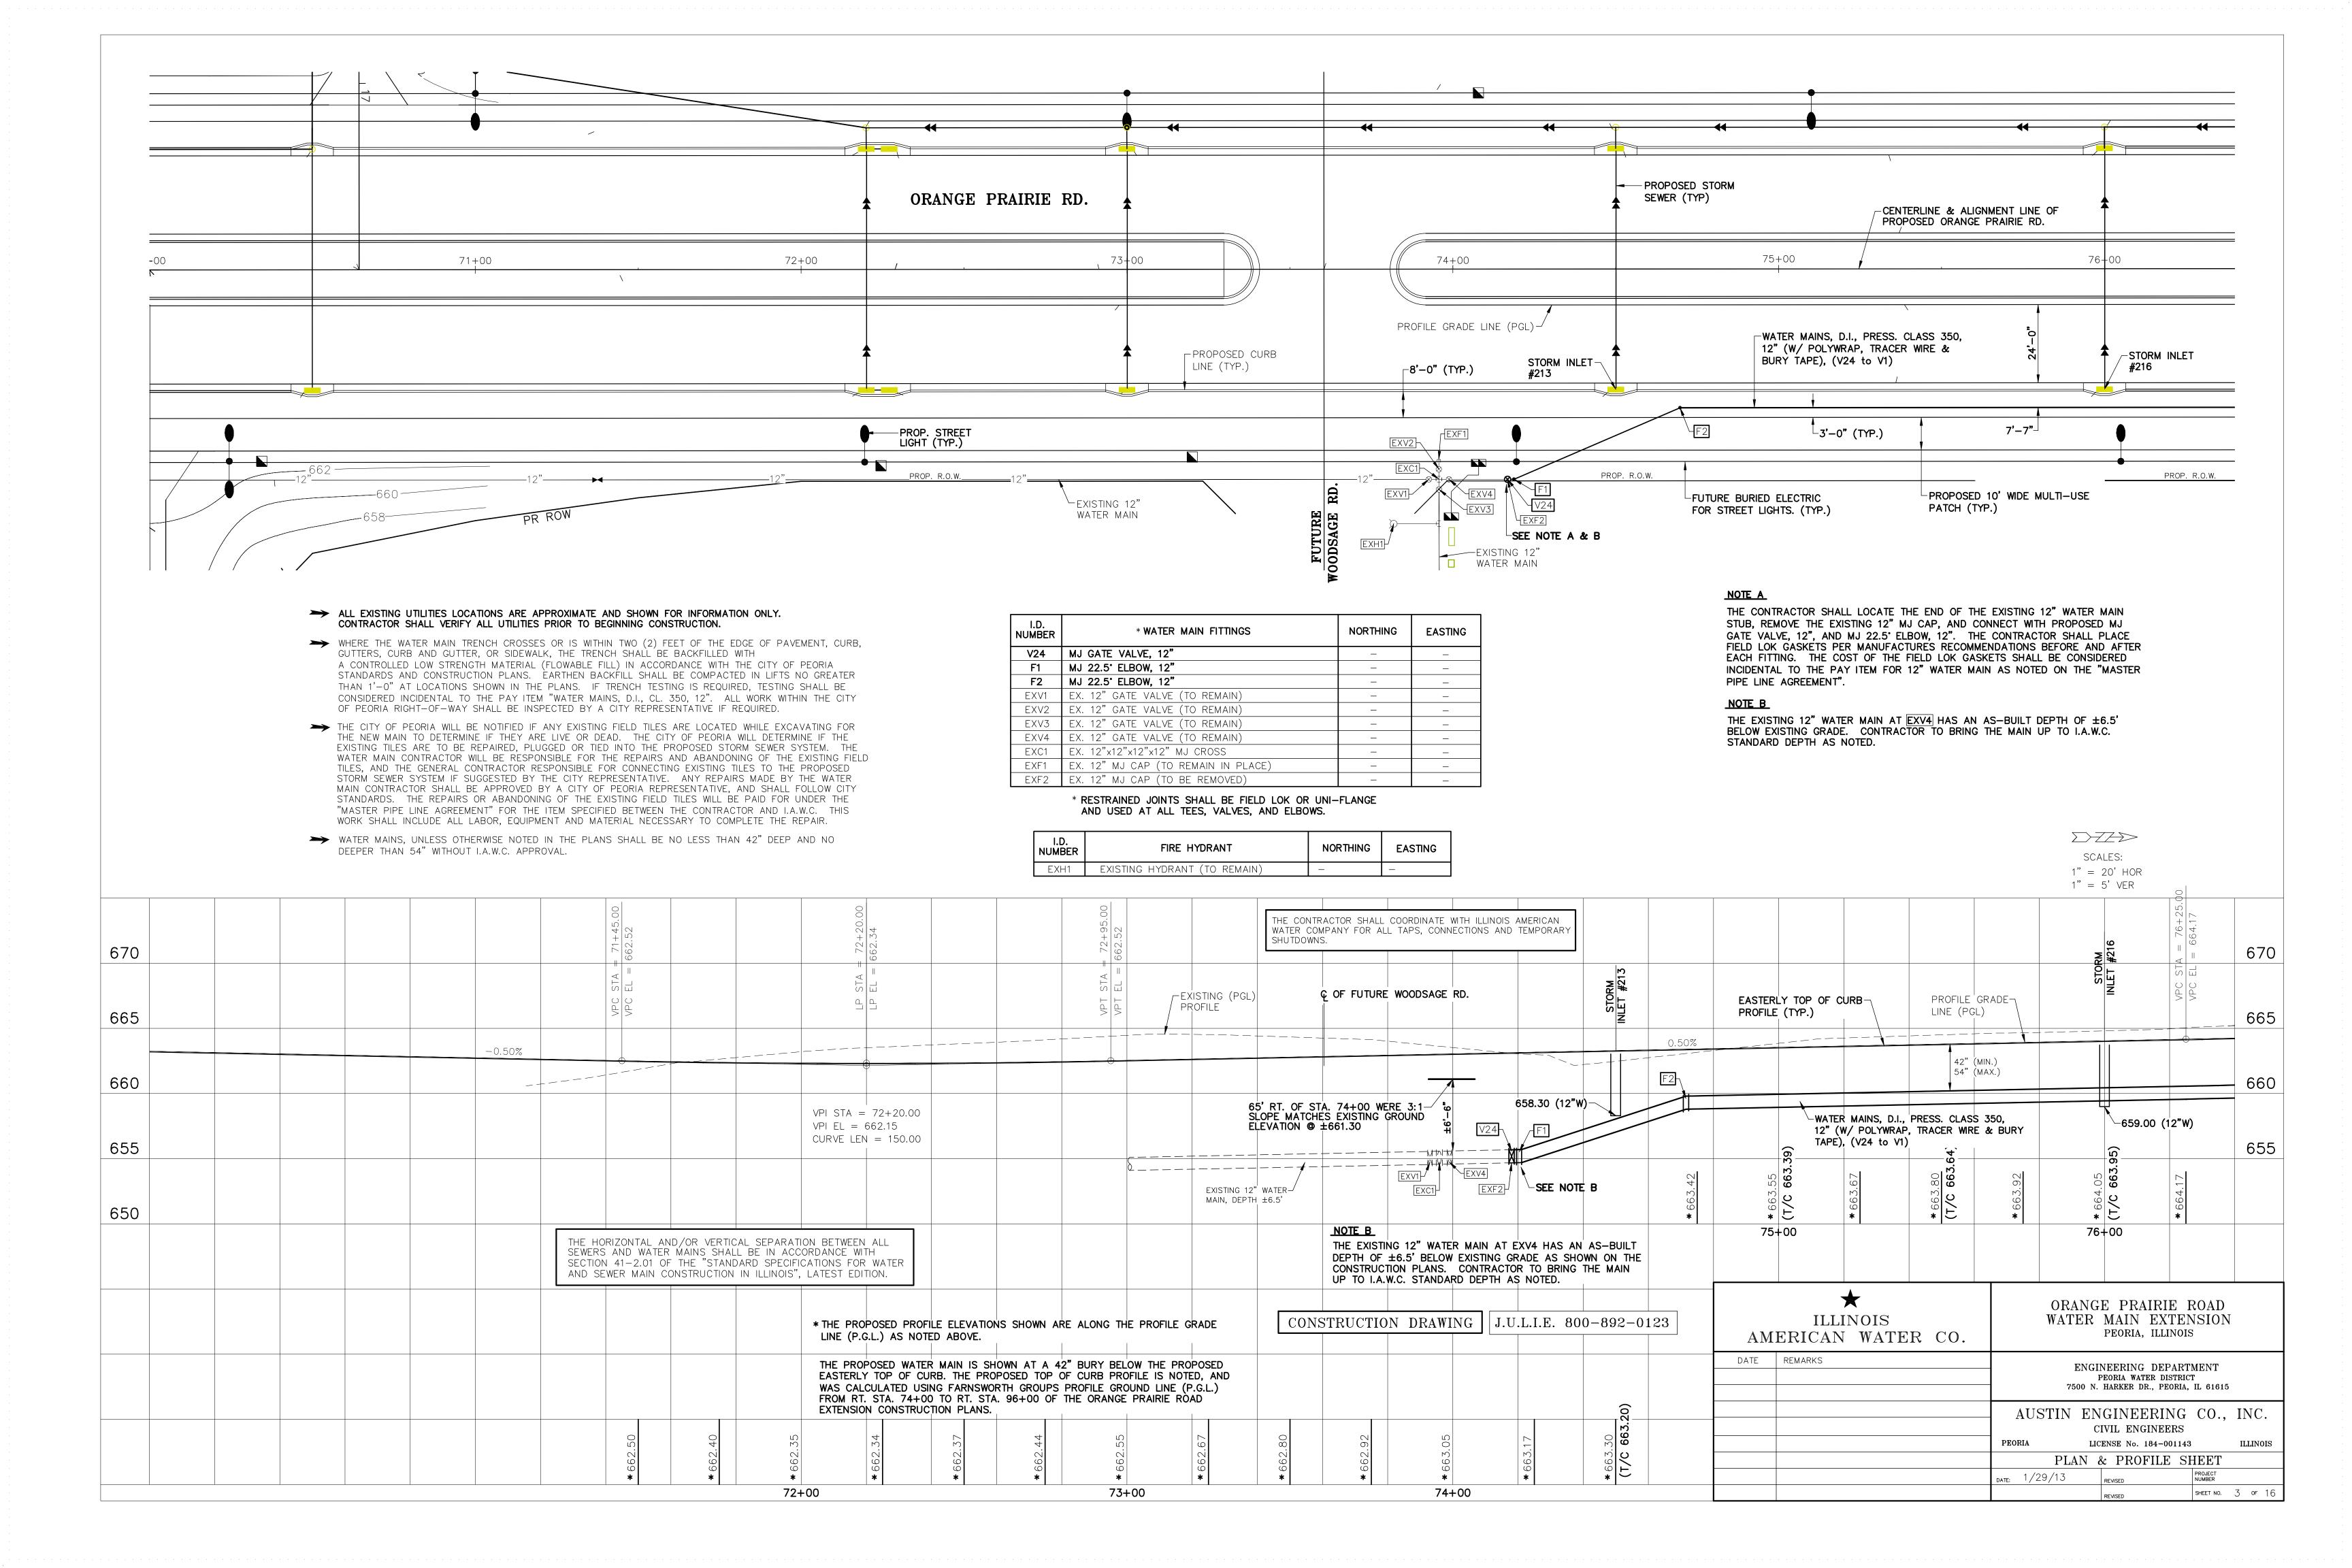


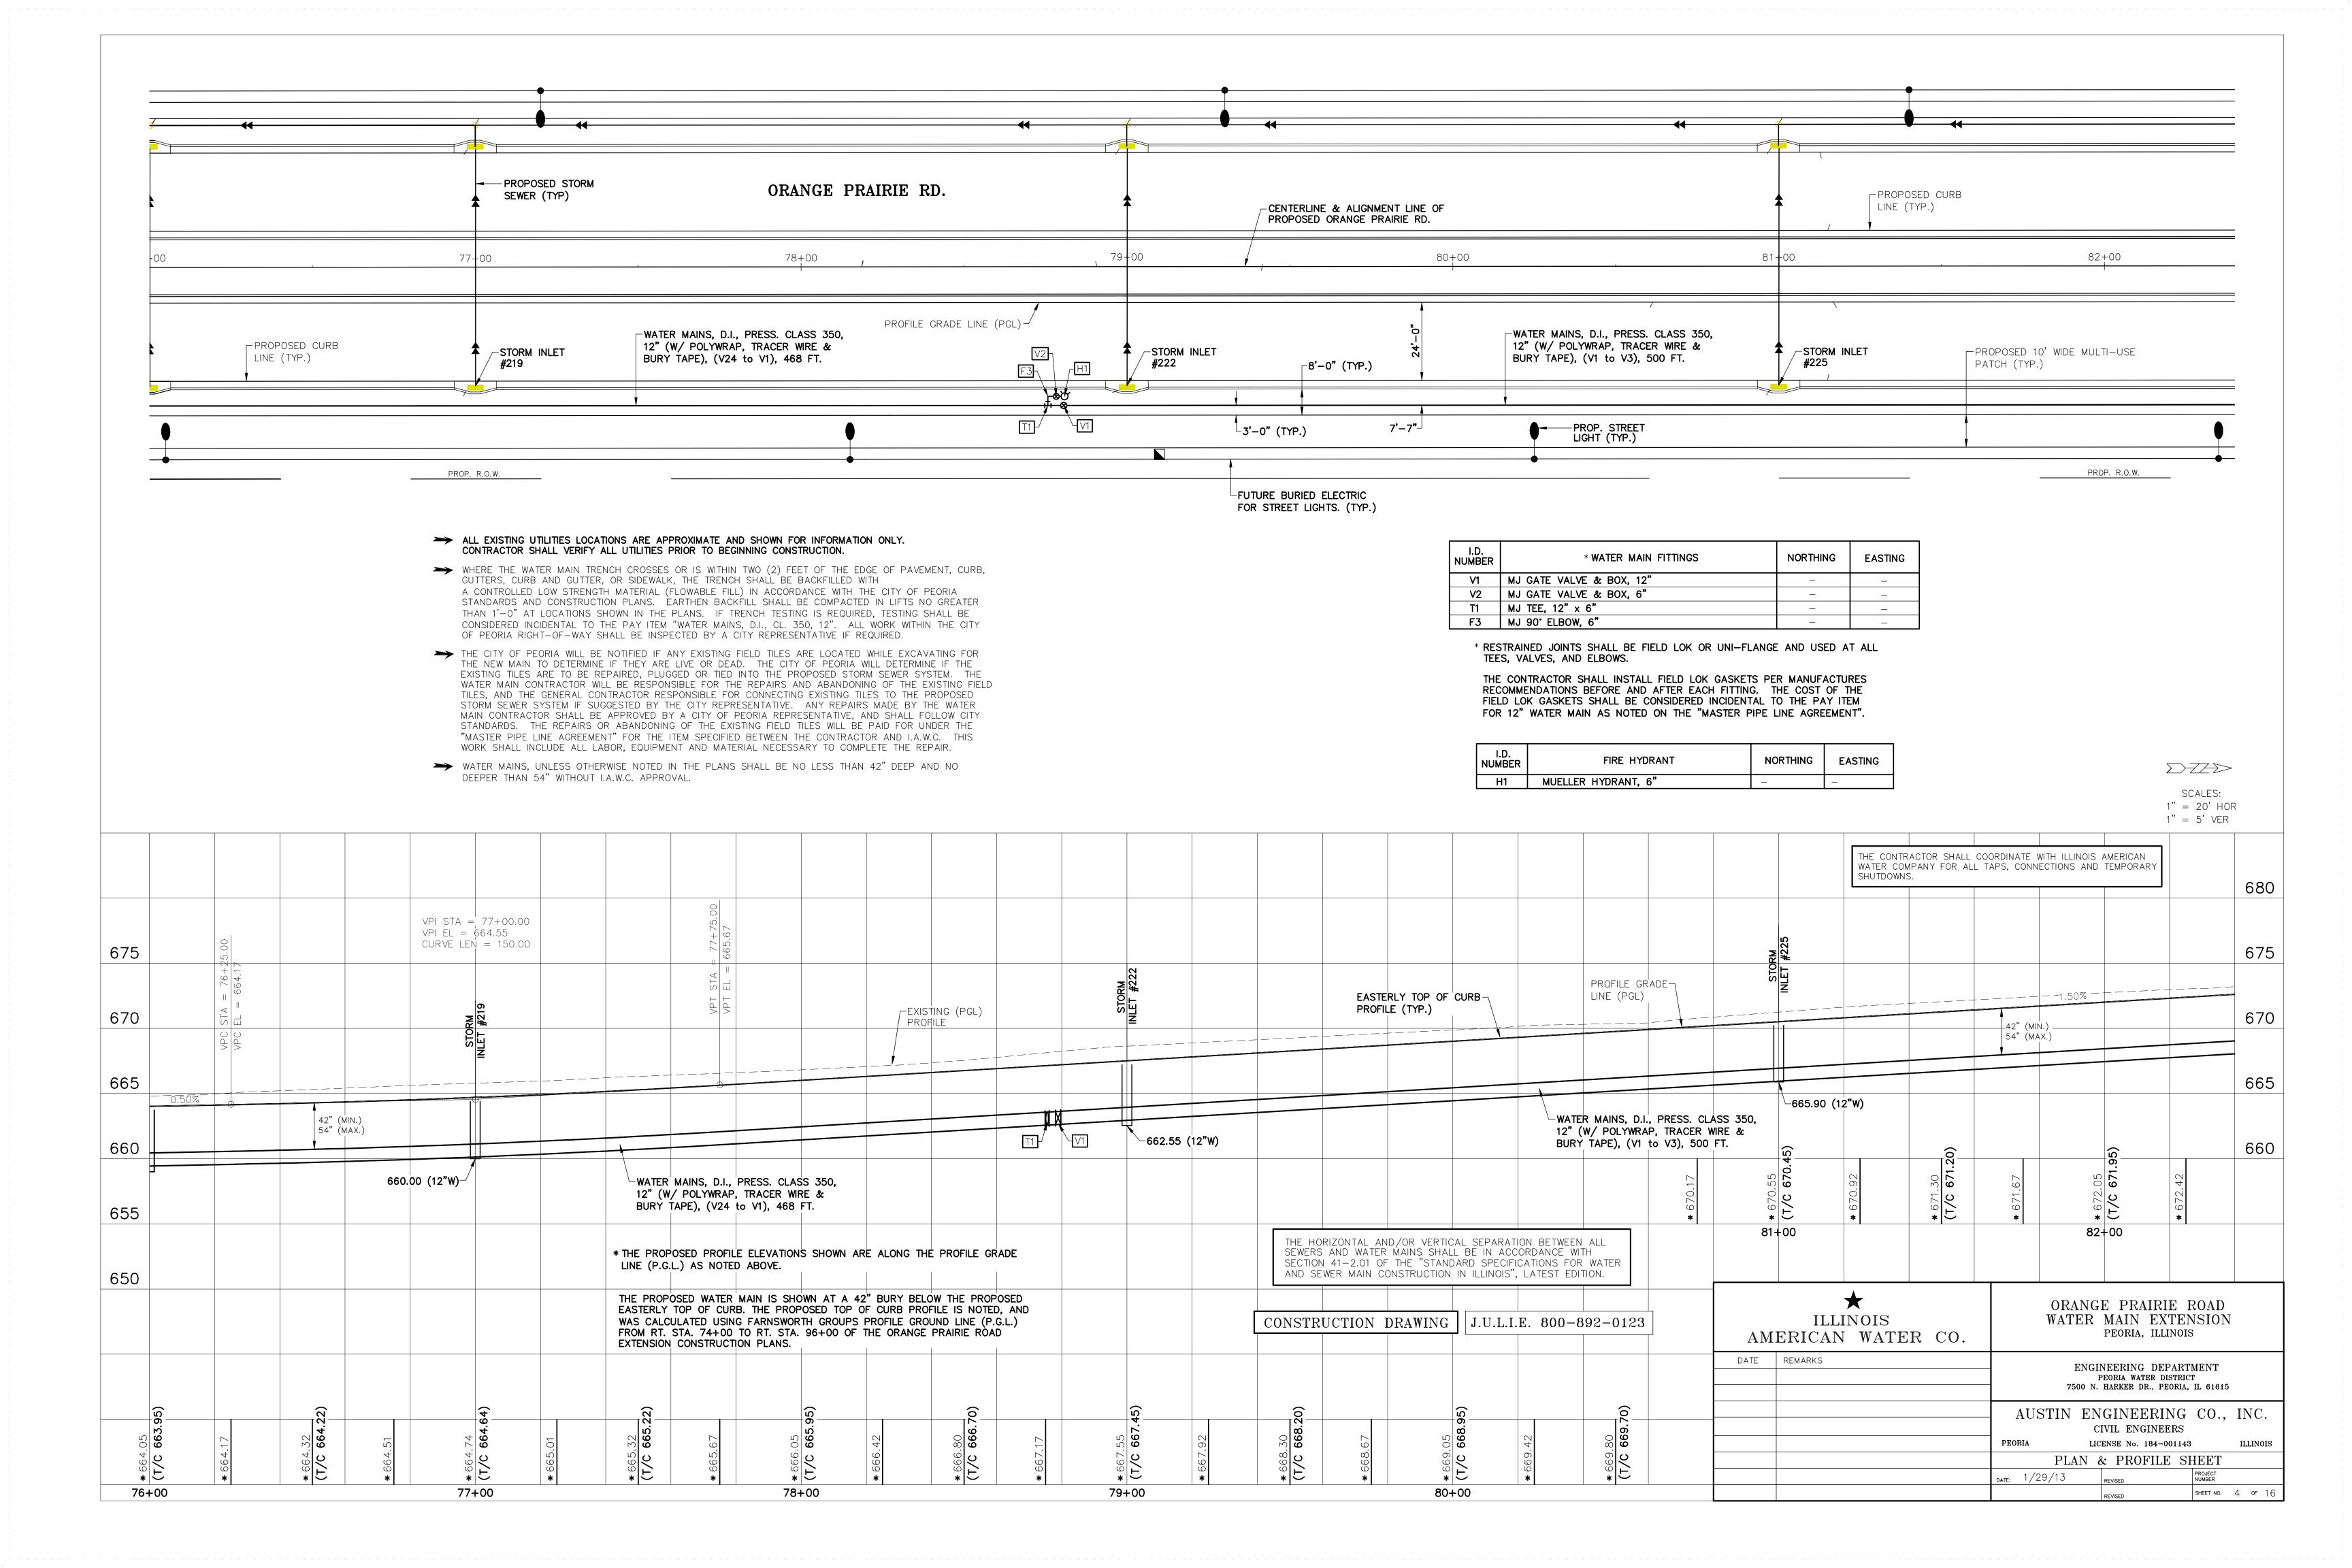


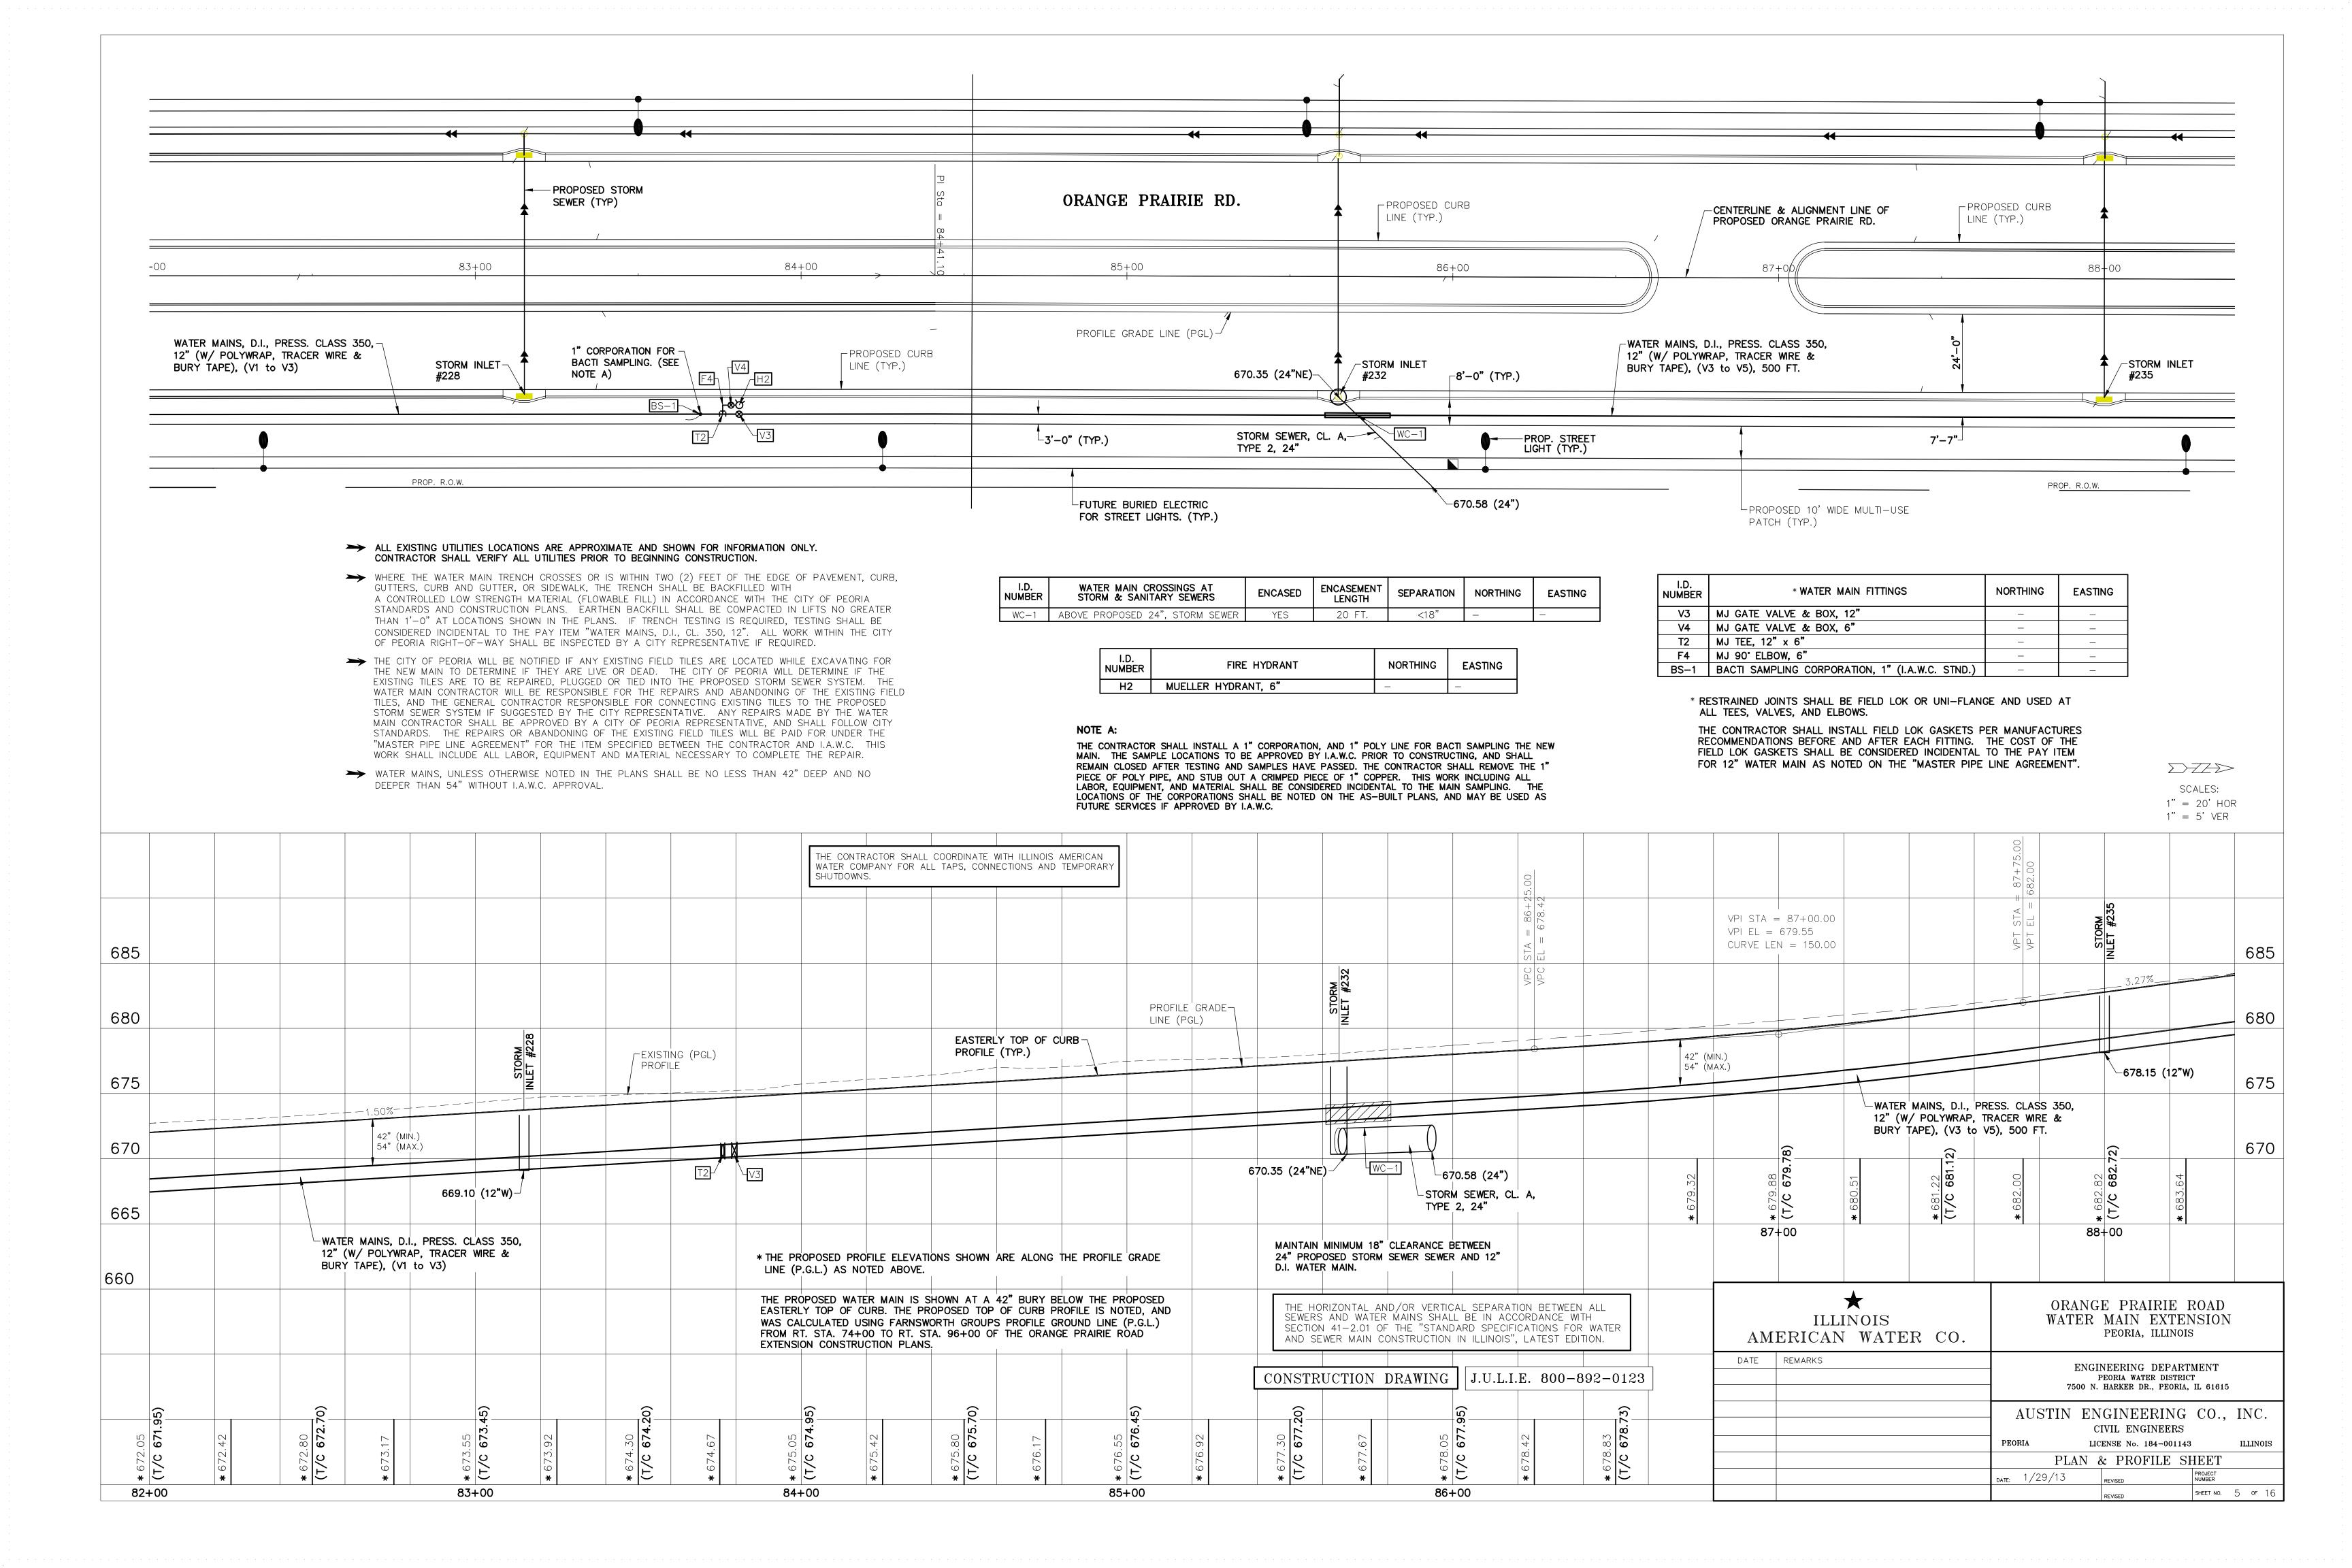


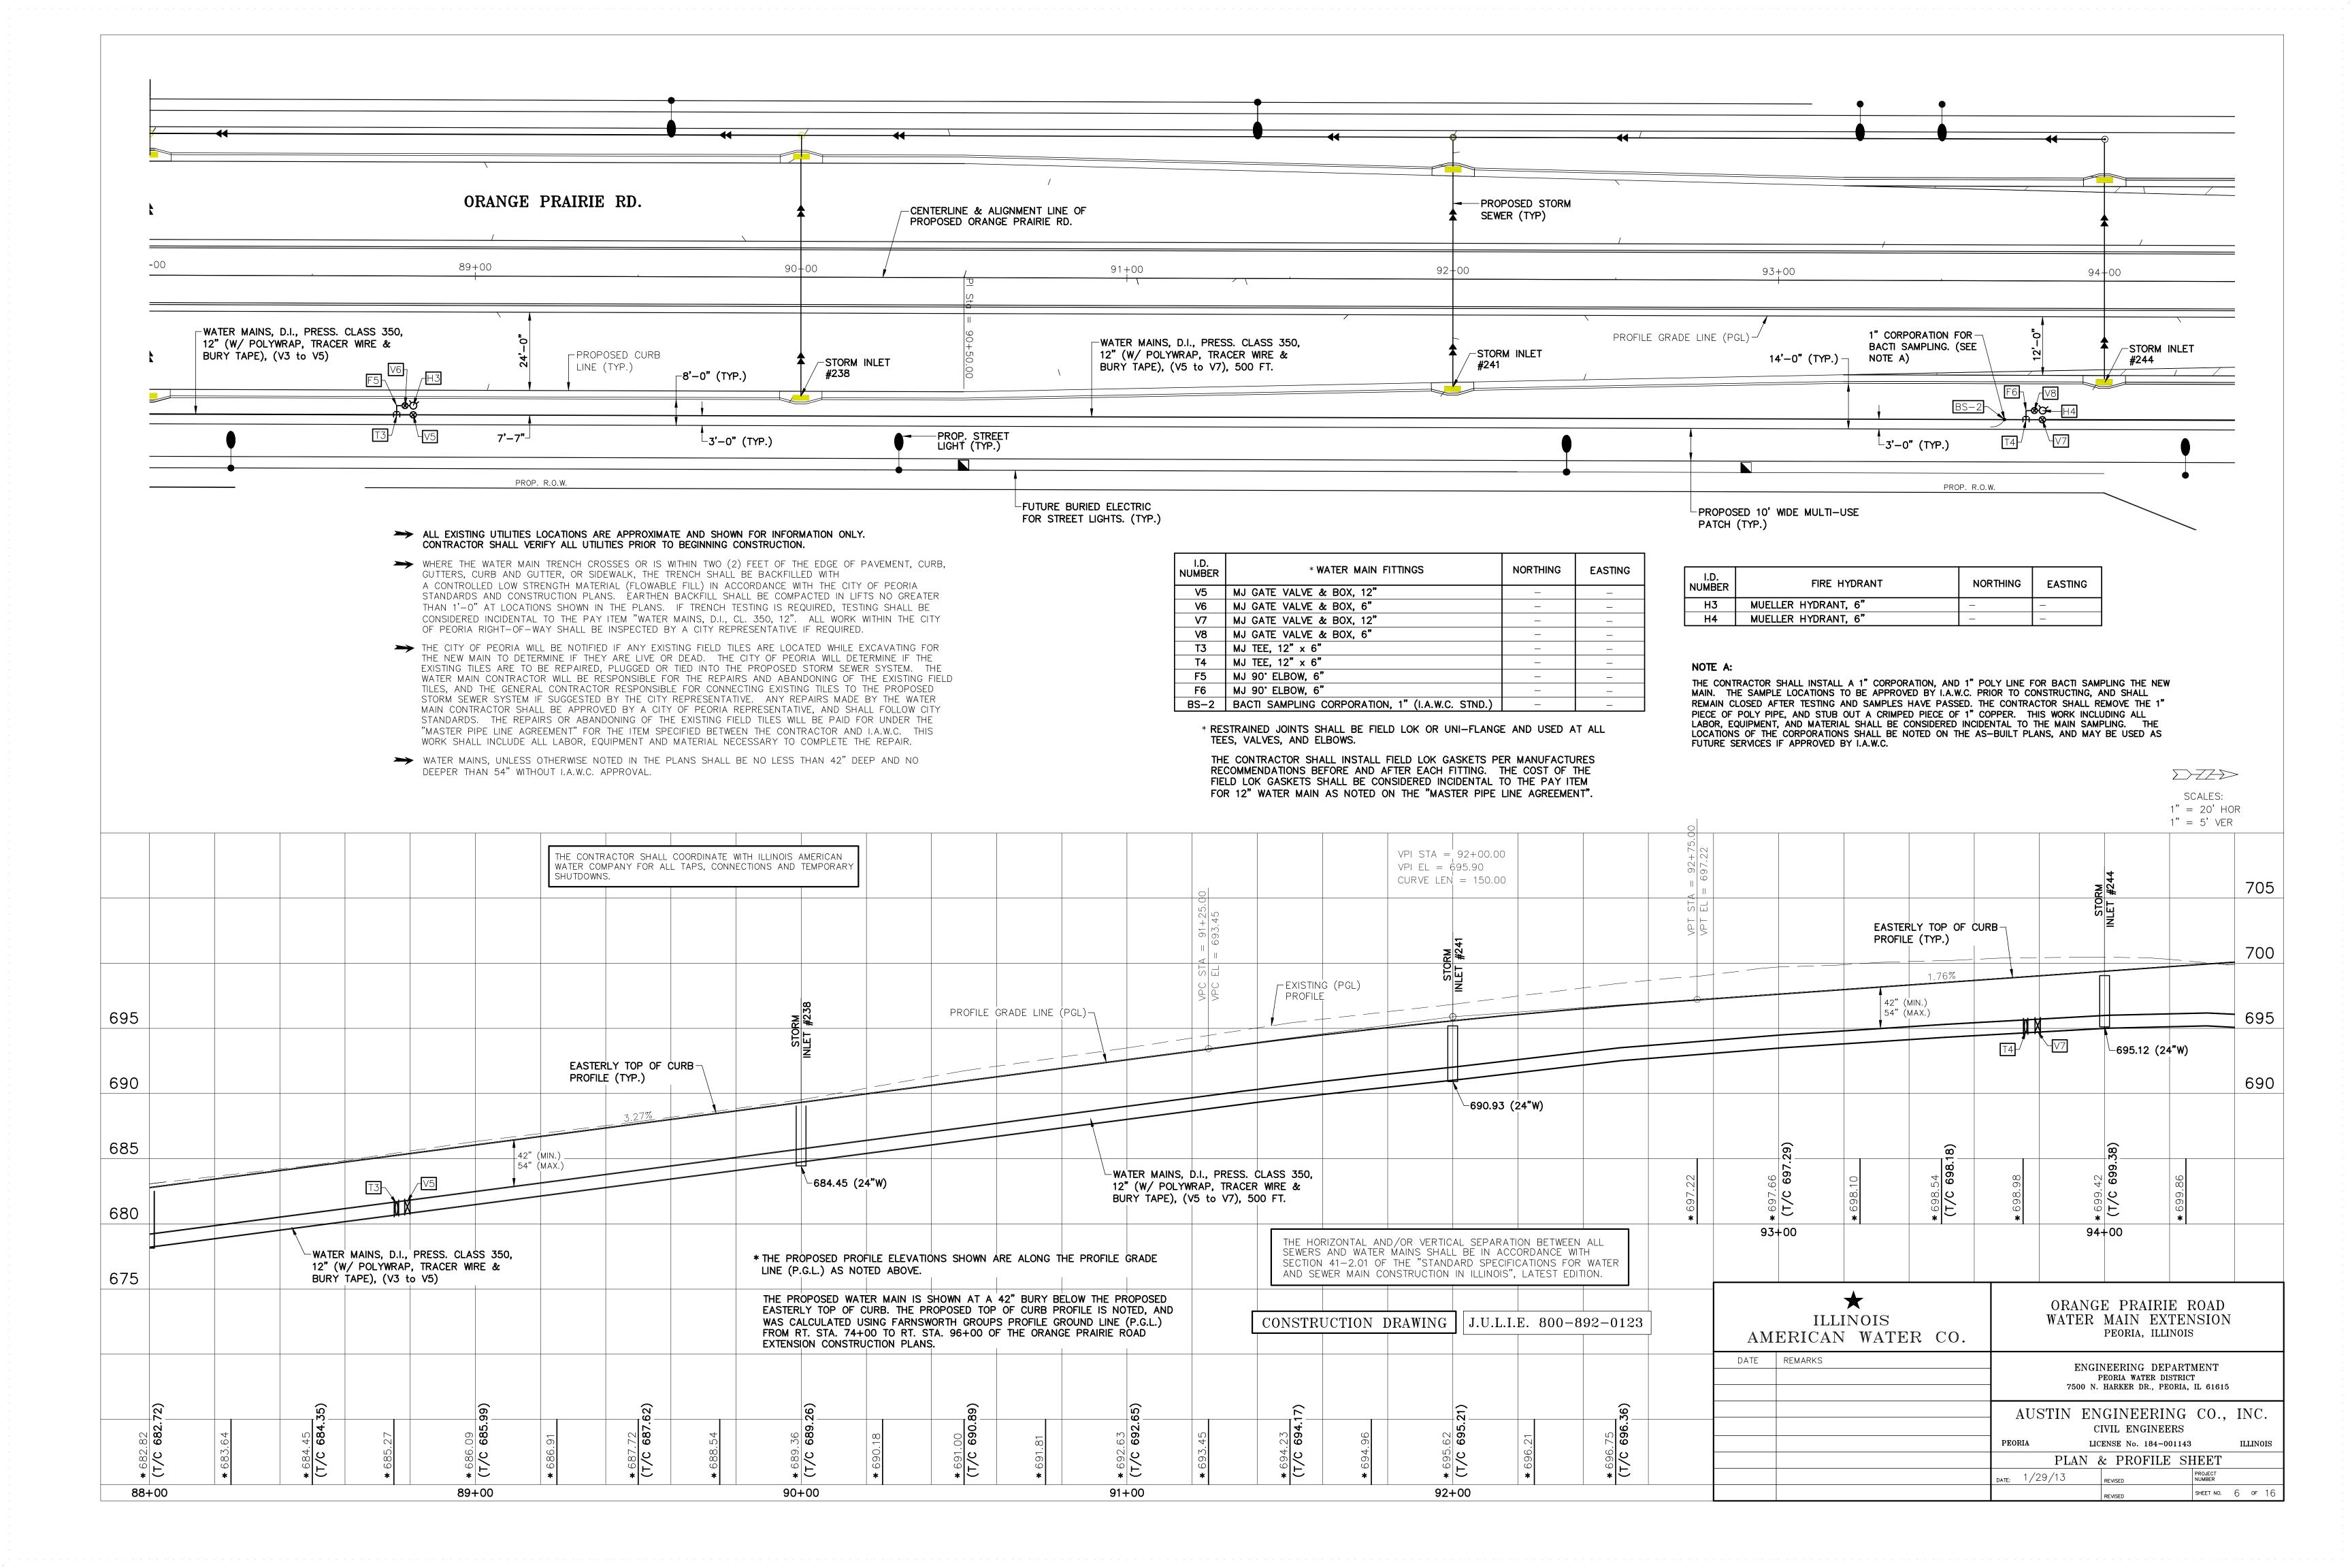


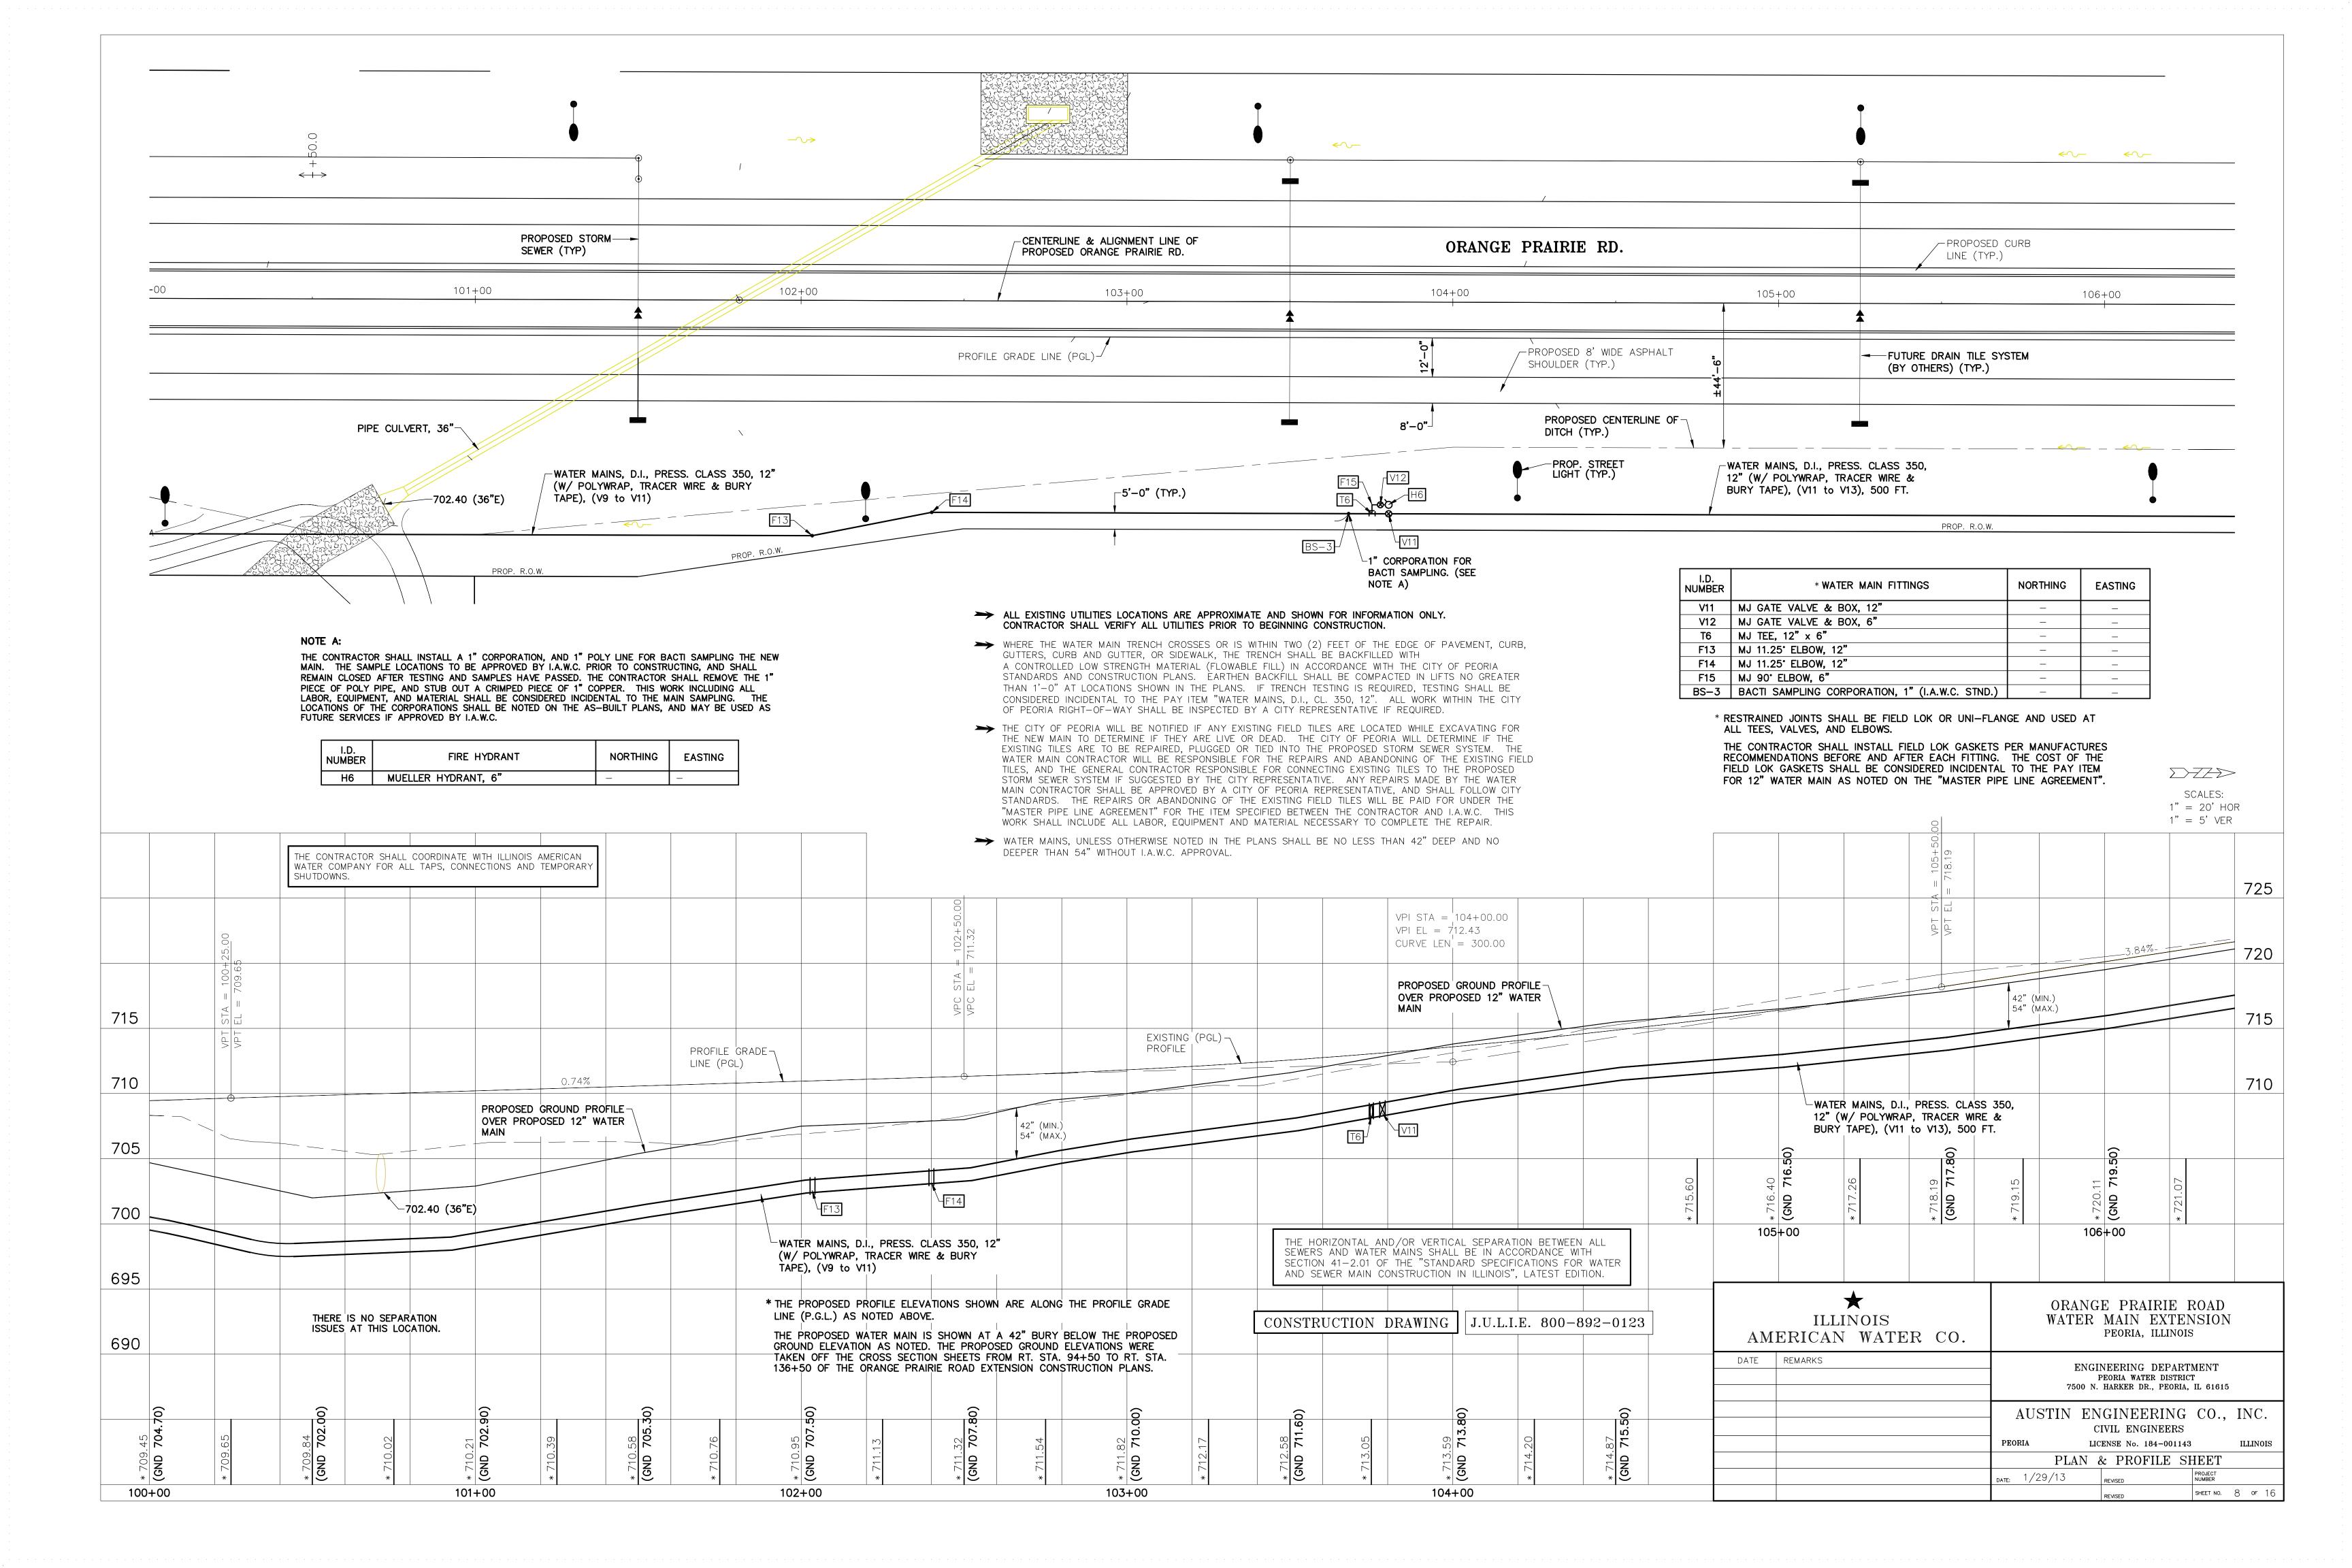


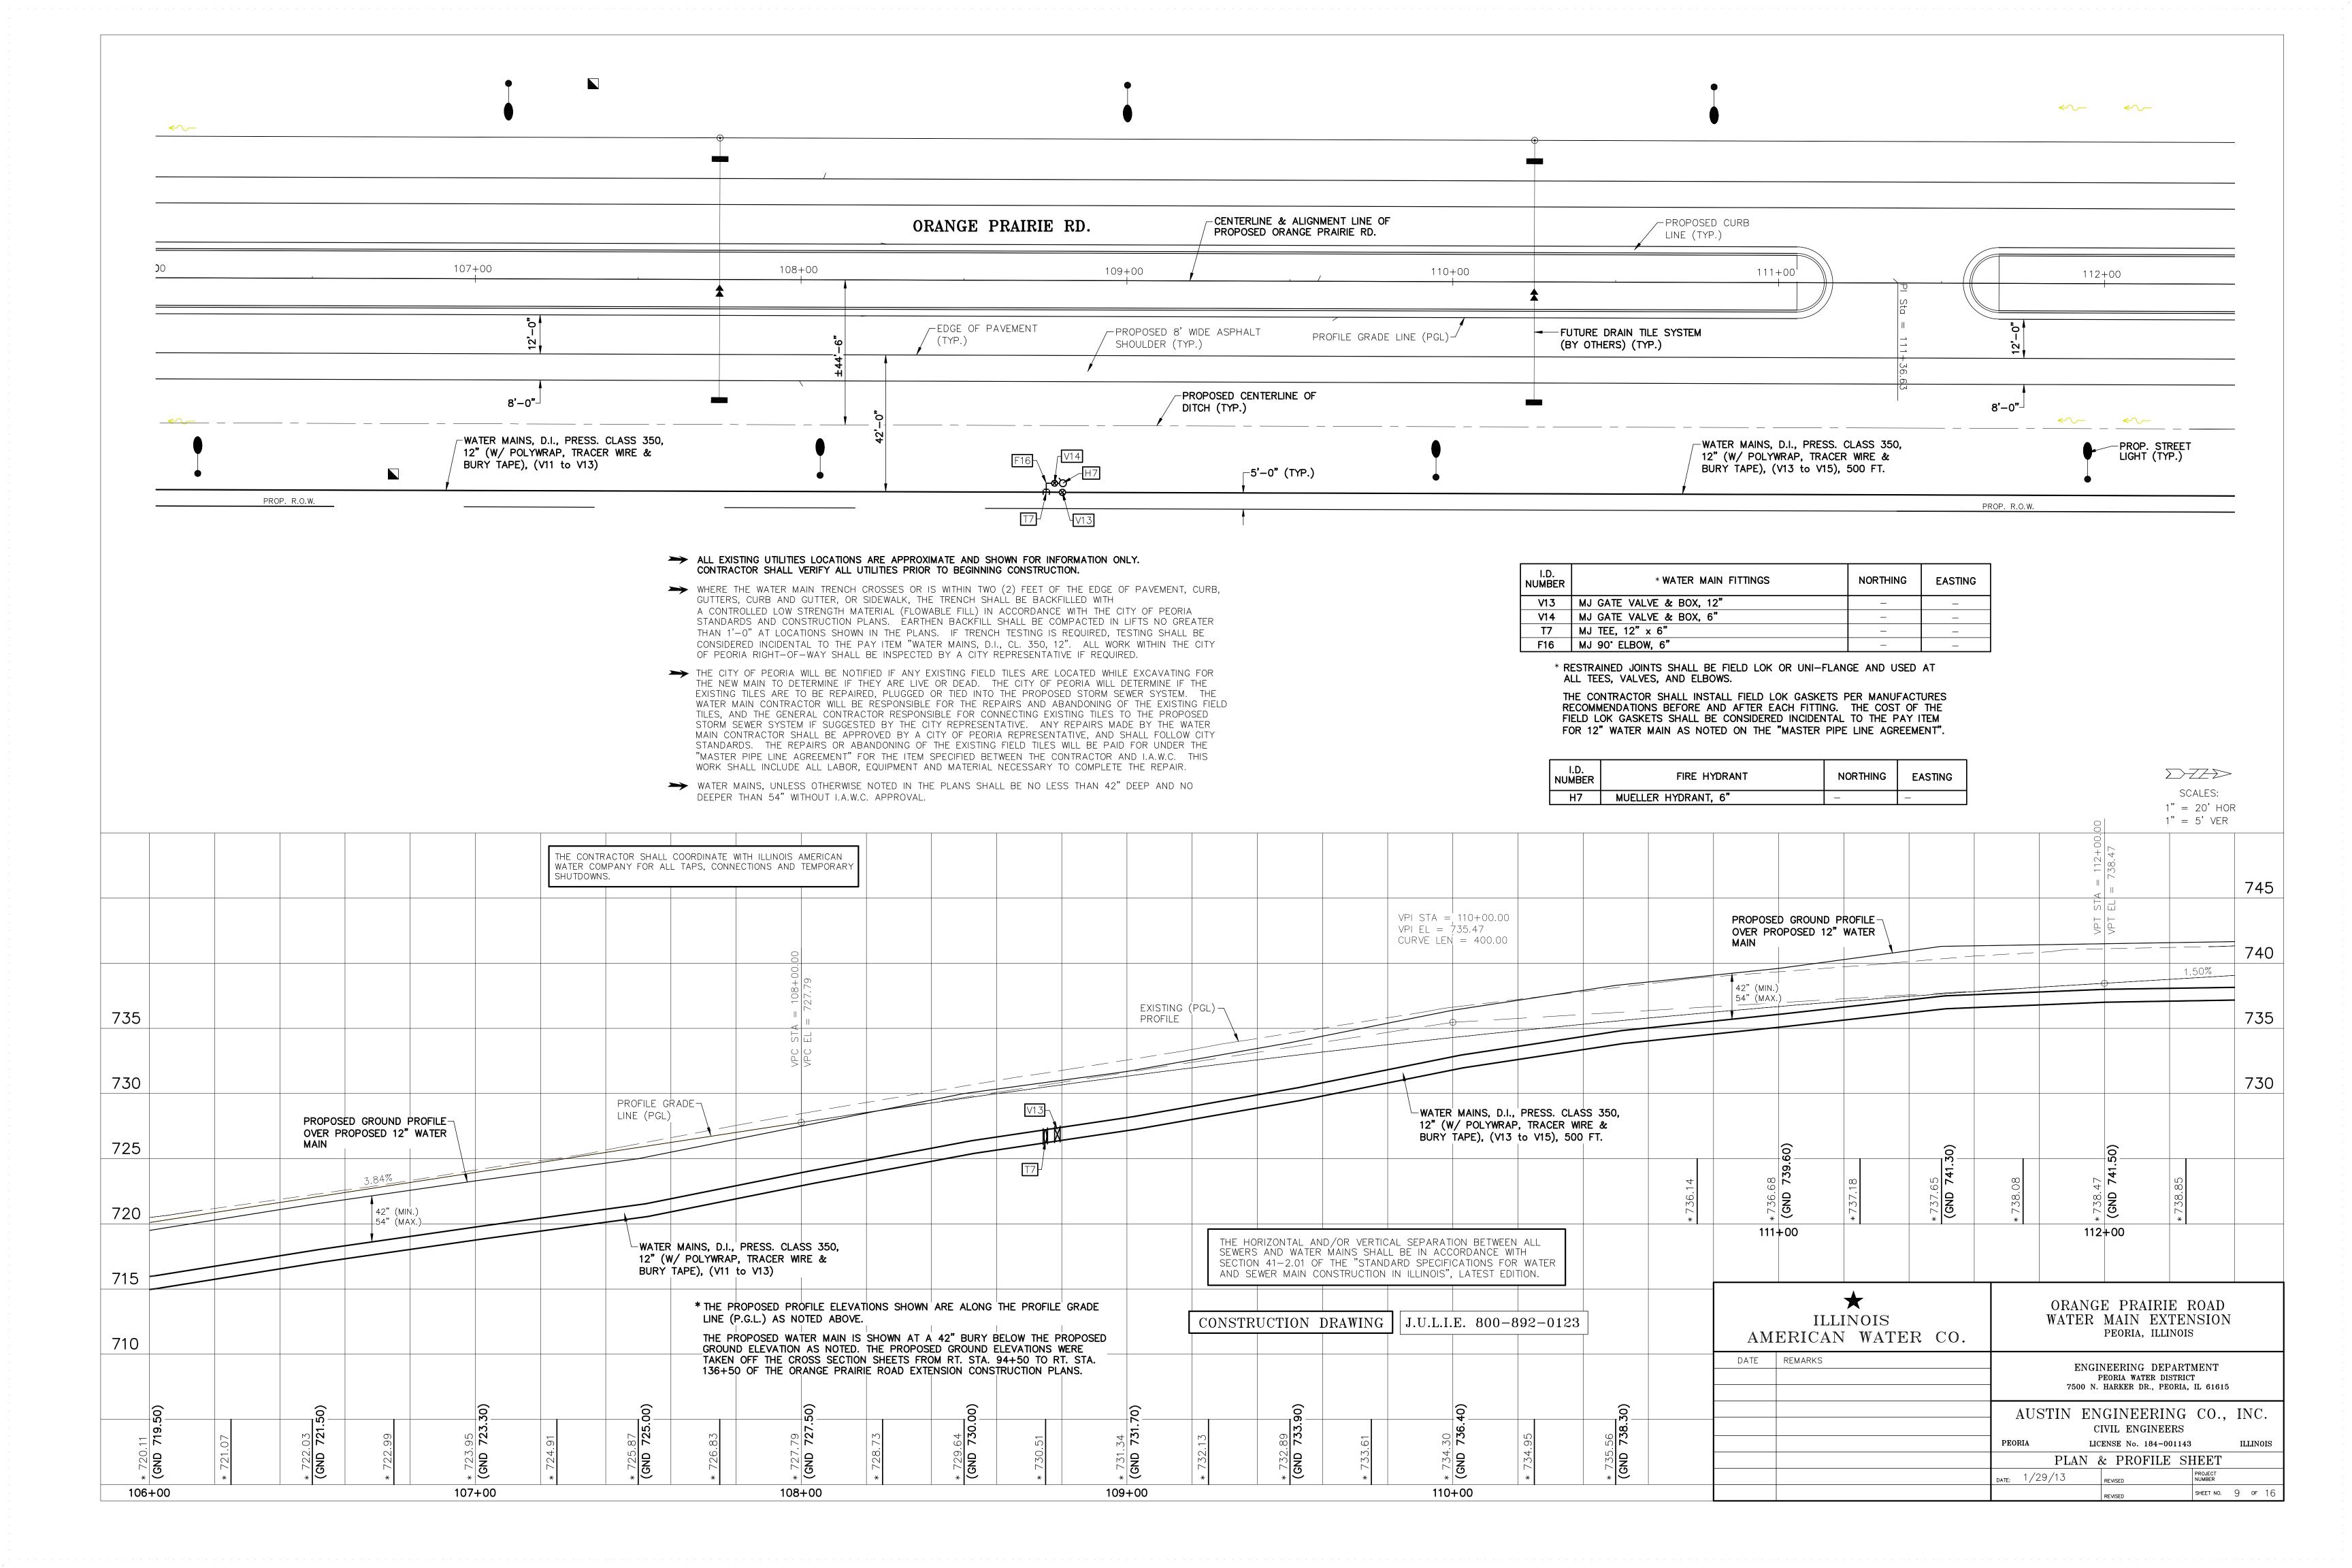


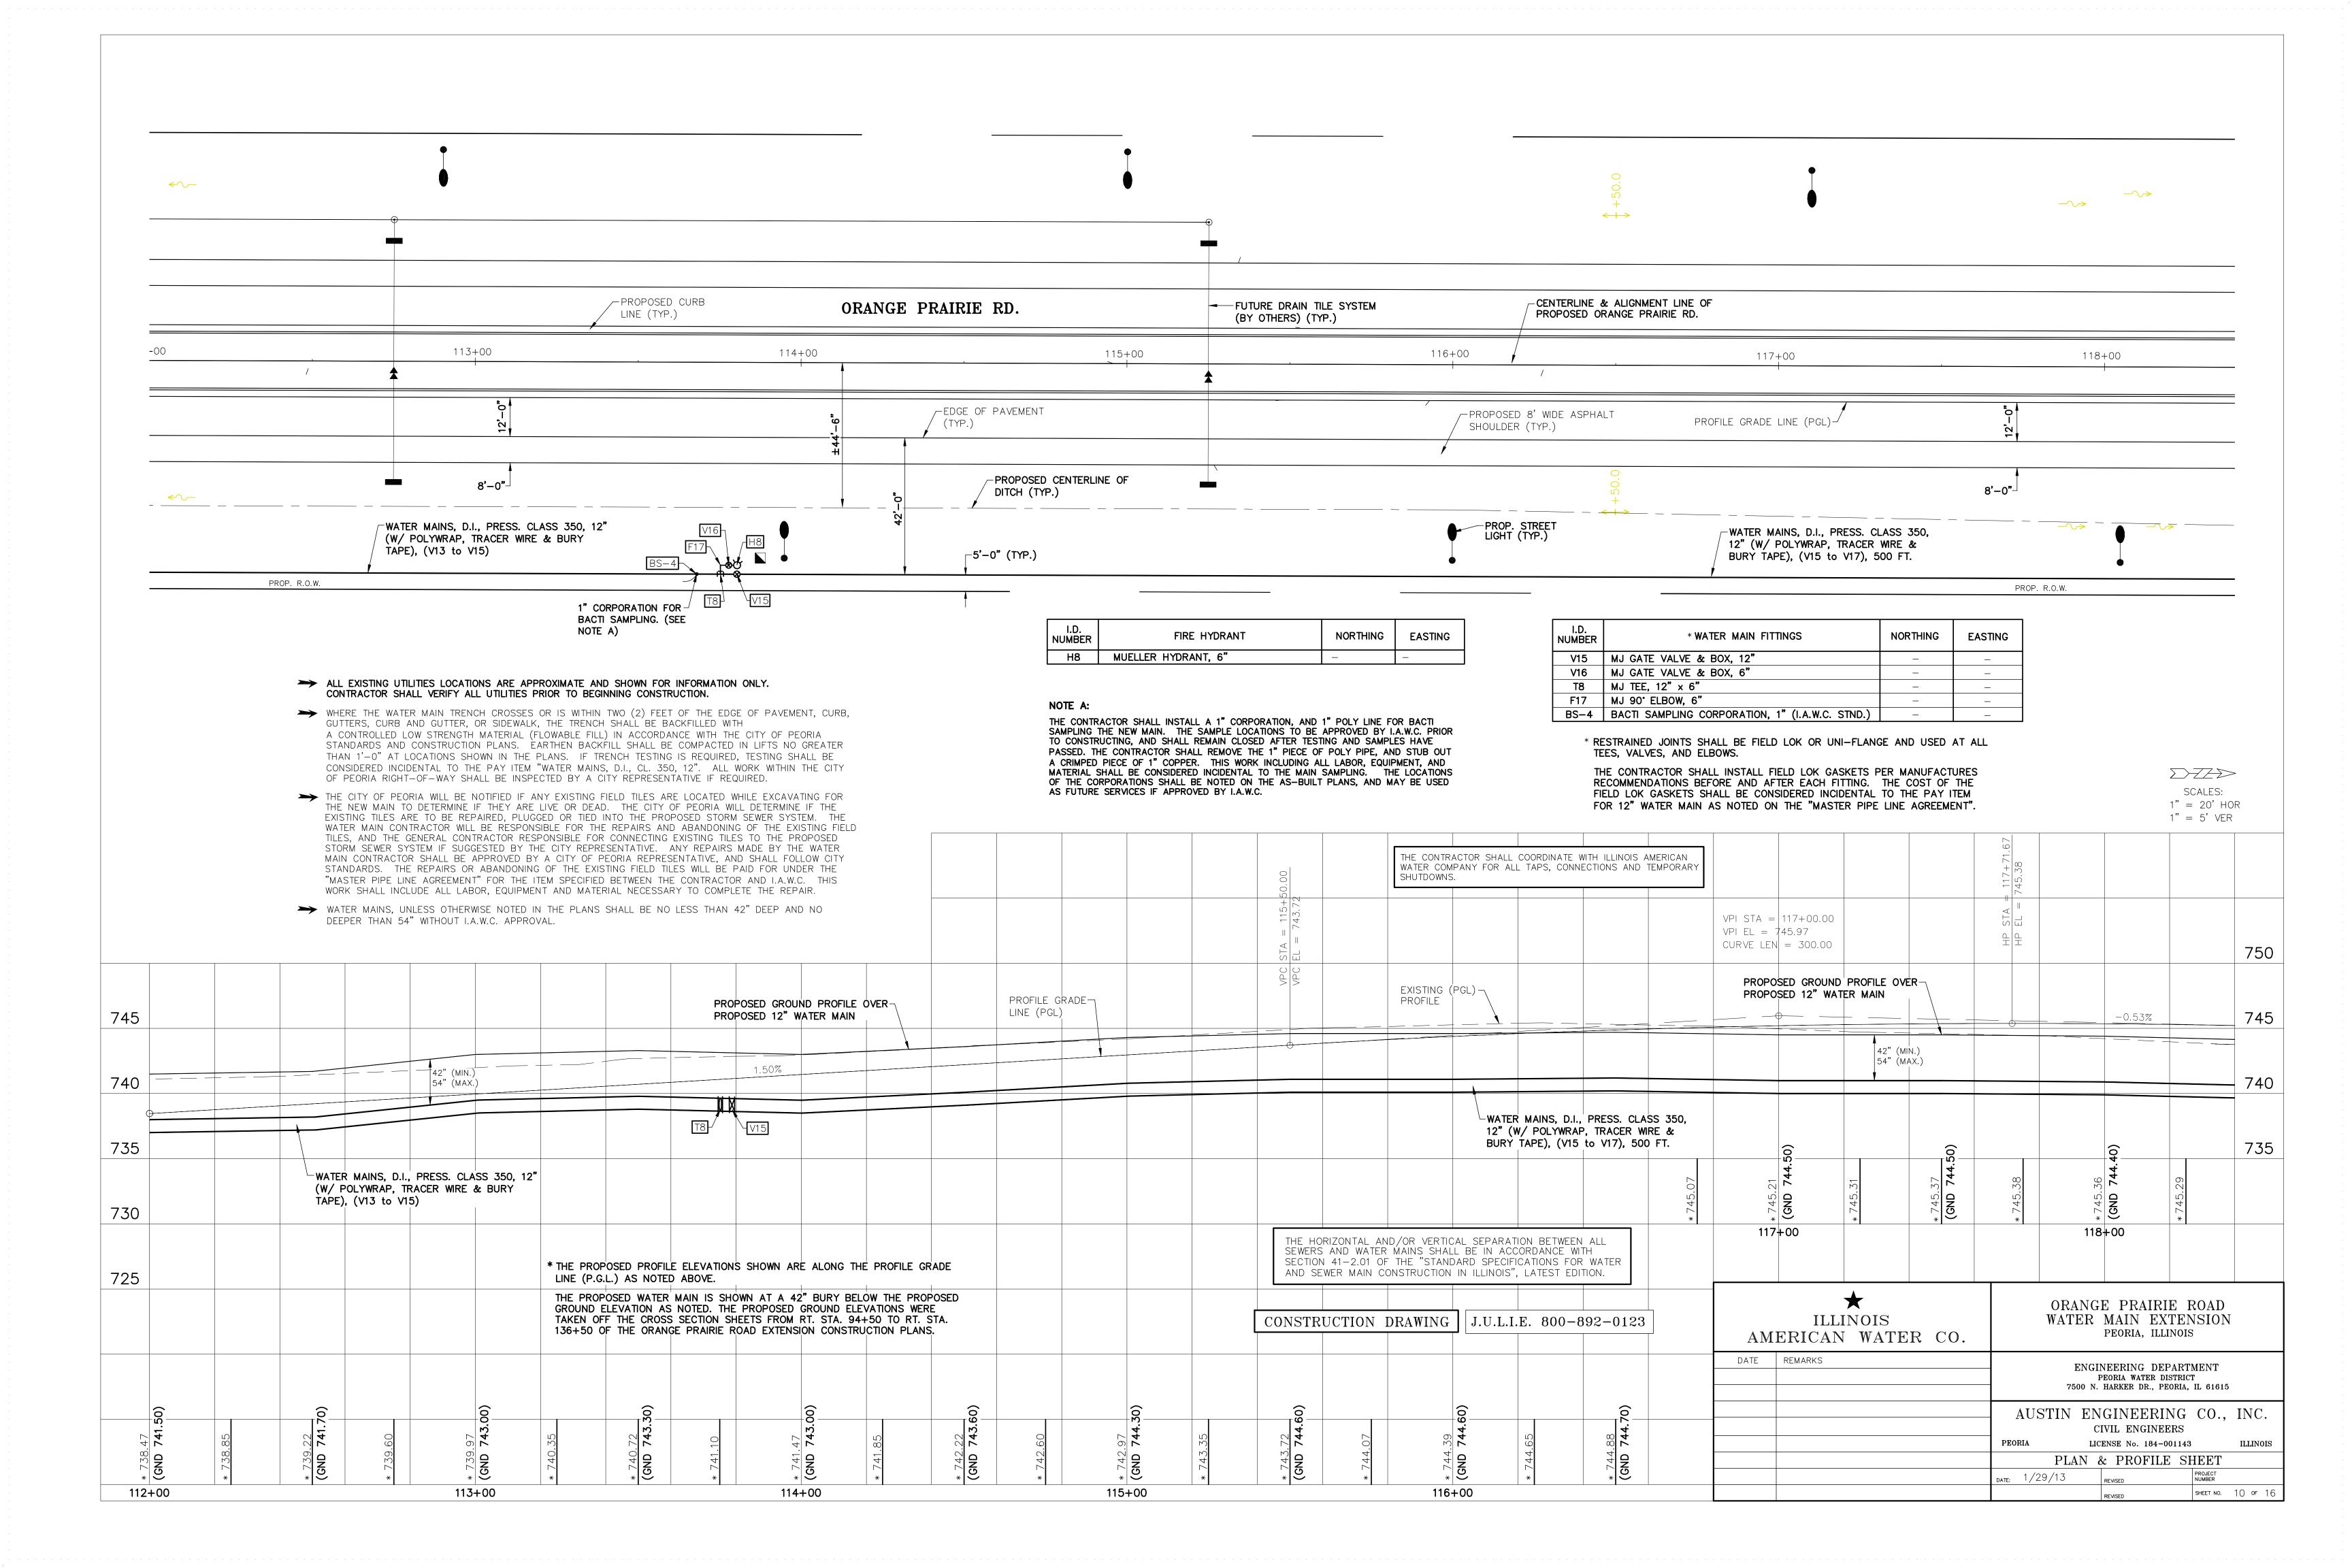

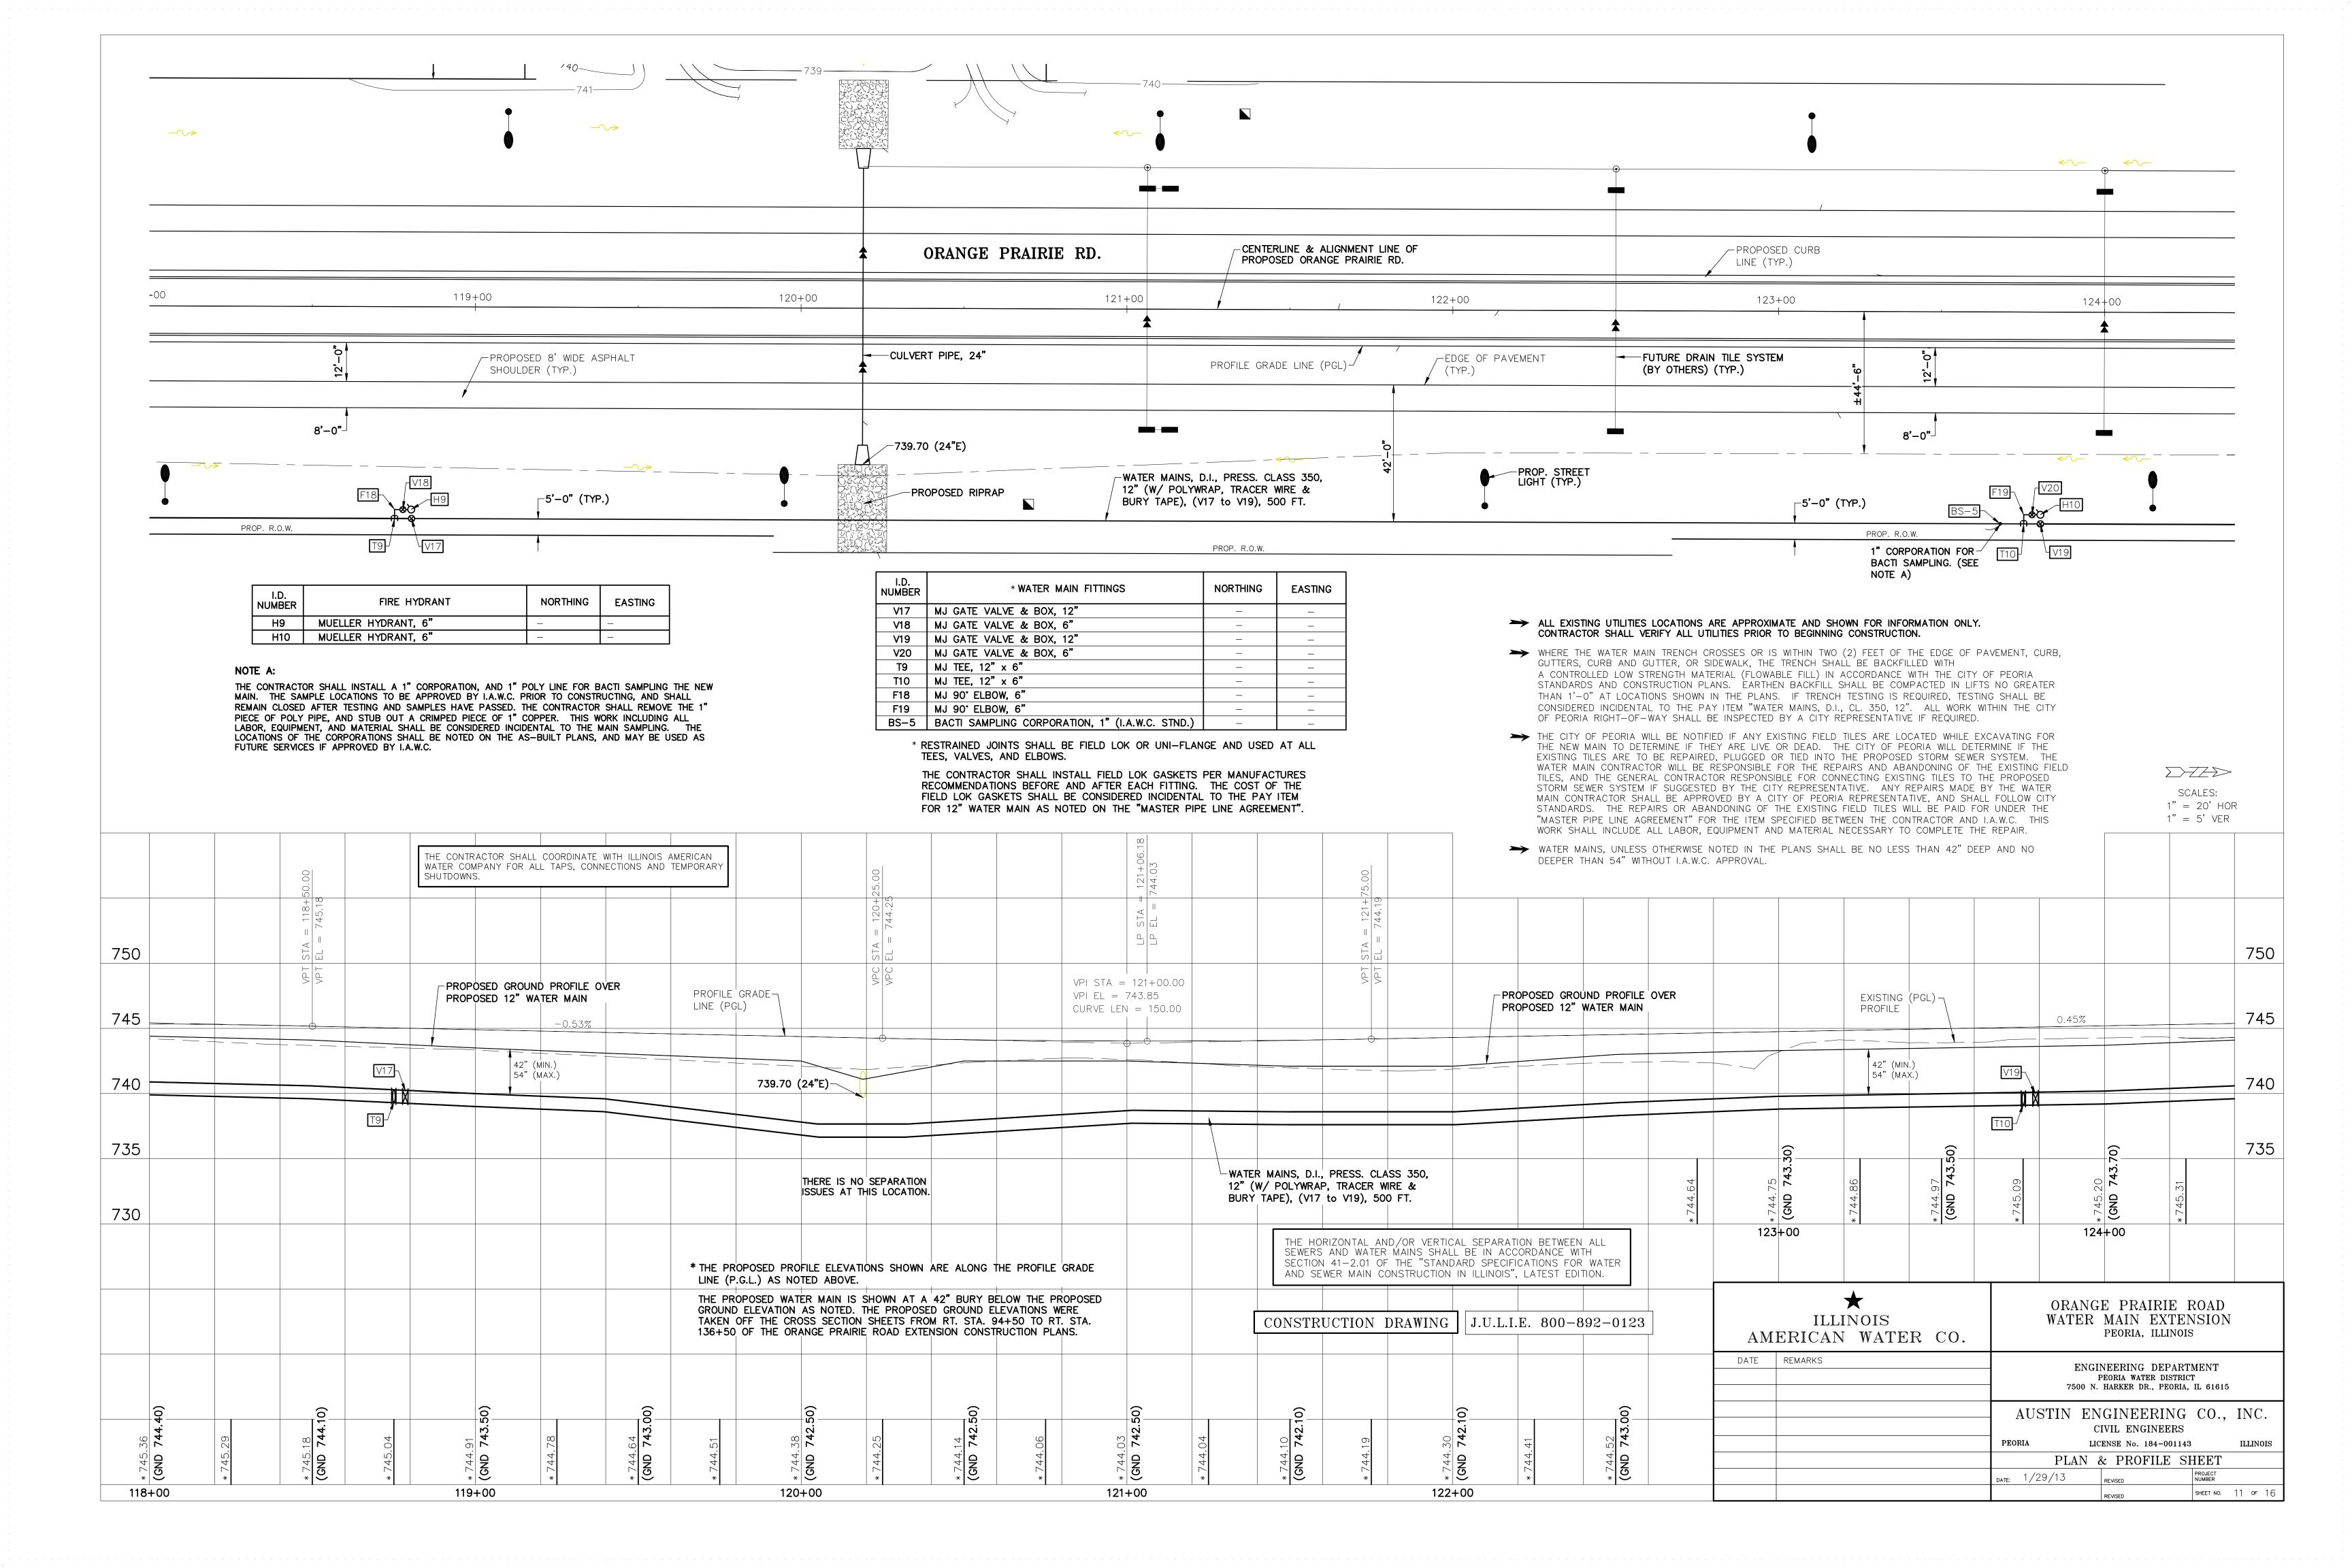

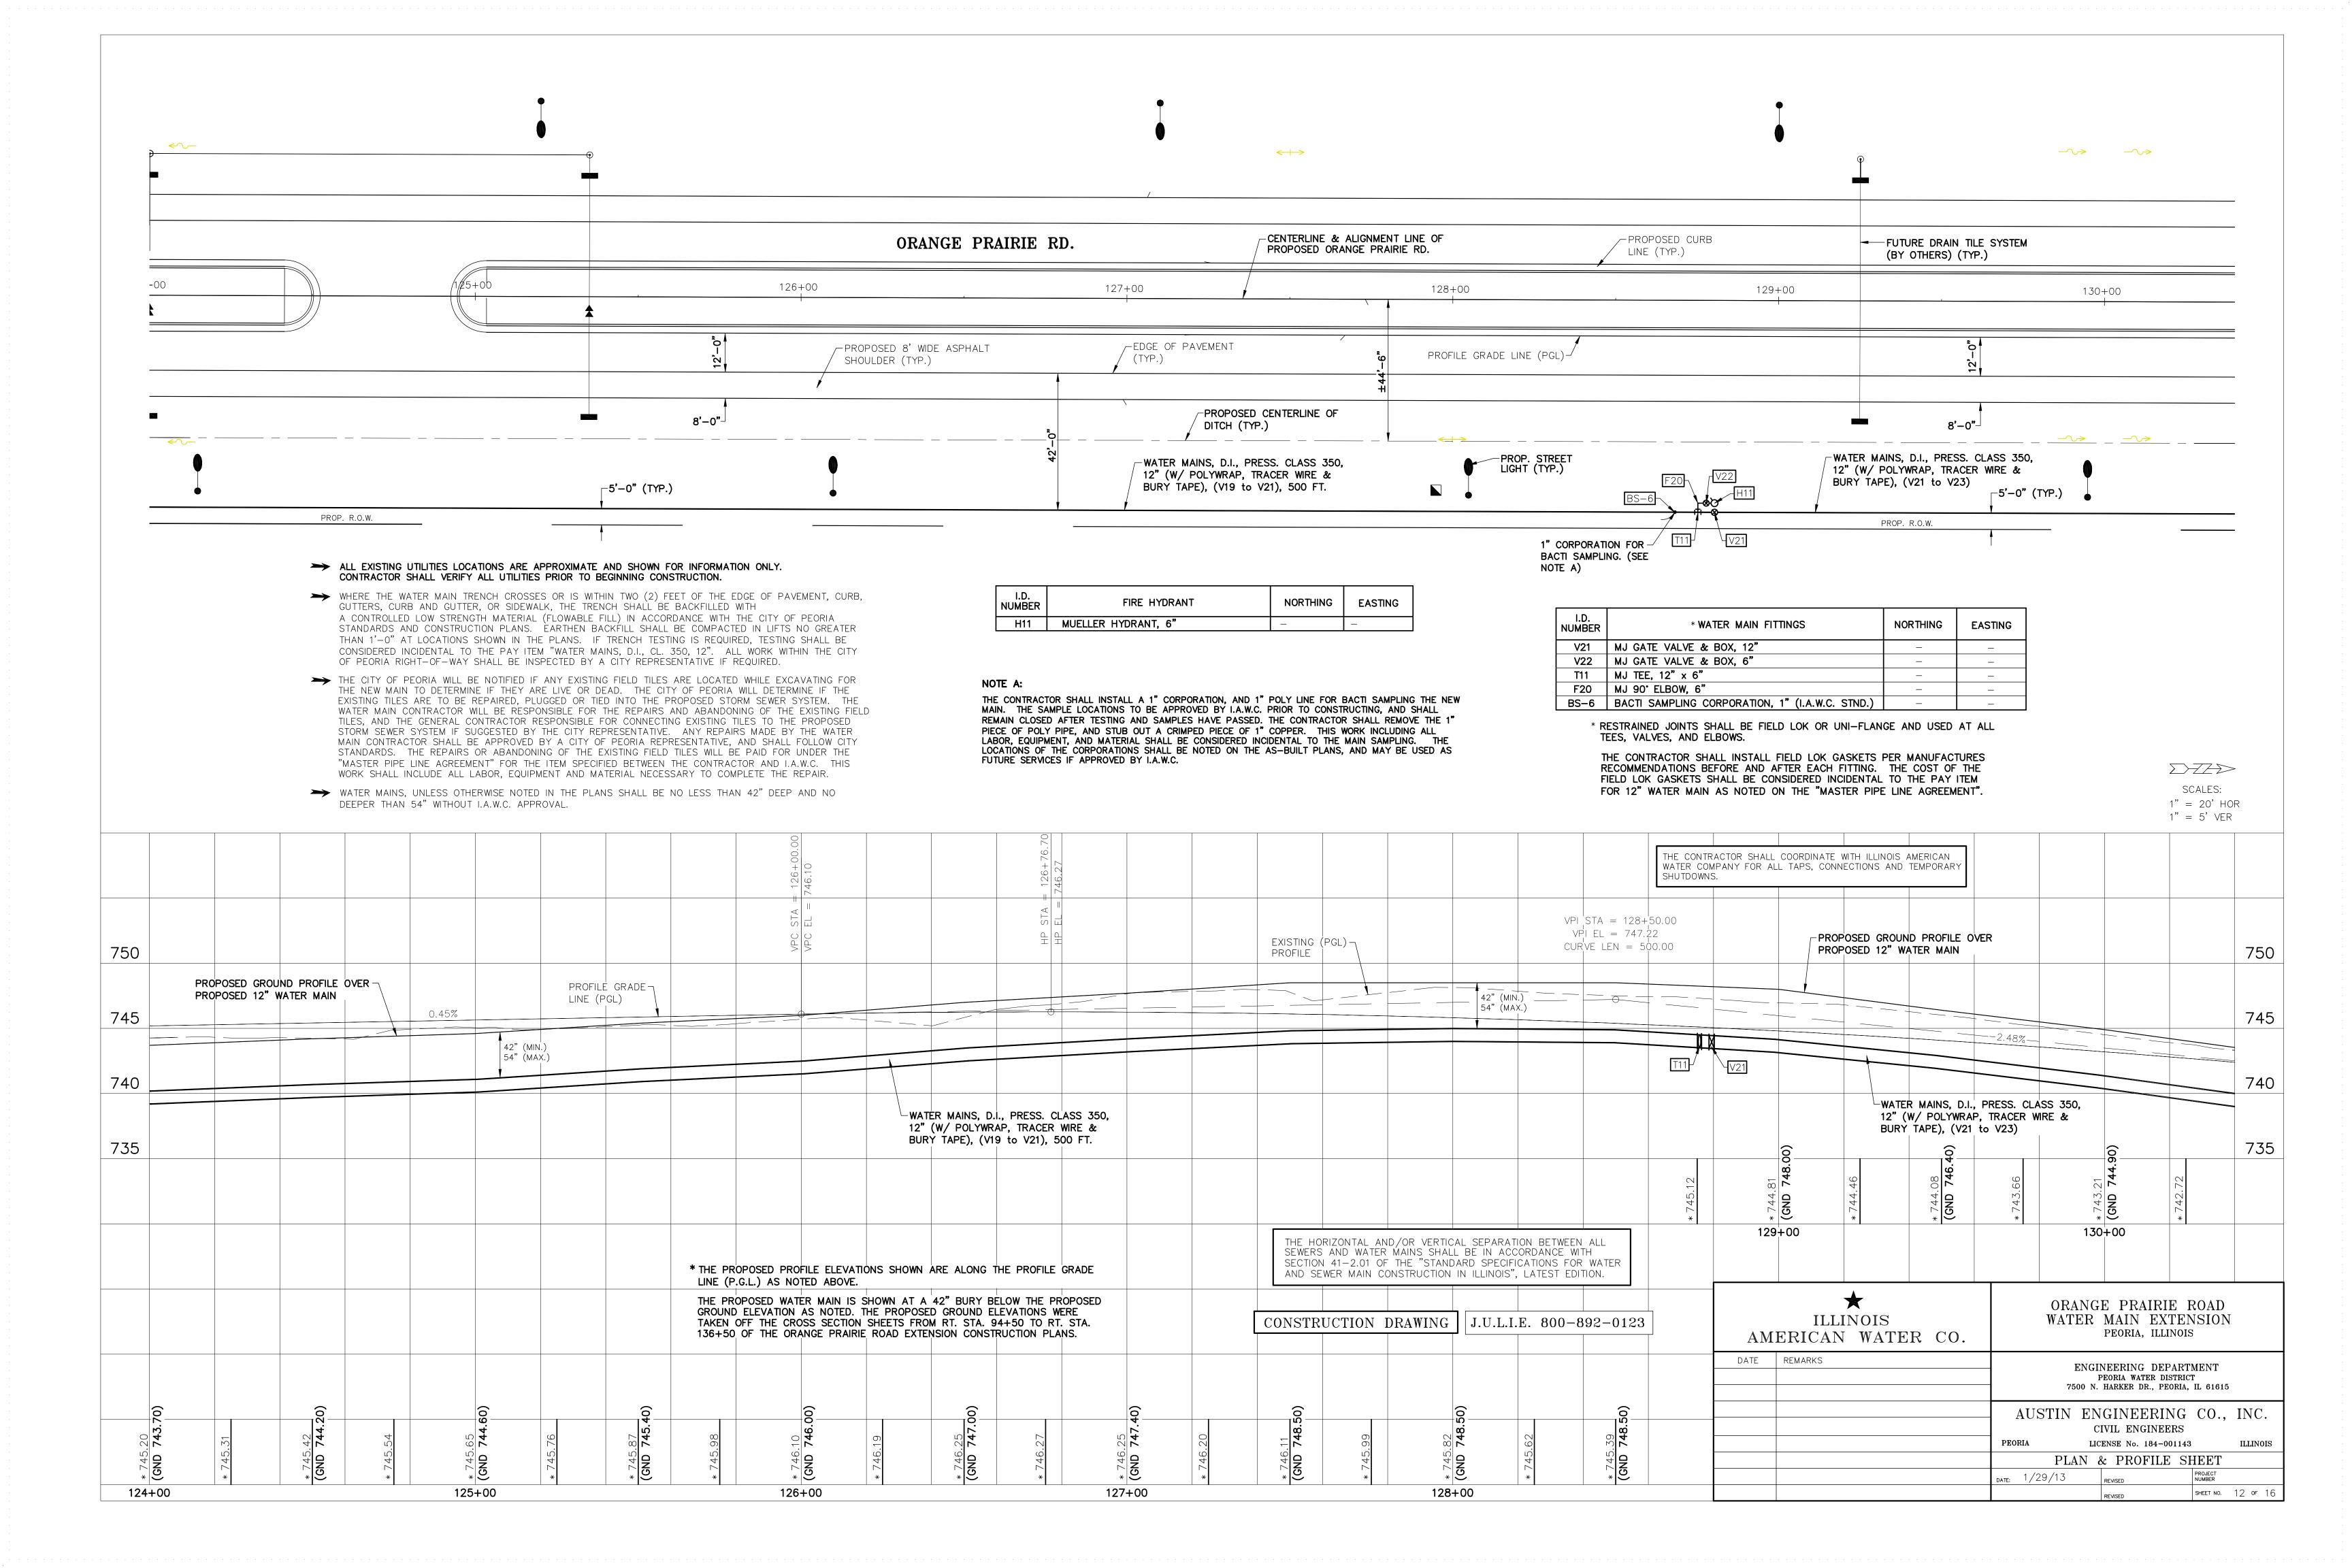

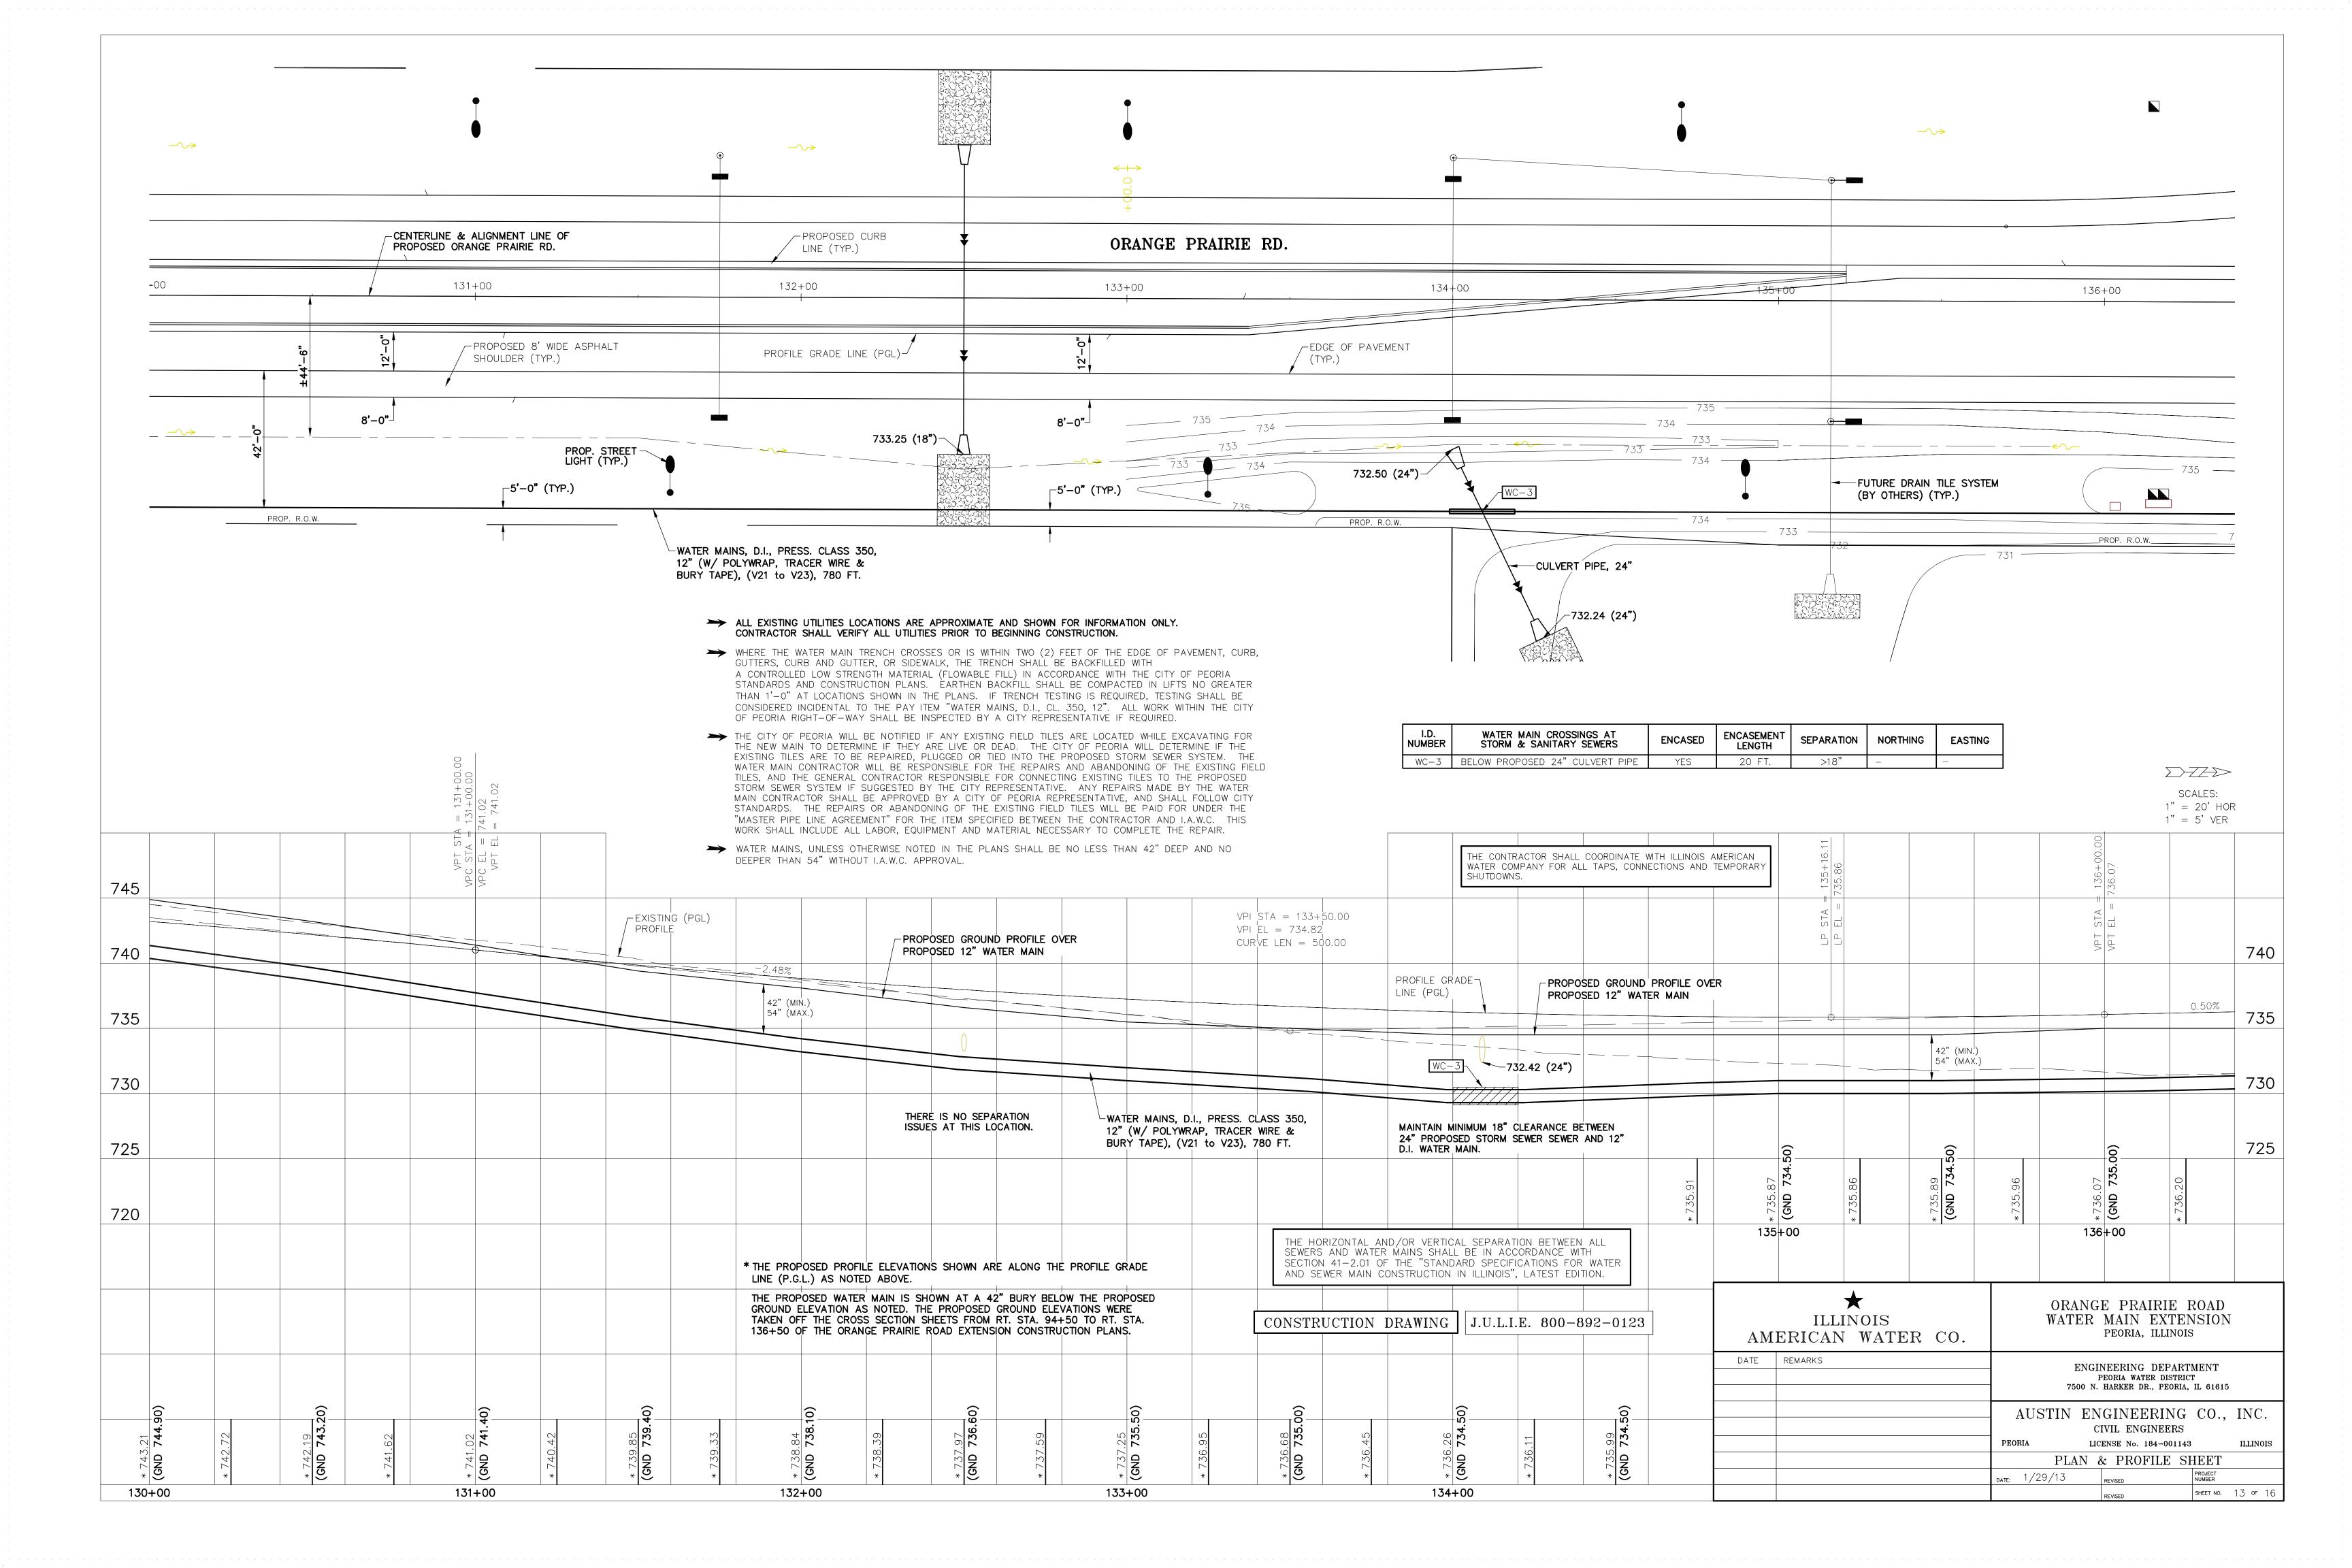

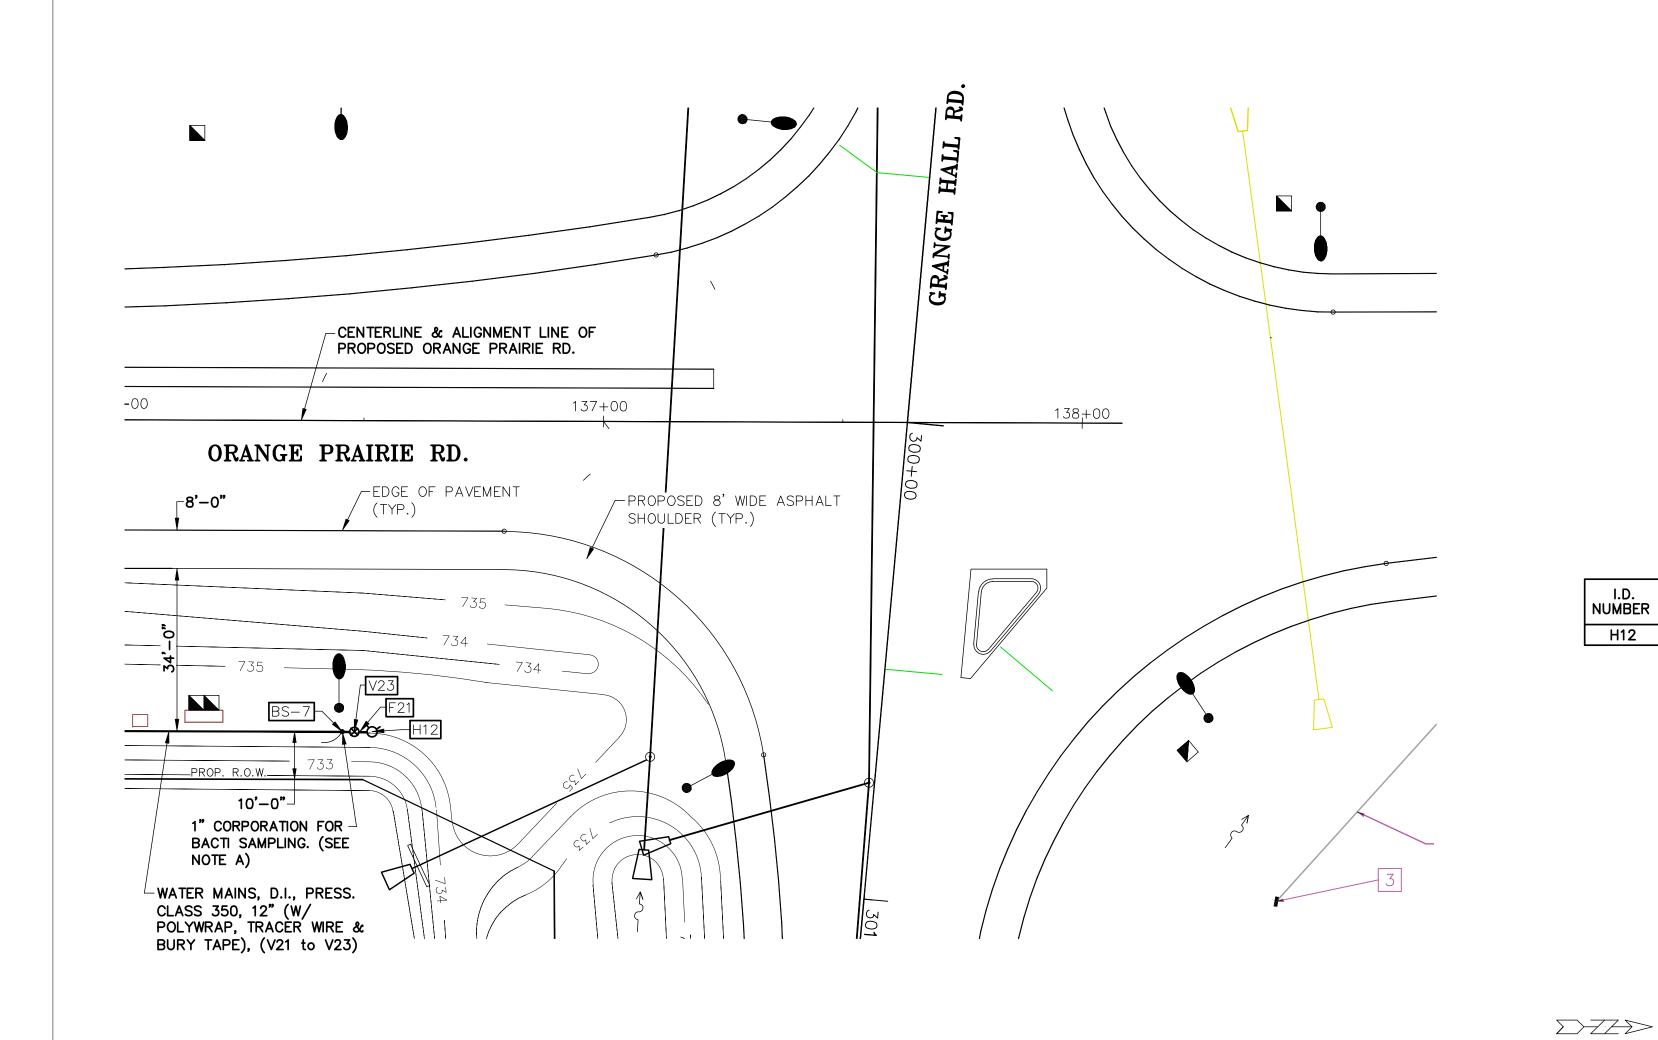

ALL EXISTING UTILITIES LOCATIONS ARE APPROXIMATE AND SHOWN FOR INFORMATION ONLY. CONTRACTOR SHALL VERIFY ALL UTILITIES PRIOR TO BEGINNING CONSTRUCTION.

WHERE THE WATER MAIN TRENCH CROSSES OR IS WITHIN TWO (2) FEET OF THE EDGE OF PAVEMENT, CURB, GUTTERS, CURB AND GUTTER, OR SIDEWALK, THE TRENCH SHALL BE BACKFILLED WITH A CONTROLLED LOW STRENGTH MATERIAL (FLOWABLE FILL) IN ACCORDANCE WITH THE CITY OF PEORIA STANDARDS AND CONSTRUCTION PLANS. EARTHEN BACKFILL SHALL BE COMPACTED IN LIFTS NO GREATER THAN 1'-0" AT LOCATIONS SHOWN IN THE PLANS. IF TRENCH TESTING IS REQUIRED, TESTING SHALL BE CONSIDERED INCIDENTAL TO THE PAY ITEM "WATER MAINS, D.I., CL. 350, 12". ALL WORK WITHIN THE CITY OF PEORIA RIGHT-OF-WAY SHALL BE INSPECTED BY A CITY REPRESENTATIVE IF REQUIRED.

THE CITY OF PEORIA WILL BE NOTIFIED IF ANY EXISTING FIELD TILES ARE LOCATED WHILE EXCAVATING FOR THE NEW MAIN TO DETERMINE IF THEY ARE LIVE OR DEAD. THE CITY OF PEORIA WILL DETERMINE IF THE EXISTING TILES ARE TO BE REPAIRED, PLUGGED OR TIED INTO THE PROPOSED STORM SEWER SYSTEM. THE WATER MAIN CONTRACTOR WILL BE RESPONSIBLE FOR THE REPAIRS AND ABANDONING OF THE EXISTING FIELD TILES, AND THE GENERAL CONTRACTOR RESPONSIBLE FOR CONNECTING EXISTING TILES TO THE PROPOSED STORM SEWER SYSTEM IF SUGGESTED BY THE CITY REPRESENTATIVE. ANY REPAIRS MADE BY THE WATER MAIN CONTRACTOR SHALL BE APPROVED BY A CITY OF PEORIA REPRESENTATIVE, AND SHALL FOLLOW CITY STANDARDS. THE REPAIRS OR ABANDONING OF THE EXISTING FIELD TILES WILL BE PAID FOR UNDER THE "MASTER PIPE LINE AGREEMENT" FOR THE ITEM SPECIFIED BETWEEN THE CONTRACTOR AND I.A.W.C. THIS WORK SHALL INCLUDE ALL LABOR, EQUIPMENT AND MATERIAL NECESSARY TO COMPLETE THE REPAIR.

WATER MAINS, UNLESS OTHERWISE NOTED IN THE PLANS SHALL BE NO LESS THAN 42" DEEP AND NO DEEPER THAN 54" WITHOUT I.A.W.C. APPROVAL.

I.D. NUMBER	FIRE HYDRANT	NORTHING	EASTING
H12	MUELLER HYDRANT, 6"	_	_

I.D. NUMBER			EASTING
V23	MJ GATE VALVE & BOX, 12"	_	_
F21	MJ REDUCER, 8" x 6"	_	_
BS-7	BACTI SAMPLING CORPORATION, 1" (I.A.W.C. STND.)	_	_


\* RESTRAINED JOINTS SHALL BE FIELD LOK OR UNI-FLANGE AND USED AT ALL TEES, VALVES, AND ELBOWS.


THE CONTRACTOR SHALL INSTALL FIELD LOK GASKETS PER MANUFACTURES RECOMMENDATIONS BEFORE AND AFTER EACH FITTING. THE COST OF THE FIELD LOK GASKETS SHALL BE CONSIDERED INCIDENTAL TO THE PAY ITEM FOR 12" WATER MAIN AS NOTED ON THE "MASTER PIPE LINE AGREEMENT".


#### NOTE A:


THE CONTRACTOR SHALL INSTALL A 1" CORPORATION, AND 1" POLY LINE FOR BACTI SAMPLING THE NEW MAIN. THE SAMPLE LOCATIONS TO BE APPROVED BY I.A.W.C. PRIOR TO CONSTRUCTING, AND SHALL REMAIN CLOSED AFTER TESTING AND SAMPLES HAVE PASSED. THE CONTRACTOR SHALL REMOVE THE 1" PIECE OF POLY PIPE, AND STUB OUT A CRIMPED PIECE OF 1" COPPER. THIS WORK INCLUDING ALL LABOR, EQUIPMENT, AND MATERIAL SHALL BE CONSIDERED INCIDENTAL TO THE MAIN SAMPLING. THE LOCATIONS OF THE CORPORATIONS SHALL BE NOTED ON THE AS—BUILT PLANS, AND MAY BE USED AS FUTURE SERVICES IF APPROVED BY I.A.W.C.


		SCALES: 1" = 20' HOR 1" = 5' VER						
	THE CONTRACTOR SHALL COORDINATE WITH ILLINOIS AMERICAN WATER COMPANY FOR ALL TAPS, CONNECTIONS AND TEMPORARY SHUTDOWNS.							
PROPOSED GROUND PROFILE OVER—PROPOSED 12" WATER MAIN	740 740							
PROFILE GRADE LINE (PGL)  0.50%	/35							
730 42" (MIN.) F21 V23 H12	PROFILE 730							
725  WATER MAINS, D.I., PRESS. CLASS 350, 12" (W/ POLYWRAP, TRACER WIRE & BURY TAPE), (V21 to V23)	725							
720	720							
	* THE PROPOSED PROFILE ELEVATIONS SHOWN ARE ALONG THE PROFILE GRADE LINE (P.G.L.) AS NOTED ABOVE.  THE PROPOSED WATER MAIN IS SHOWN AT A 42" BURY BELOW THE PROPOSED							
	THE PROPOSED WATER MAIN IS SHOWN AT A 42" BURY BELOW THE PROPOSED GROUND ELEVATION AS NOTED. THE PROPOSED GROUND ELEVATIONS WERE TAKEN OFF THE CROSS SECTION SHEETS FROM RT. STA. 94+50 TO RT. STA. 136+50 OF THE ORANGE PRAIRIE ROAD EXTENSION CONSTRUCTION PLANS.		THE HORIZONTAL AND SEWERS AND WATER SECTION 41-2.01 OF AND SEWER MAIN CO	D/OR VERTICAL SEPARATION BETWEEN MAINS SHALL BE IN ACCORDANCE WITH THE "STANDARD SPECIFICATIONS FOR NSTRUCTION IN ILLINOIS", LATEST EDITIONS	ALL 1 WATER On. A	★ ILLINOIS MERICAN WATER CO.	ORANGE PRAIRI WATER MAIN EX PEORIA, ILL	TENSION
			CONSTRUCTION D	DRAWING J.U.L.I.E. 800-89		REMARKS	ENGINEERING DE PEORIA WATER D 7500 N. HARKER DR., P	ISTRICT EORIA, IL 61615
*736.07 (GND 735.00 *736.20 (GND 735.00							PEORIA LICENSE No. 184-0  PLAN & PROFILI  DATE: 1/29/13  REVISED	ERS 001143 ILLINOIS
136+00							REVISED	SHEET NO. 14 OF 16

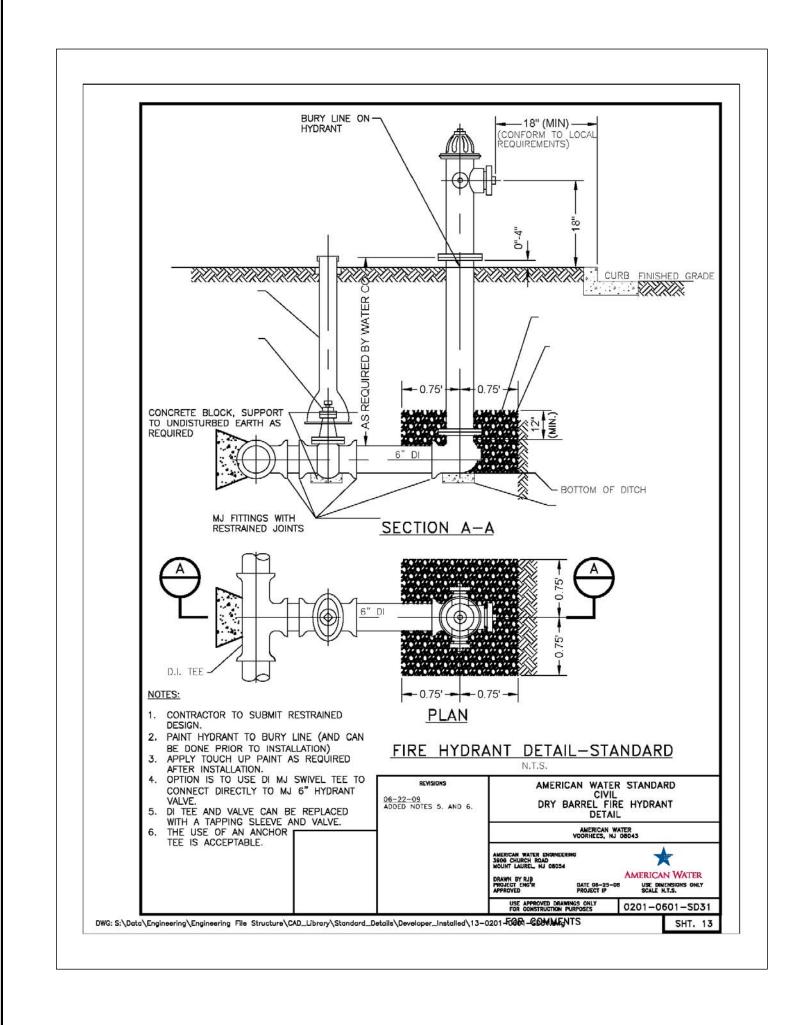


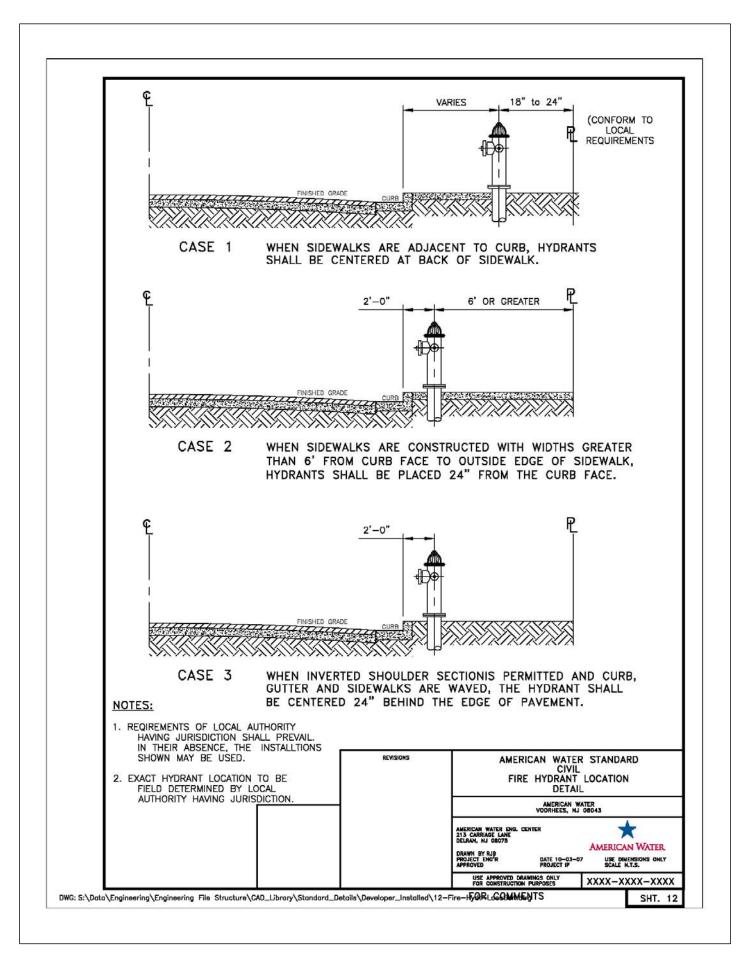


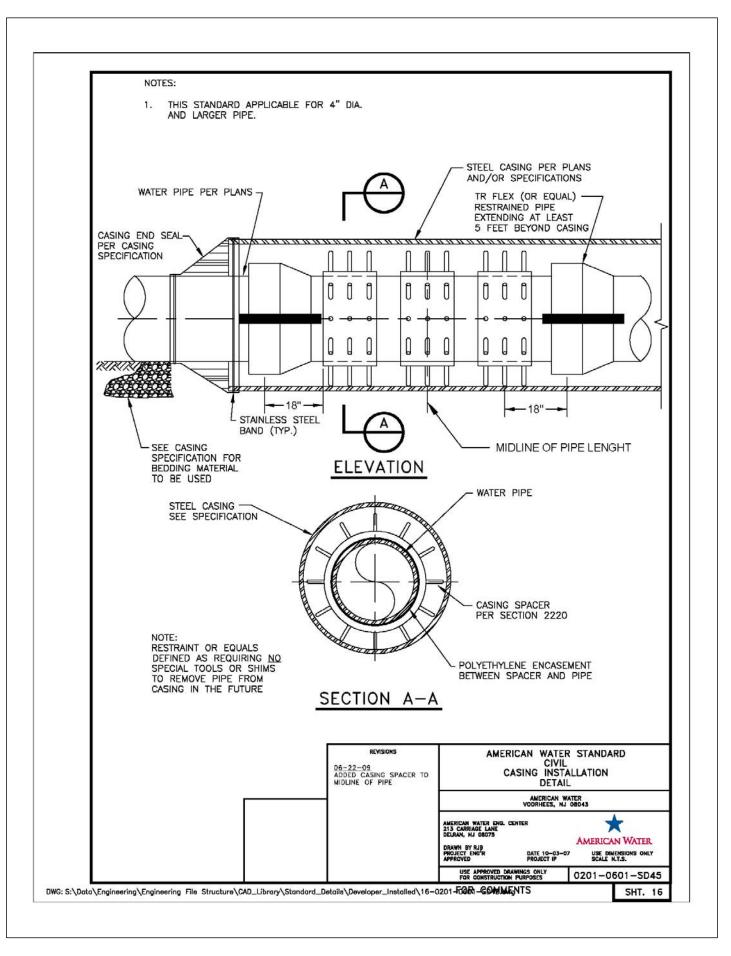

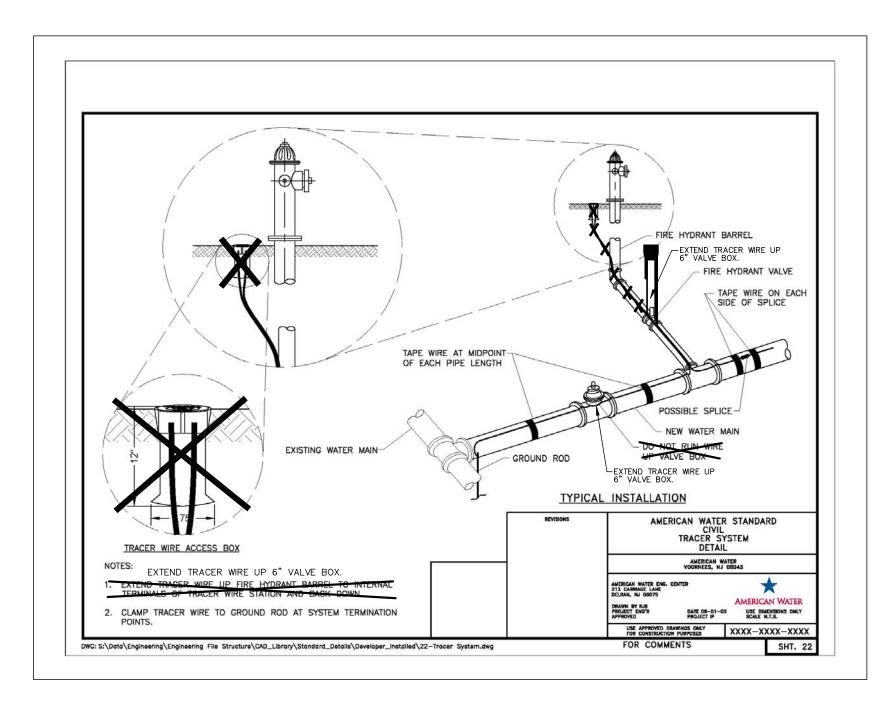


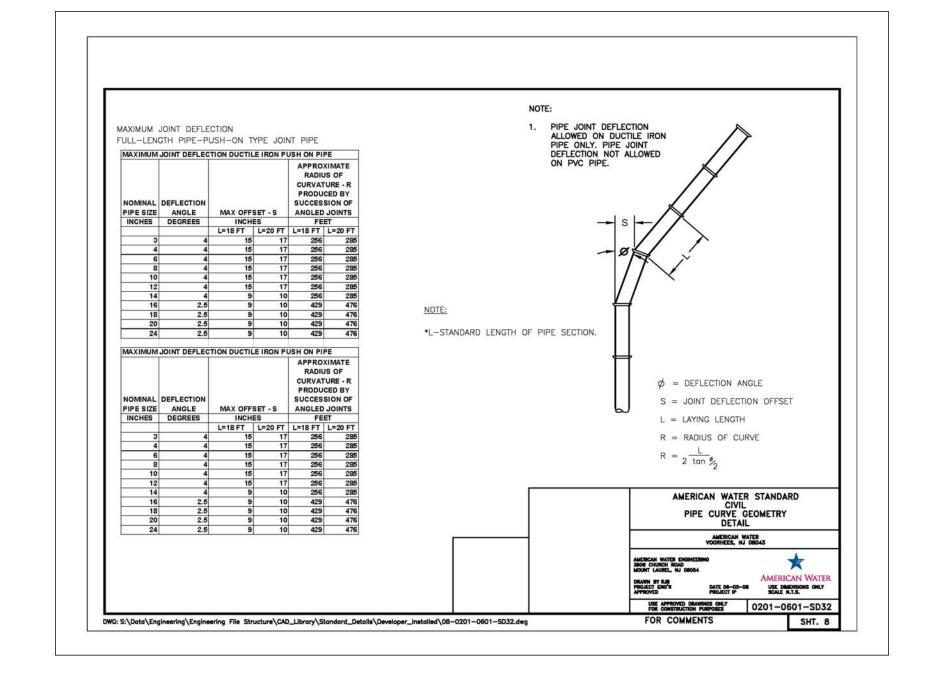


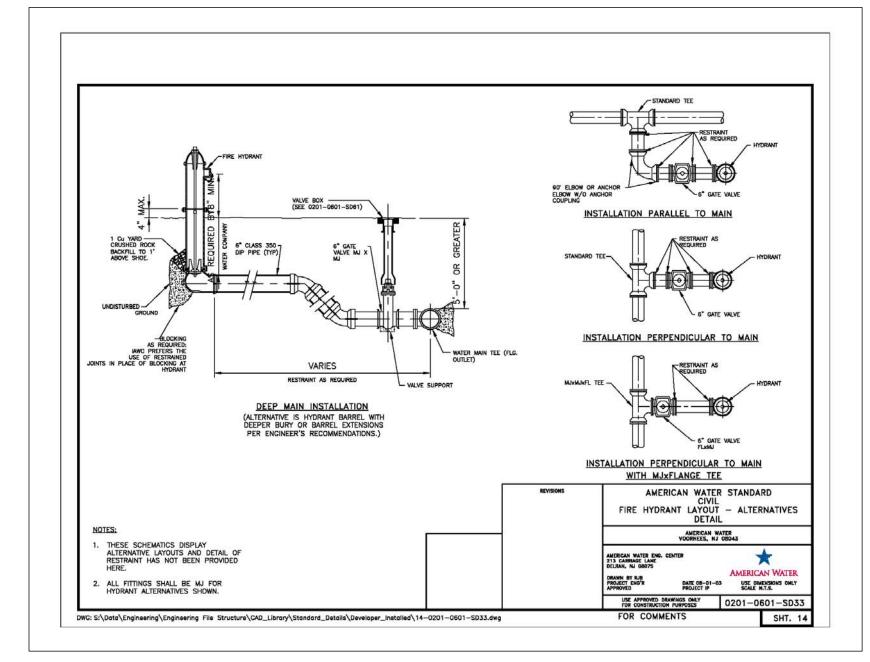


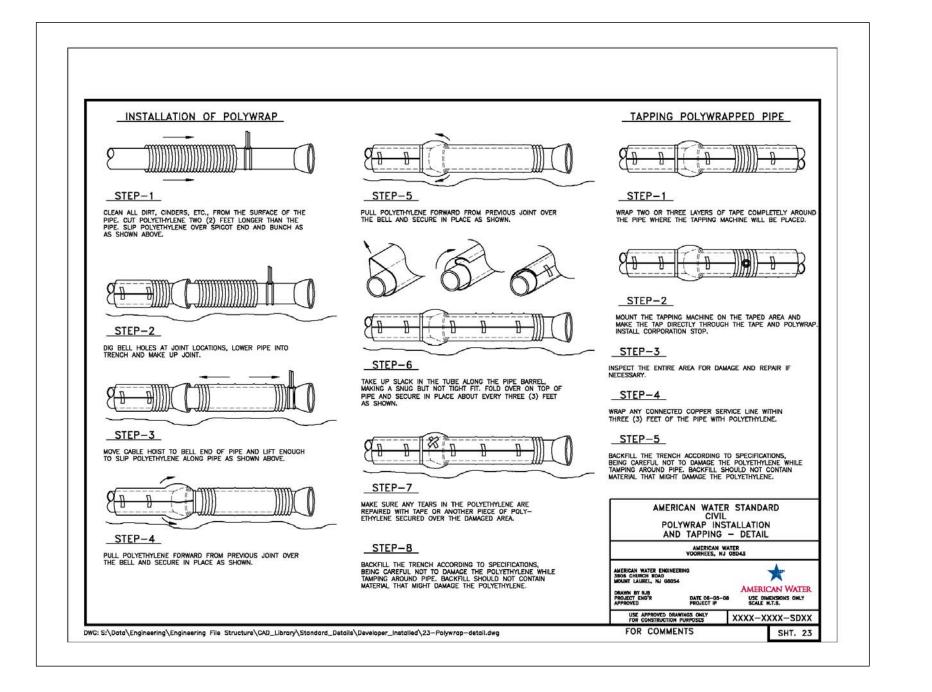



ILLINOIS AMERICAN WATER CO.	ORANGE PRAIRIE ROAD WATER MAIN EXTENSION PEORIA, ILLINOIS			
DATE REMARKS	ENGINEERING DEPARTMENT PEORIA WATER DISTRICT 7500 N. HARKER DR., PEORIA, IL 61615			
	AUSTIN ENGINEERING CO., INC. CIVIL ENGINEERS PEORIA LICENSE No. 184-001143 ILLINOIS			
	DETAIL SHEET			
	DATE: 1/29/13 REVISED PROJECT NUMBER  SHEET NO. 15 OF 16			

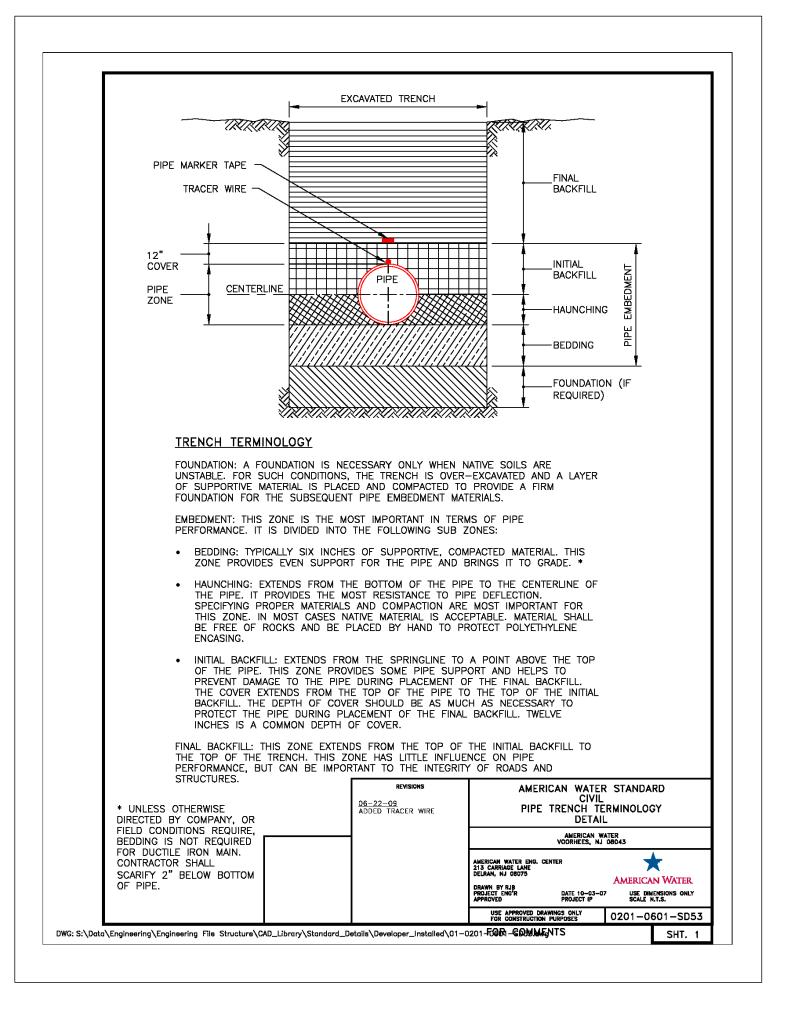


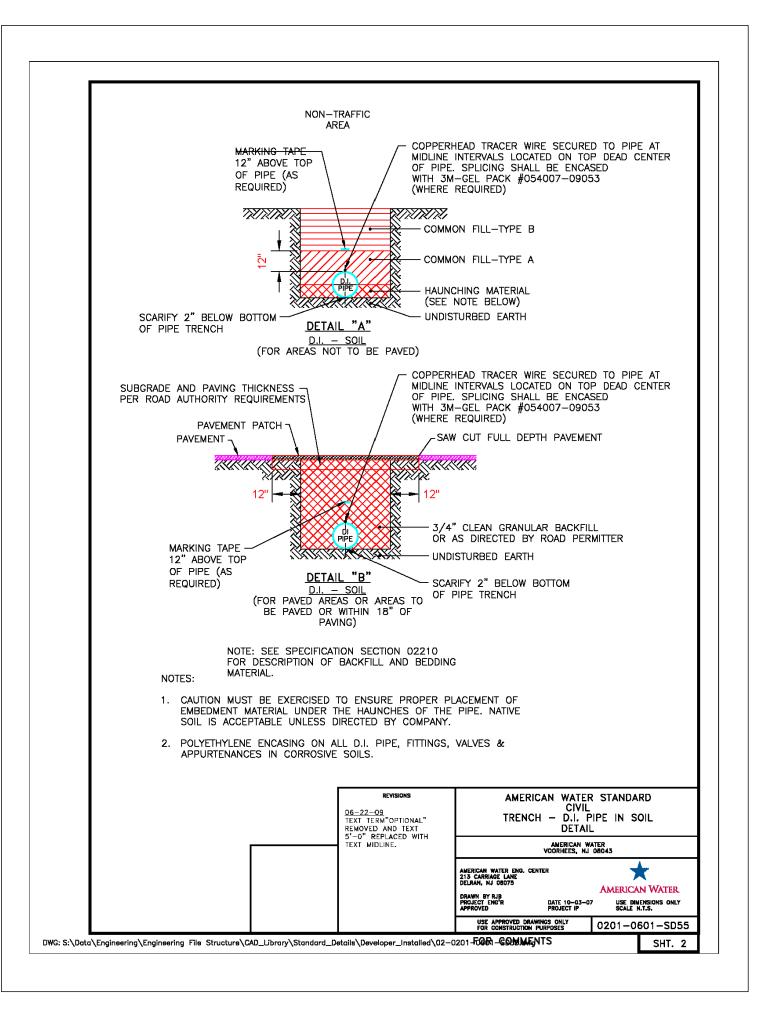


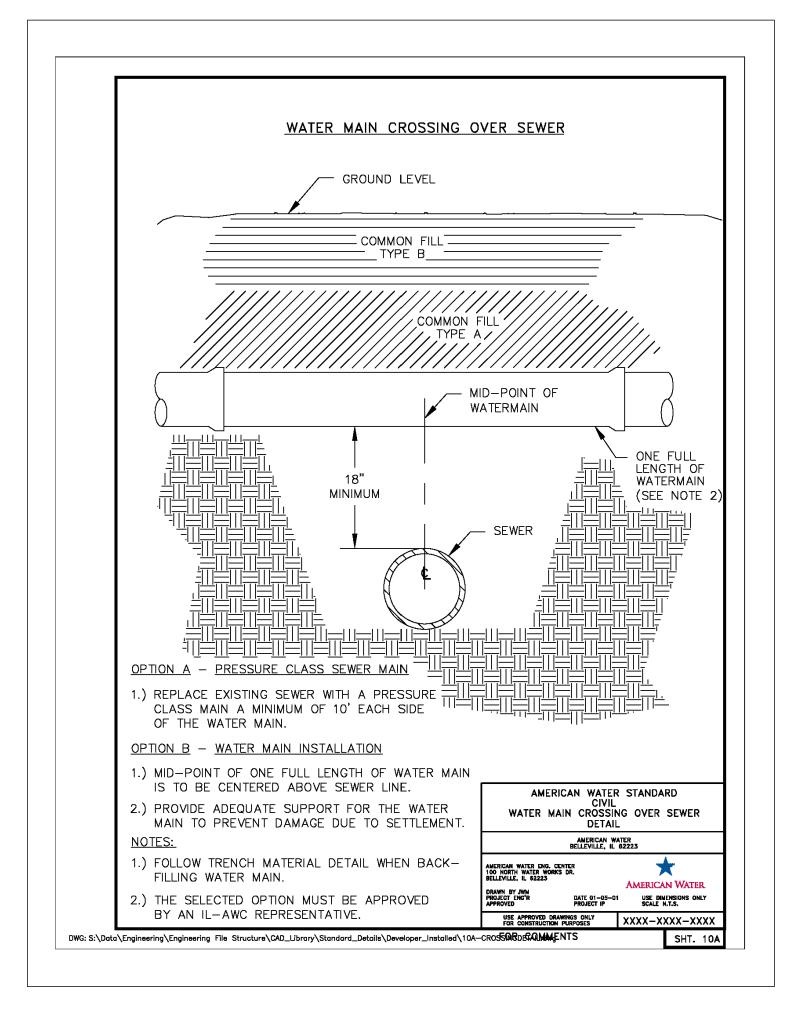


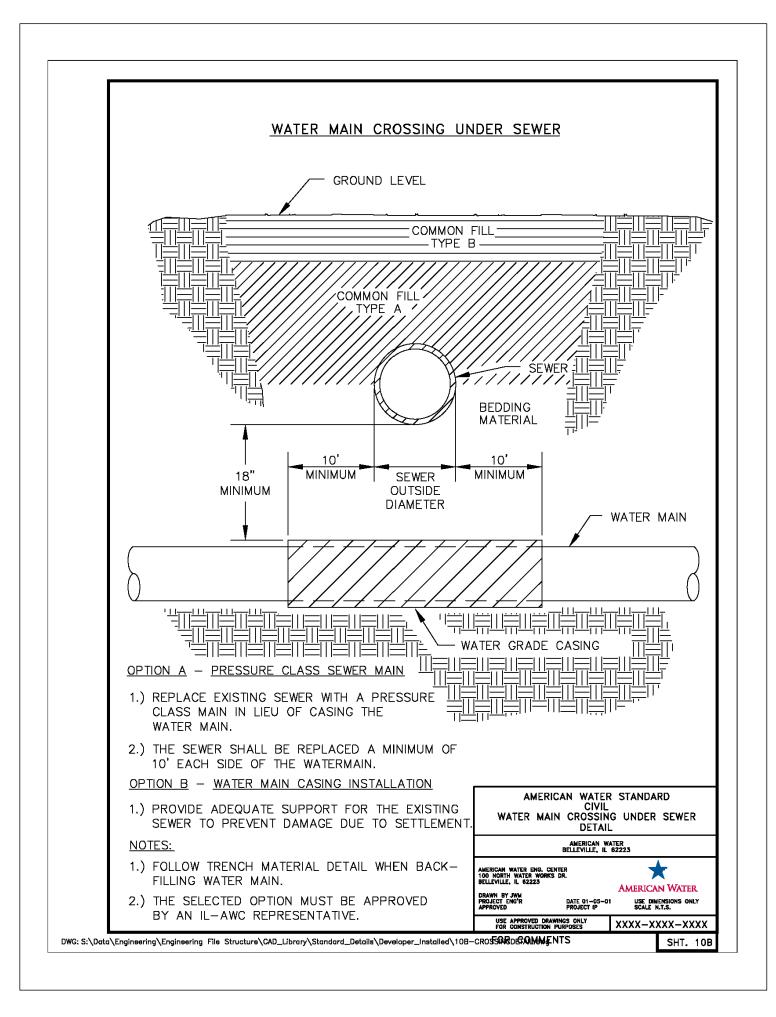

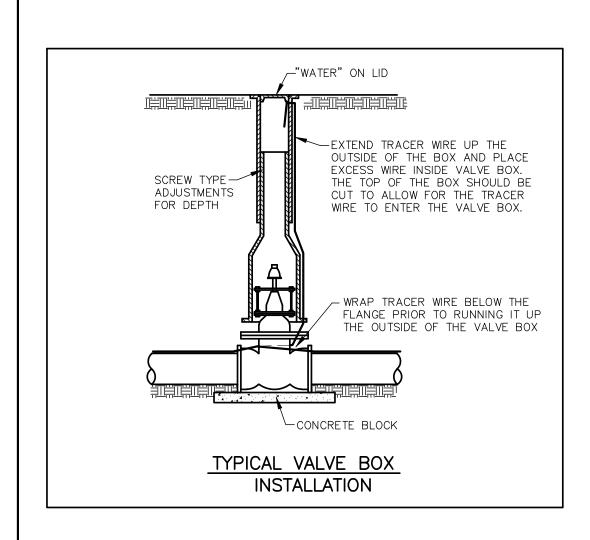

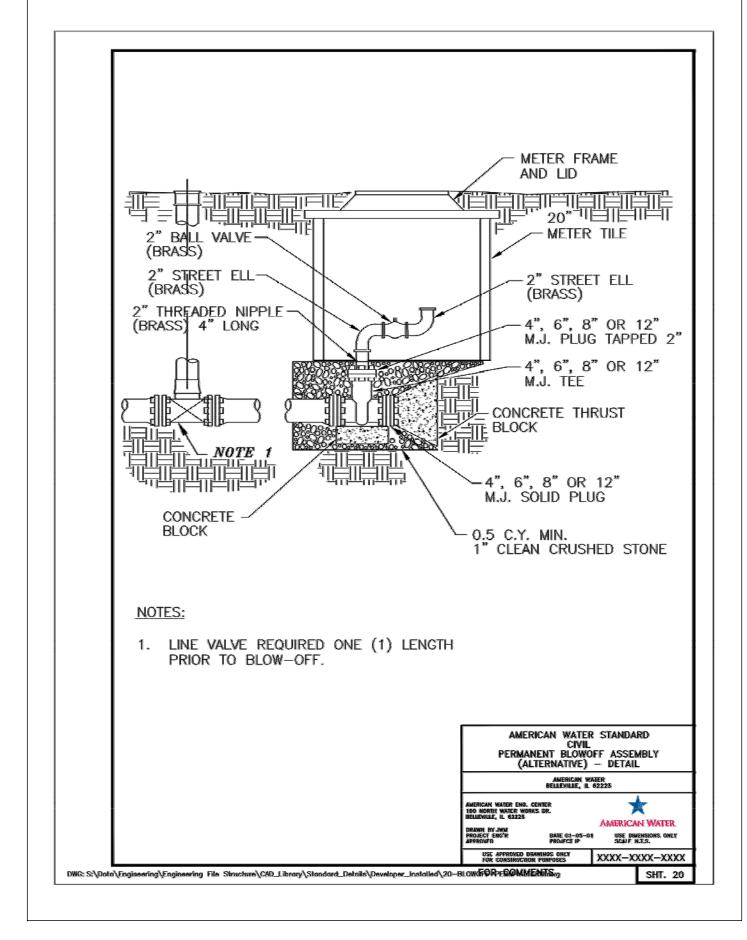

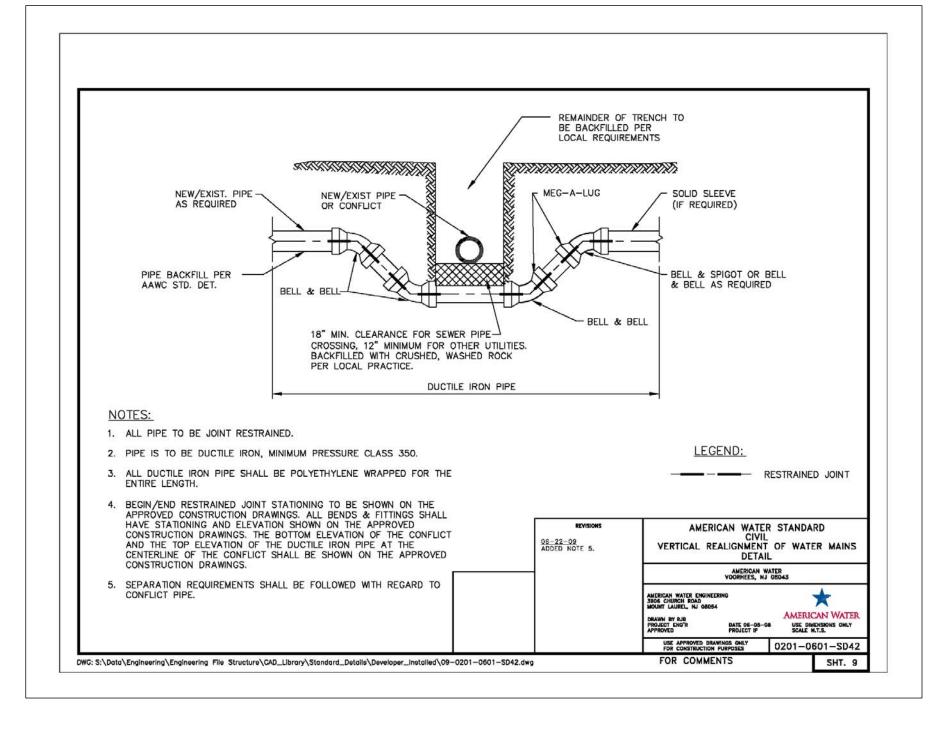

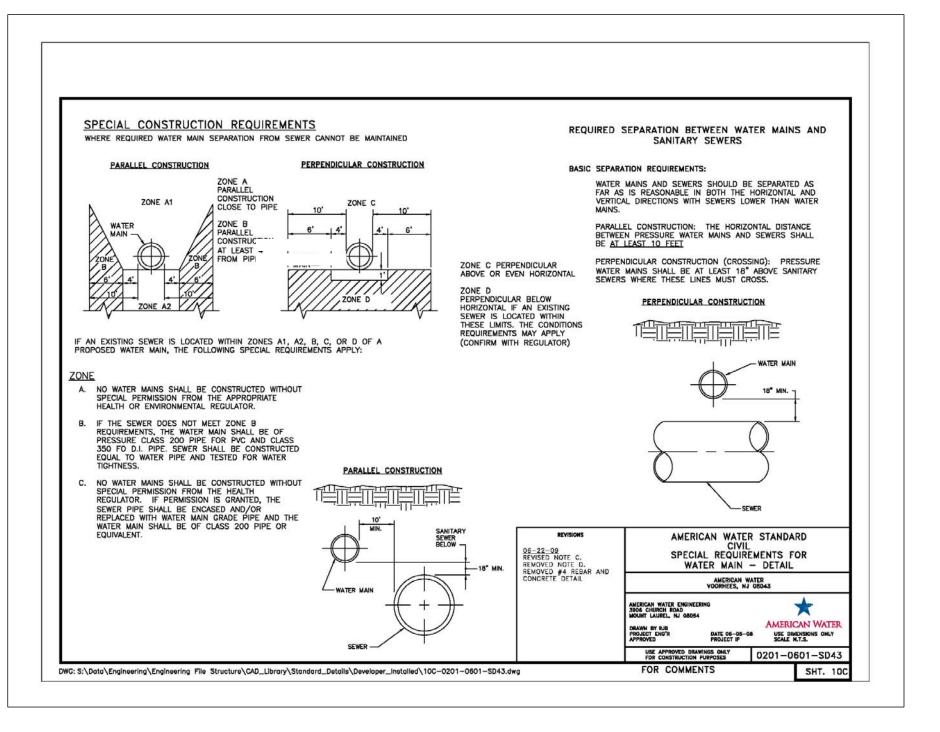

A	★ ILLINOIS MERICAN WATER CO.	ORANGE PRAIRIE ROAD WATER MAIN EXTENSION PEORIA, ILLINOIS		SION	
DATE	REMARKS	ENGINEERING DEPARTMENT PEORIA WATER DISTRICT 7500 N. HARKER DR., PEORIA, IL 61615			
		AUSTIN ENGINEERING CO., civil engineers		5	
		PEORIA LICENSE No. 184-001143 ILLINOIS			
		DETAIL SHEET			
		DATE: 1/29/13	REVISED	PROJECT NUMBER	
		SCALE:	REVISED	SHEET NO. 16 OF 16	